

PUBLIC NOTICE TOWN OF WINTER PARK PLANNING COMMISSION (MAJOR SITE PLAN) PLANNING COMMISSION AND TOWN COUNCIL (FINAL PLAT)

Applicant: Jeffrey Vogel of Vogel and Associates
Property Owner: Fraser River Development Company

Case Number: PLN24-025 (Major Site Plan) and PLN24-006 (Final Plat)

Physical Address of Properties for Which the Major Site Plan Approval and Final Plat Approval is Requested: 76 Wanderer's

Way and three (3) unaddressed parcels

Legal Description of Properties for Which the Major Site Plan Approval and Final Plat Approval is Requested: See "Exhibit A"

Description of Final Plat Request: Request to plat ten (10) parcels consisting of seven (7) lots and three (3) outlots. **Description of Major Site Plan Request:** Request to build seven (7) townhouse dwelling units.

Applicable Provision(s) of the Unified Development Code:

§ 5-E-1, Site Plan § 5-D-5, Final Plat

The Planning Commission will review the Major Site Plan and render a decision under § 5-E-1 of the UDC. The Planning Commission and Town Council will review the Final Plat and render a decision under § 5-D-5 of the UDC.

Additional information is available at this link: https://wpgov.com/current-development-projects/


A Public Hearing at Winter Park Town Hall, 50 Vasquez Road and online via Zoom is scheduled for:

Planning Commission, Tuesday, April 23, 2024, at 8:00 A.M. (Major Site Plan and Final Plat); and Town Council, Tuesday, May 7, 2024, at 5:30 P.M. (Final Plat)

Members of the public wishing to make comment regarding the major site plan and final plat may do so at the scheduled meeting, or write to James Shockey, Community Development Director, Town of Winter Park, P.O. Box 3327, Winter Park, CO 80482, or ishockey@wpgov.com. For comments to be included within the digital packet, they must be submitted by 5:00 P.M. on the Wednesday before the hearing.

The Zoom link will be made available in the full agenda, which will be published by end of day the Friday before the hearing at https://wpgov.com/our-government/agendas-minutes/

The meeting will be broadcast via Zoom and public comment can be made by those attending. If there are technical difficulties with Zoom, public comment via Zoom will not be available and the meeting will continue in person.

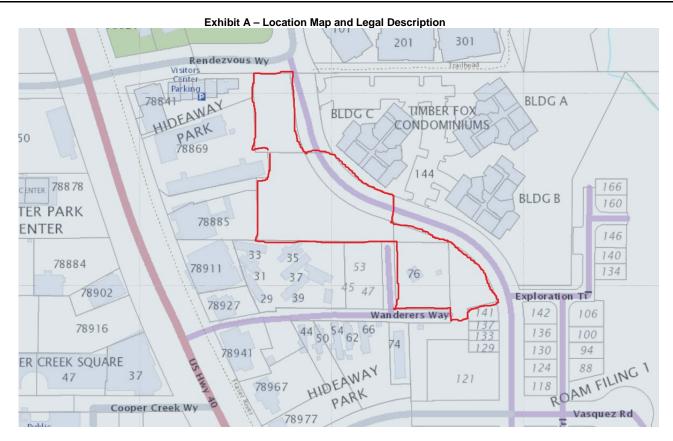

PARCELS B AND C AND TRACTS E AND F, ROAM FILING NO. 1, A SUBDIVISION PLAT RECORDED AT RECEPTION NO. 2019008310 IN THE RECORDS OF GRAND COUNTY CLERK AND RECORDER'S OFFICE, LYING IN SECTION 33, TOWNSHIP 1 SOUTH, RANGE 75 WEST OF THE SIXTH PRINCIPAL MERIDIAN, TOWN OF WINTER PARK, COUNTY OF GRAND, STATE OF COLORADO.



August 17, 2023

Mr. James Shockey, Community Development Director Ms. Shelia Booth, Contract Planner 50 Vasquez Road P.O. Box 3327 Winter Park, Colorado 80482

Re: Roam Filing No. 4 Preliminary Plat, Major Site Plan, & Final Development Plan Amendment.

Dear James,

I am pleased to submit on behalf of the Fraser River Development Company, the Roam Filing 4 Major Site Plan Submittal. Per the pre-application, and Final Development Plan and Preliminary Plat is being processed concurrently with the site plan. Outlined below is a summary of the project and the respective documents included for this submittal.

This project is located at the Northwest corner of Roam, between Rendezvous Way and Wanders Way, just West of Ski Idlewild Road. The Major Site Planning Application is for 7 Residential dwelling units/lots. A future phase will include 5 additional townhome lots. Each individual townhome includes a 2-car garage and pedestrian entry.

Roam Filing 4 is located within Planning Area 1 and the north side of Planning Area 3. As illustrated on the attached Final Development Plan (FDP) Amendment, the intent is to incorporate into the FDP and Planning Area 1 an outparcel that was purchased from the Town of Winter Park. A second parcel is also being incorporated into the FDP and Planning Area 3.

Access to the lots will be provided via an access drive off Ski Idlewild Road to the North and an access drive off Wanders Way to the South. Parking requirements for all 7 residential units have been achieved utilizing attached garages. Proposed pedestrian circulation connects to existing sidewalks along Ski Idlewild Road and Wanders Way. These walks will connect to the proposed Roam and downtown pedestrian system.

There is (1) 2-Plex building and (1) 5-Plex building. Each townhome unit is a 3-bedroom unit, including a 2-car garage, 2^{nd} floor patio and roof top deck.

A. Project Name: Roam Filing No. 4 Preliminary Plat and Site Plan Application. Roam Final Development Plan, Amendment No. 3.

B. Street Address:

A RESUBDIVISION OF THE FINAL PLAT OF ROAM FILING NO. 1, AMENDED LOT 1, BLOCK 1 OF ROAM FILING NO. 1, PARCEL A AND LOT 1, BLOCK 1 HIDEAWAY PARK, SUBDIVISION EXEMPTION PLAT, LOTS 16 AND 17, A PART OF THE SOUTH HALF OF THE NORTHEAST QUARTER OF SECTION 33, TOWNSHIP 1 SOUTH, RANGE 75 WEST OF THE SIXTH PRINCIPAL MERIDIAN, TOWN OF WINTER PARK, COUNTY OF GRAND, STATE OF COLORADO.

C. Project Team:

Builder/Owner: Fraser River Development Company

1500 Wynkoop St, Suite 200

Denver, CO. 80202

Applicant: Jeff Vogel

Vogel & Associates

475 W. 12th Ave., Suite E

Denver, CO. 80204 (303) 893-4288

Architect: Michael Noda

Neo Studio

3560 Walnut St., Unit A Denver, CO. 80205 (303) 758-3800

Civil Engineer: Topknot Engineering (TKE)

Tony Krempin, Tony DePlata

998 County Road 553 (POB 2225)

Granby, CO. 80446 (970) 281-5280

D. Legal Description:

A RESUBDIVISION OF THE FINAL PLAT OF ROAM FILING NO. 1, AMENDED LOT 1, BLOCK 1 OF ROAM FILING NO. 1, PARCEL A AND LOT 1, BLOCK 1 HIDEAWAY PARK, SUBDIVISION EXEMPTION PLAT, LOTS 16 AND 17, A PART OF THE SOUTH HALF OF THE NORTHEAST QUARTER OF SECTION 33, TOWNSHIP 1 SOUTH, RANGE 75 WEST OF THE SIXTH PRINCIPAL MERIDIAN, TOWN OF WINTER PARK, COUNTY OF GRAND, STATE OF COLORADO.

- **E. Zoning District:** Existing Zoning ROAM FDP (D-C). Parcels that are being included in the FDP are currently zoned D-C. The intent is for these parcels to include FDP D-C zoning.
- **F. Lot Size:** 76,875 Sf (1.76 Ac)
- G. Site Plan Proposed Uses: Residential
- **H. FDP Proposed Uses:** The parcels to be included in the FDP shall include a Mixed-Use classification. See Roam FDP for permitted land uses.
- I. Site Plan Number of dwelling units: 7 dwelling units

J. Final Development Plan Proposed Density

Planning Area 1

Planning Area 1 has been enlarged to include approximately 10.3 acres. Permitted density for Planning Area 1 will continue to be 25 DU/AC.

Planning Area 3

Planning Area 3 has being updated to include approximately 1.2 acres. Permitted density for Planning Area 3 will continue to be 28 DU/AC.

The total density permitted in the Final Development Plan will remain as originally approved (see enclosed density chart). This will include 1,076 dwelling units, 400 lodging units and 72,000 sqft. of commercial.

- **K. Site Plan Number of bedrooms per dwelling unit:** 7 (3-Bedroom) townhome units each.
- L. Site Plan Size of residential and nonresidential space:

Residential Space:

24' Middle Unit: 2,793 SF 24' End Unit: 2,942 SF

Non-residential space: N/A

M. Site Plan Number of proposed off-street parking spaces: All parking requirements for residential is met through individual parking garages proposed for each townhome unit. Each garage is a 2-car garage and will meet all parking requirements. There is no on-street parking proposed for this development.

^{*}Totals include Garage/Flex Space and Roof (landing and exterior deck)

N. Transportation Impact Study

Please see the Roam master transportation impact study that has been approved and on file. The transportation plan includes the land use and density that is proposed with this preliminary plat. The original density approved with the FDP is being maintained with no additional trips proposed.

O. Filing 4 Estimated Construction Schedule:

Estimated Construction Start: October 2023 Estimated Construction Completion: Fall 2025

P. Forest Management Plan

The site does not contain any existing trees. Dead trees were removed as part of the Filing 1 forest management plan.

Upon your review, we will be available to meet and provide additional information as required.

Sincerely,

Vogel & Associates, LLC

Jeffery Vogel, AICP


Principal





LOTS 1,2,3,4,5 LOTS 6,7



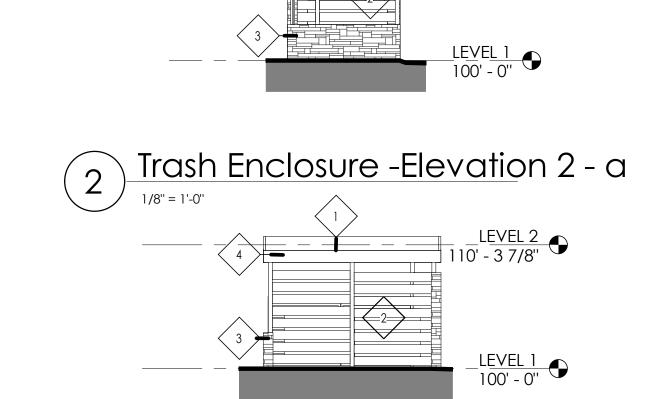


<u>Trash Enclosure - Elevation</u> 1 - a

110' - 37/8"

LEVEL 1 100' - 0''

LEVEL 2 110' - 3 7/8"

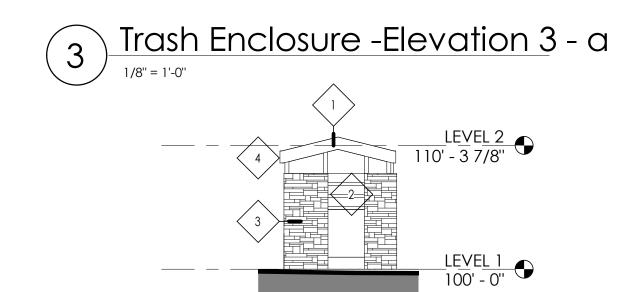



LOTS 3, 4, 5



FINISH: Black WIDTH: 4.5" HEIGHT: 15.5" GLASS: Clear Seedy LIGHT SOURCE: LED Lamp LED NAME: GU10LED-3K VOLTAGE: 120v LED COLOR TEMP: 3000 LED LUMENS: 500

HINKLEY - 1326 BK-LL Shelter Black Outdoor Wall Cylinder Light with Dark Sky

EXTERIOR SCONCE - A



SILO 13590AZ-LL

Small Down Light Wall Mount Lantern

FINISH: Architectural Bronze WIDTH: 4.5" HEIGHT: 8" GLASS: Etched LIGHT SOURCE: LED Lamp LED NAME: GU10LED-3K VOLTAGE: 120v LED COLOR TEMP: 3000 LED LUMENS: 500

FEATURES

- Suitable for use in wet (outdoor direct rain or sprinkler) locations as defined by NEC and CEC. Meets United States UL Underwriters Laboratories & CSA Canadian Standards Association Product Safety Standards
- Fixture is Dark Sky compliant and engineered to minimize light glare upward into the night
- Meets California Energy Commission Title regulations/JA8 when using the included LED
- 2 year finish warranty
- LED Bulbs carry a 3-year limited warranty
- Bold lines and a clean, minimalist style complement contemporary architecture
- Striking black finish enhances design

FEATURES

- Mounting hardware is hidden on the backplate to ensure a clean silhouette
- · Suitable for use in wet (outdoor direct rain or sprinkler) locations as defined by NEC and CEC. Meets United States UL Underwriters Laboratories & CSA Canadian Standards Association Product Safety Standards
- Fixture is Dark Sky compliant and engineered to minimize light glare upward into the night
- Meets California Energy Commission Title regulations/JA8 when using the included LED
- · LED Bulbs carry a 3-year limited warranty
- 5 year finish warranty
- The Coastal Elements Collection offers versatile designs, constructed of composite materials and coated with anti-fading finishes, for maximum durability in harsh climates.
- Bold lines and a clean, minimalist style complement contemporary architecture
- Bold and robust dark bronze finish


OCULUX LED WAC LIGHTING OCULUX LED RECESSED LIGHTING **Features** Product Type Standard Kit Trim Shape Circle Trim Style Open Dry, Damp or Wet Location Listed Damp What is Dry, Damp or Wet Location Listed? This indicates whether the fixture is safe to use in dry locations, damp locations (moist environments), or wet locations (direct exposure to water). Air-Tight Yes Primary Material Metal Primary Material Details Aluminum Yes Dimmable Integrated LED What is Integrated LED? This indicates that an LED light is built into the fixture. Integrated LED lights are more energy efficient and can last up to 50,000 hours. They cannot be replaced by the customer. Number of Lights **Specifications** ETL Listed Yes Sustainability Certificate(s) ENERGY STAR Certified; ENERGY STAR Canada Certified

RECESSED LIGHTING

TRASH ENCLOSURE MATERIAL LEGEND



NATURAL TIMBER

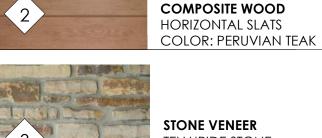



CONSTRUCTION © NEO STUDIO

SCALE: 1/8'' = 1'-0''

FOR: NOT FOR

SHEET TITLE: RENDERINGS

DRB.02

LOTS 6,7

LOTS 6,7

POStudio

3560 WALNUT ST. UNIT A DENVER, CO 80205 PHONE 303.758.3800

ROAM TOWNHOMES

PROJ. NO. 22-12

DRAWN: Author

CHECKED: Checker

APPROVED:Approver

DATE: 09 14 2023

REVISIONS

ISSUED
FOR: NOT FOR
CONSTRUCTION
© NEO STUDIO

SCALE: As indicated

SHEET TITLE: 24' TOWNHOME

DRB.01

110' - 37/8"

LEVEL 2 110' - 3 7/8"

LEVEL 1 100' - 0''

LEVEL 2 110' - 37/8"

LEVEL 1 100' - 0"

<u>Trash Enclosure - Elevation</u> 1 - a

Trash Enclosure -Elevation 2 - a

Trash Enclosure -Elevation 3 - a

LEVEL 1 100' - 0''


CONSTRUCTION

SHEET TITLE: RENDERINGS

© NEO STUDIO



LOTS 6, 7 LOTS 1, 2, 3, 4, 5

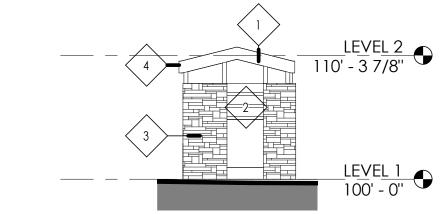

Trash Enclosure -Elevation 4 - a

TAMKO-TITAN

NATURAL TIMBER

COMPOSITE WOOD

HORIZONTAL SLATS

STONE VENEER

PALMYRA

TELLURIDE STONE

COLOR: PERUVIAN TEAK


TRASH ENCLOSURE MATERIAL LEGEND

TYPE B



waclighting.com | Phone (800) 526.2588 | Fax (800) 526.2585 | Headquarters/Eastern Distribution Center 44 Harbor Park Drive Port Washington, NY 11050 WAC Lighting retains the right to modify the design of our products at any time as part of the company's continuous improvement program. September 2023

TYPE A3 & A4

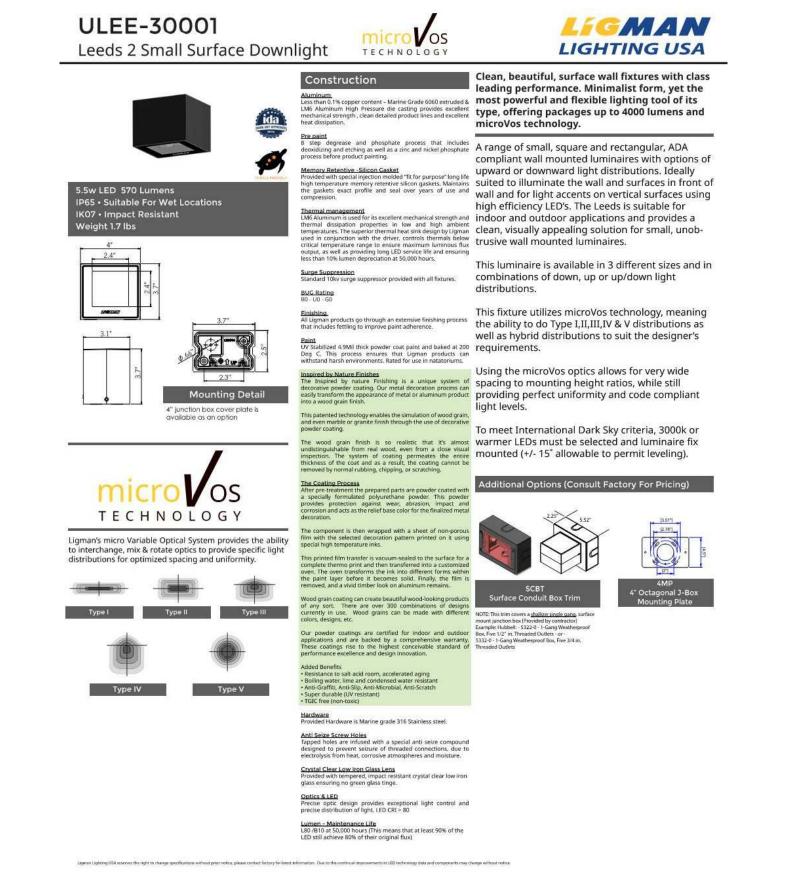


CHARCOAL GREY

ROAM - FILING NO. 4

MAJOR SITE PLANNING APPLICATION

VICINITY MAP

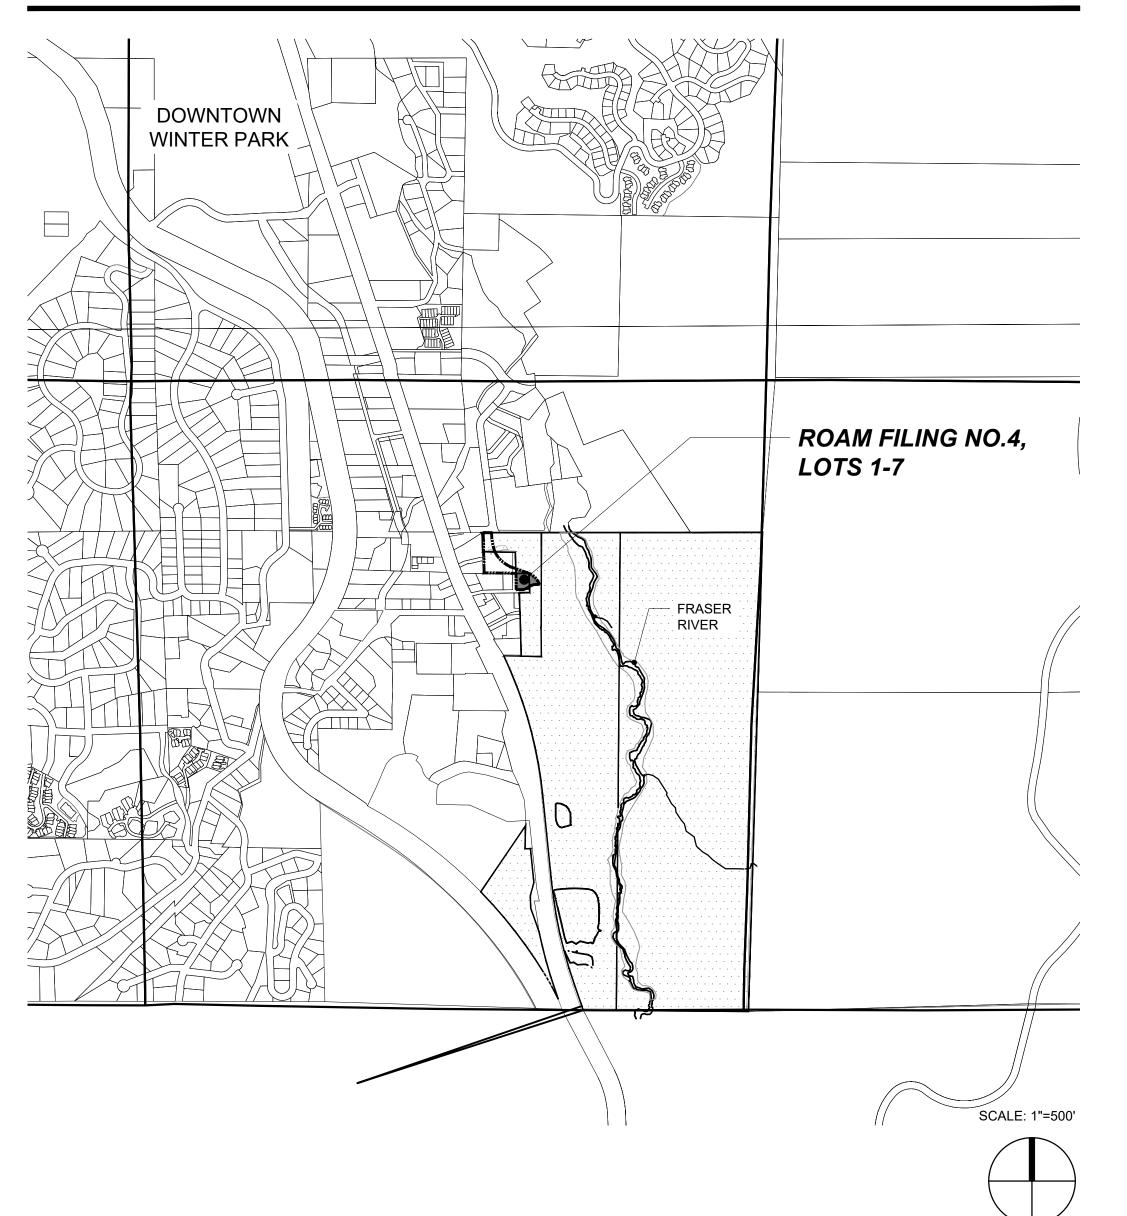

LAND USE CHART

SITE AREA CHART (SQ FT)					
LOT	LOT AREA	BUILDING	LANDSCAPE AREA	WALKS/ DRIVES AREA	TOTAL
1	2,758	1057	1,389	312	2758
% OF TOTAL		38.32%	50.36%	11.31%	100%
LOT	LOT AREA	BUILDING	LANDSCAPE AREA	WALKS/ DRIVES AREA	TOTAL
2	1,568	1013	405	150	1568
% OF TOTAL		64.60%	25.83%	9.57%	100%
LOT	LOT AREA	BUILDING	LANDSCAPE AREA	WALKS/ DRIVES AREA	TOTAL
3	1,683	1013	496	174	1683
% OF TOTAL		60.19%	29.47%	10.34%	100%
LOT	LOT AREA	BUILDING	LANDSCAPE AREA	WALKS/ DRIVES AREA	TOTAL
4	1,711	1013	513	185	1711
% OF TOTAL		59.21%	29.98%	10.81%	100%
LOT	LOT AREA	BUILDING	LANDSCAPE AREA WALKS/ DRIVES AREA		TOTAL
5	2,206	1077	941	188	2206
% OF TOTAL		48.82%	42.66%	8.52%	100%
LOT	LOT AREA	BUILDING	LANDSCAPE AREA	WALKS/ DRIVES AREA	TOTAL
6	1,937	1074	772	91	1937
% OF TOTAL		55.45%	39.86%	4.70%	100%
LOT	LOT AREA	BUILDING	LANDSCAPE AREA	WALKS/ DRIVES AREA	TOTAL
7	2,144	1074	893	177	2144
% OF TOTAL		50.09%	41.65%	8.26%	100%

LEGAL DESCRIPTION

A RESUBDIVISION OF PARCEL E OF THE FINAL PLAT OF ROAM FILING NO. 1, AMENDED LOT 1, SECTION 33, TOWNSHIP 1 SOUTH, RANGE 75 WEST OF THE SIXTH PRINCIPAL MERIDIAN, TOWN OF WINTER PARK, COUNTY OF GRAND, STATE OF COLORADO.

ZONING & SETBACKS

ZONING - ROAM FDP D-C

FRONT- 5' SETBACK 5' SETBACK 5' SETBACK

BUILDING COVERAGE

SITE AREA		
USE	AREA SQ.FT.	% OF TOTAL
LOTS		
LOT 1	2,758	9.7%
LOT 2	1,568	5.5%
LOT 3	1,683	5.9%
LOT 4	1,711	6.0%
LOT 5	2,206	7.7%
LOT 6	1,937	6.8%
LOT 7	2,144	7.5%
SUBTOTAL	14,007	49.1%
LANDSCAPE AREA	10,160	35.6%
ASPHALT DRIVE/DRIVEWAY APRONS*	4,379	15.3%
SUBTOTAL	28,546	100.0%

1) SEE LAND USE CHART, COVER SHEET, FOR INDIVIDUAL SIDEWALKS FOR EACH LOT.

BUILDING HEIGHT

MAX ALLOWED 55'

BUILDING HEIGHT MEASURED FROM EXISTING GRADE TO MIDPOINT OF ROOF

SITE PLAN

MIDPOINT OF ROOF: 46'-10 ½" 5-PLEX TOWNHOME BUILDING-MIDPOINT OF ROOF: $45'-1\frac{1}{2}"$ 2-PLEX TOWNHOME BUILDING -

SHEET INDEX

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ADOLUTEOTUDAL ELEVATIONO O MATERIALO	

ARCHITECTURAL ELEVATIONS & MATERIALS

ROAM TOWNHOMES - RENDERINGS

DRB.01 ROAM TOWNHOMES- 24' TOWNHOME DRB.02

VOGEL & ASSOCIATES ASSUMES NO RESPONSIBILITY FOR EXISTING UTILITY LOCATIONS (HORIZONTAL AND VERTICAL), THE EXISTING UTILITIES SHOWN ON THIS DRAWING HAVE BEEN PLOTTED FROM THE BEST AVAILABLE INFORMATION. IT IS, HOWEVER, THE RESPONSIBILITY OF THE CONTRACTOR TO FIELD VERIFY THE LOCATION OF ALL UTILITIES PRIOR TO THE COMMENCEMENT OF ANY CONSTRUCTION ACTIVITIES.

DEVELOPER

FRASER RIVER DEVELOPMENT COMPANY 1500 WYNKOOP ST., SUITE 200 DENVER, CO 80202 PHONE: 303-893-4288

ARCHITECT

NEO STUDIO MICHAEL NODA - REGISTERED ARCHITECT 3560 WALNUT ST. UNIT A DENVER, CO 80205 PHONE: 303-758-3800

PLANNER

VOGEL & ASSOCIATES 165 S. UNION BLVD. SUITE 440 LAKEWOOD, CO 80228 CONTACT: JEFF VOGEL PHONE: 303-893-4288

CIVIL ENGINEER

TOPKNOT ENGINEERING (TKE) 998 COUNTY ROAD 553 (POB 2225) GRANBY, CO. 80446 CONTACT: TONY DEPLATA PHONE: 970-281-5280

SURVEYOR

AZTEC CONSULTANTS, INC. 300 E. MINERAL AVE., SUITE 1 LITTLETON, CO 80122


LANDSCAPE ARCHITECT

VOGEL & ASSOCIATES 165 S. UNION BLVD. SUITE 440 LAKEWOOD, CO 80228 CONTACT: JEFF VOGEL PHONE: 303-893-4288

COVER SHEET Know what's **below.**Call before you dig.

Call before you dig.

Call before you dig.

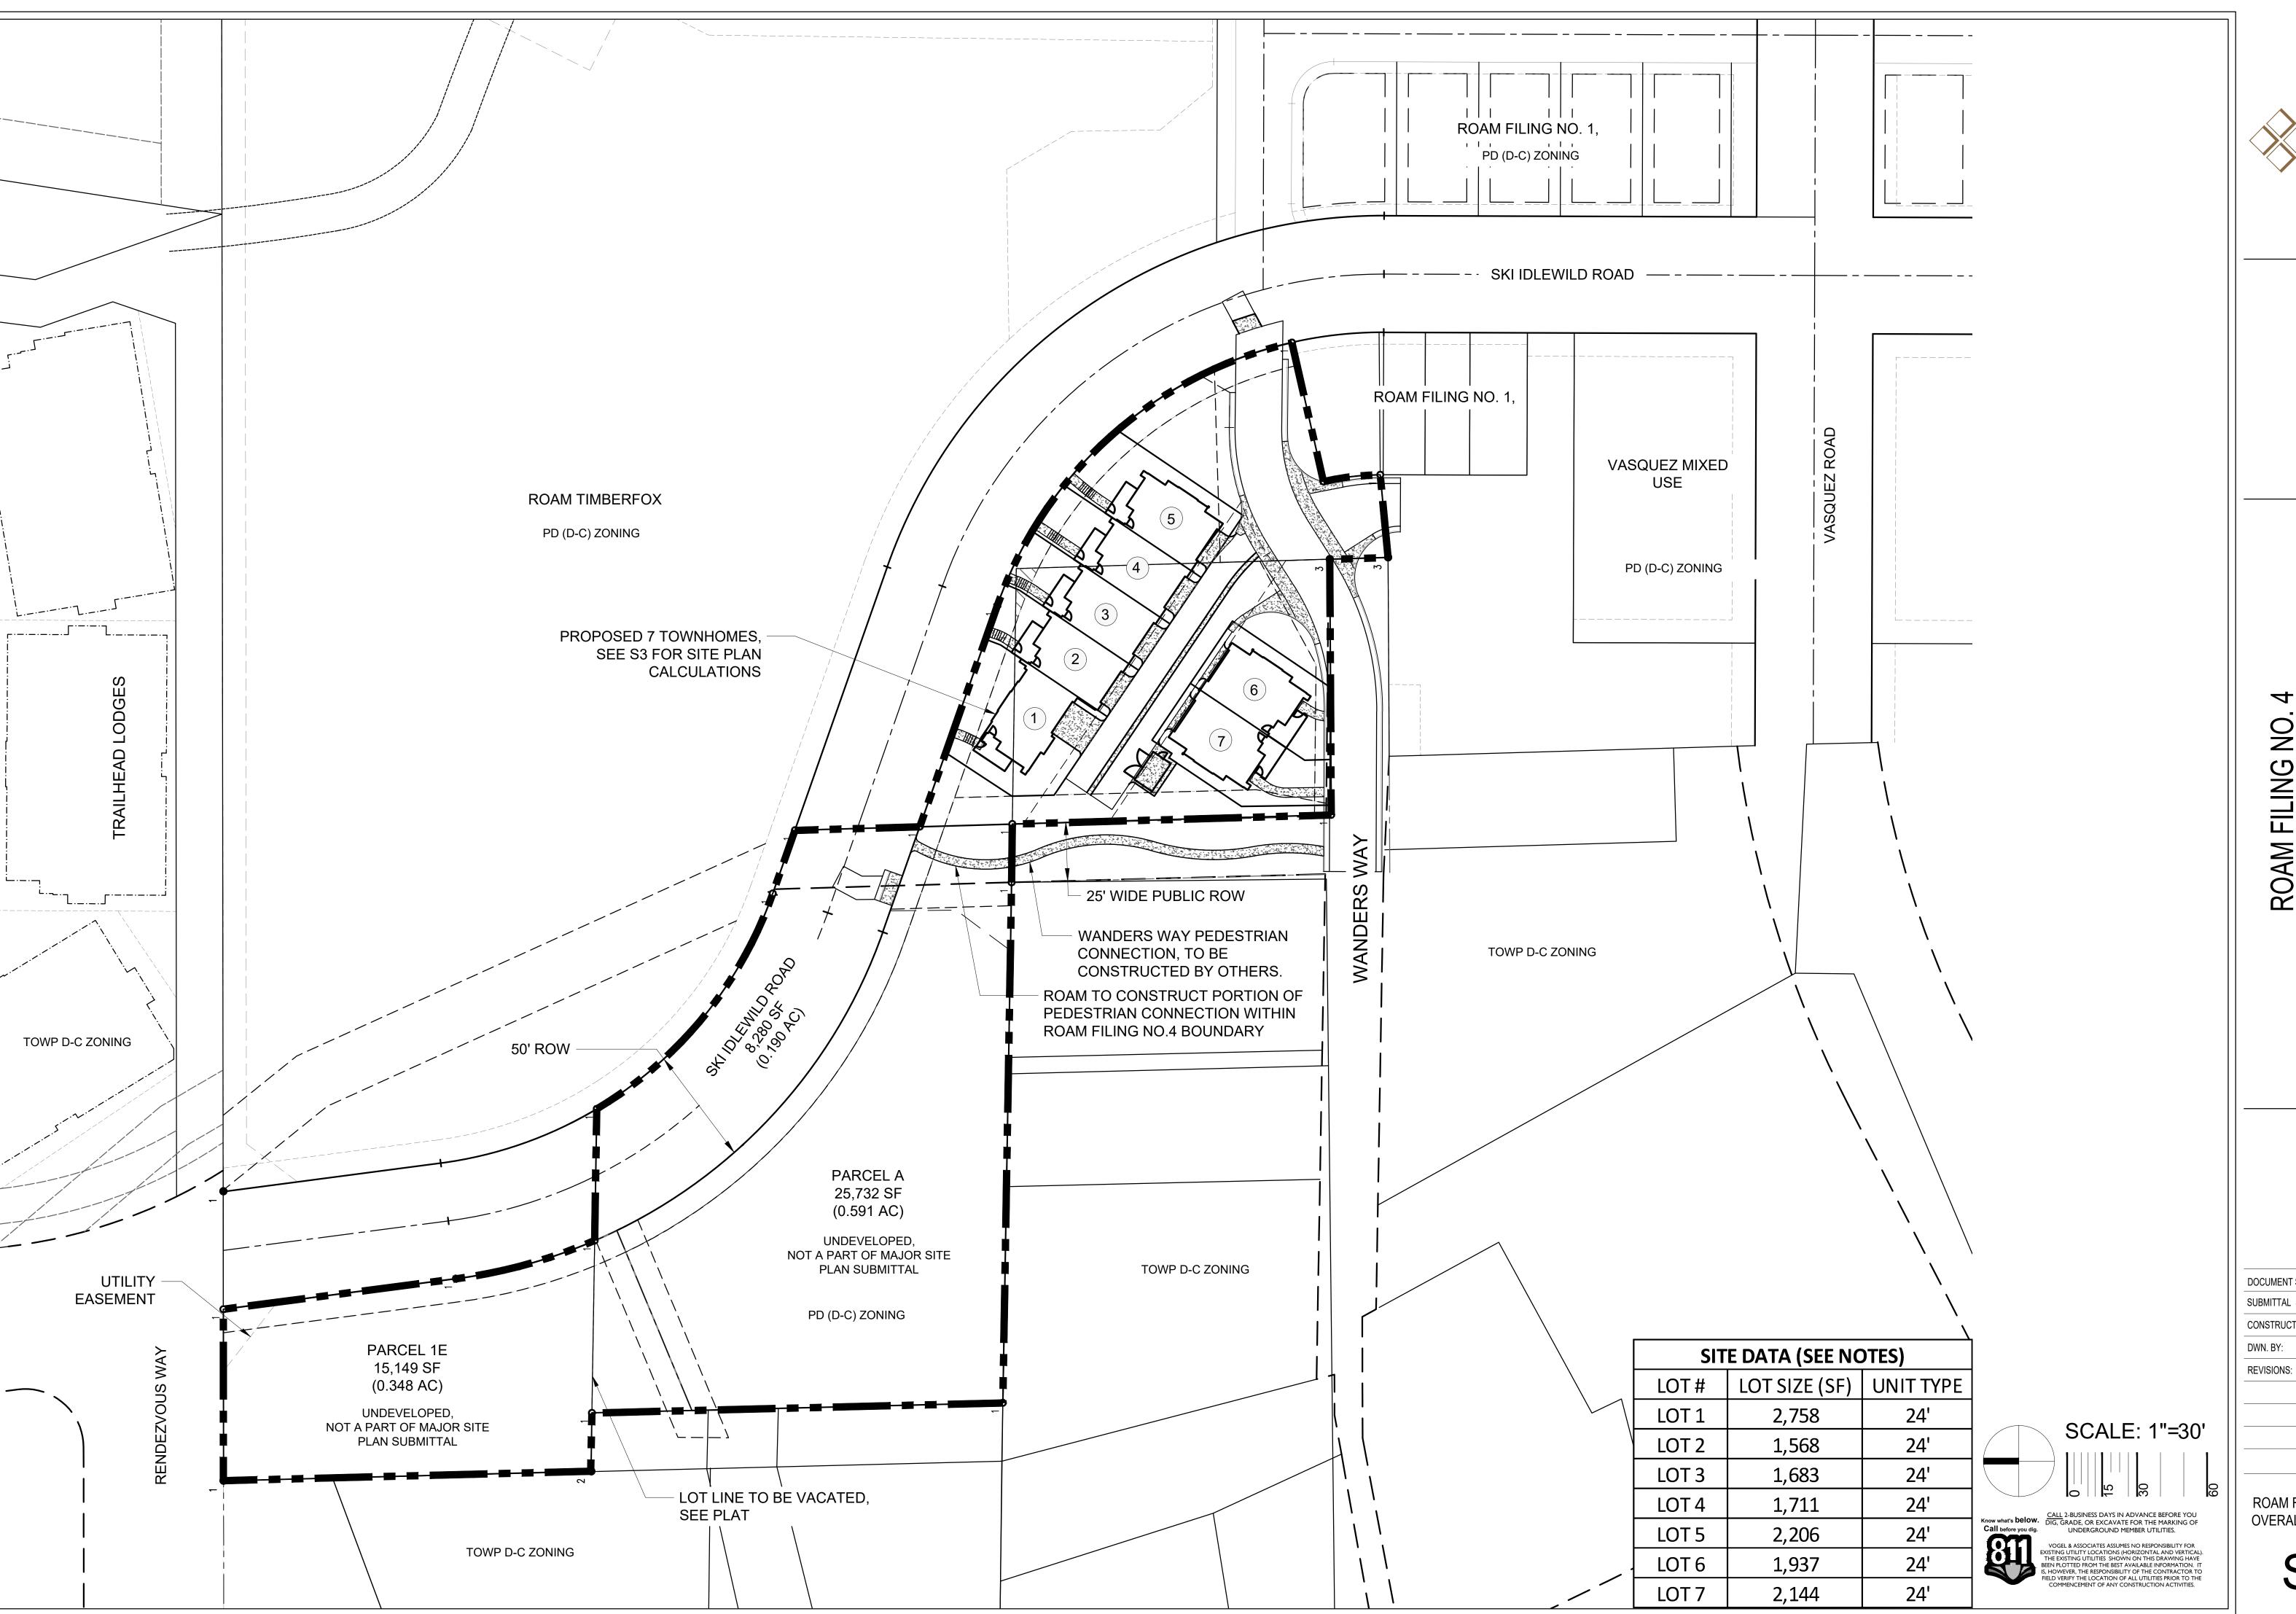

WOGEL & ASSOCI
and Planning ◆ Landscap
Development Constant Const

ROAM FILING NO. 4
MAJOR SITE PLANNING APPLICAT
WINTER PARK, CO 80482

DOCUMENT SET ISSUE DATE

SUBMITTAL SET 05/19/2023

CONSTRUCTION SET


VISIONS: MT

ROAM FILING NO. 4-OVERALL SITE PLAN

S1

REVISIONS: 10/25/22

SITE PLAN

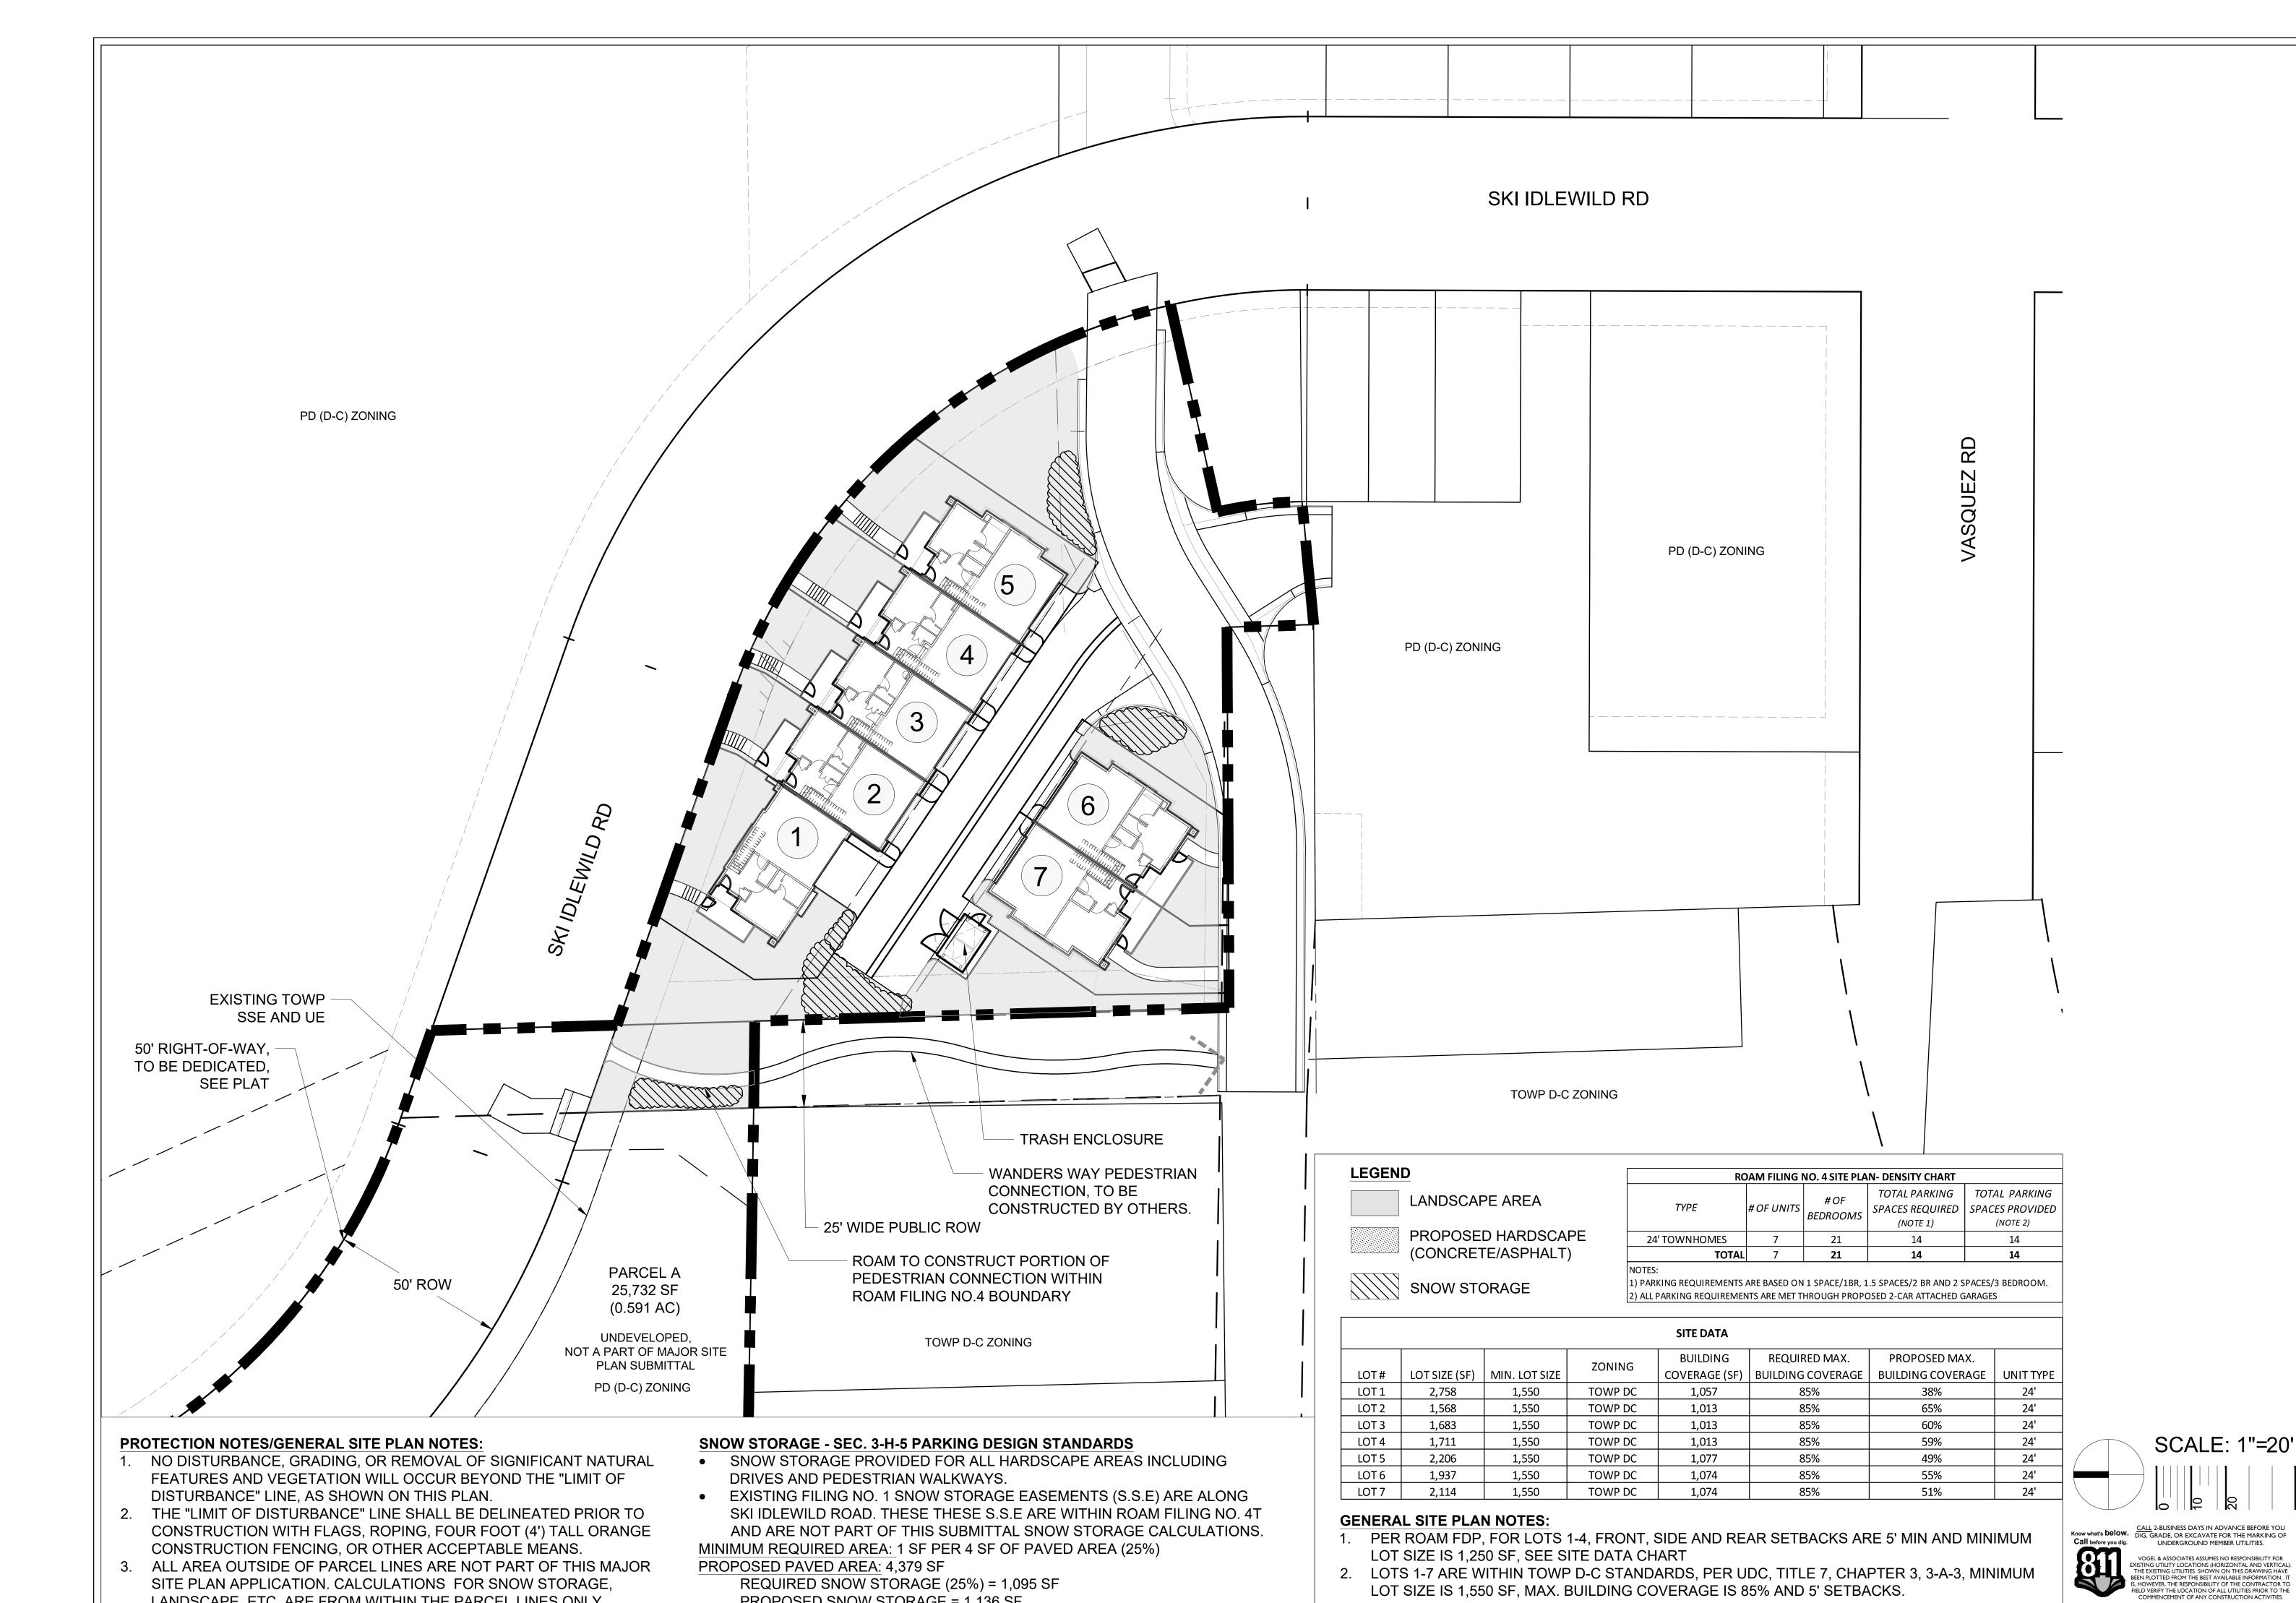

PROPOSED SNOW STORAGE = 1,136 SF

LANDSCAPE, ETC. ARE FROM WITHIN THE PARCEL LINES ONLY

388

10,160

TOTAL

Notes: See Narrative and Landcape Variance request for tree requirements

64

122

32

70



ROAM SITE PL //NTER F MAJOR

DOCUMENT SET ISSUE DATE SUBMITTAL SET 05/19/2023

CONSTRUCTION SET DWN. BY:

REVISIONS:

LANDSCAPE AND **REVEGETATION PLAN**

- 1. LANDSCAPE PLAN AND DETAILS TO BE USED IN CONJUNCTION WITH THE CIVIL PLANS TO FORM COMPLETE INFORMATION REGARDING SITE WORK.
- 2. CONTRACTOR TO CONTACT THE UTILITY NOTIFICATION CENTER OF COLORADO BEFORE DIGGING, INCLUDING BUT NOT LIMITED TO, TRENCHING AND SHRUB AND TREE PLANNING PITS. IF UTILITIES OCCUR AT LOCATIONS OF PROPOSED SHRUBS OR WITHIN EIGHT (8) FEET OF PROPOSED TREES, THE CONTRACTOR SHALL REPORT SUCH CONDITIONS TO THE OWNER'S REPRESENTATIVE. DAMAGE TO EXISTING UTILITIES BY THE CONTRACTOR IS THE RESPONSIBILITY OF THE CONTRACTOR.
- 3. INSTALL FIR FIBER MULCH RING AROUND TREES AS SHOWN ON PLANTING DETAILS BELOW.
- 4. NATIVE GRASS AREAS SHALL BE PREPARED WITH ASPEN RICH COMPOST OR AN APPROVED EQUAL AT A RATE OF 3 CUBIC YARDS PER 1,000 SQUARE FEET. THIS PREPARATION SHALL BE THOROUGHLY INCORPORATED INTO THE TOP 6" OF SOIL.
- 5. ALL TREES, AND OTHER PLANT MATERIALS ARE TO BE APPROVED BY THE OWNER'S REPRESENTATIVE PRIOR TO DELIVERY AND AGAIN AFTER DELIVERY TO SITE. ANY PLANT NOT MEETING APPROVAL MAY BE REJECTED AT ANY TIME PRIOR TO FINAL ACCEPTANCE.
- 6. ALL PLANT MATERIAL LOCATIONS ARE TO BE STAKED BY THE CONTRACTOR FOR REVIEW BY THE OWNER'S REPRESENTATIVE. ALL ADJUSTMENTS SHALL BE MADE BY THE CONTRACTOR. THE CONTRACTOR SHALL NOT DIG PLANT PITS UNTIL LOCATIONS ARE APPROVED.
- 7. THE CONTRACTOR SHALL BE RESPONSIBLE FOR THE REPAIR OF ANY DAMAGE TO EXISTING UTILITIES, WALLS AND/OR OTHER EXISTING STRUCTURES THAT IS A RESULT OF HIS WORK. THE REPAIR OF SUCH DAMAGE WILL BE AT NO ADDITIONAL COST TO THE OWNER.
- 8. THE CONTRACTOR IS RESPONSIBLE TO CONFIRM ALL PLANT QUANTITIES AS SHOWN ON THE LANDSCAPE
- 9. ALL AREAS DISTURBED BY GRADING OR CONSTRUCTION ACTIVITIES AND NOT INDICATED TO BE SURFACED OTHERWISE SHALL BE SEEDED WITH THE SPECIFIED NATIVE SEED MIX. SEE STANDARDS AND SPECIFICATIONS FOR DESIGN AND CONSTRUCTION, SECTION 7.4, CHART BELOW STATING THE MIX
- COMPOSITIONS FOR DESIGN AND CONSTRUCTION, SECTION 7.4, CHART BELOW STATING THE MIX COMPOSITION RECOMMENDED BY THE GRAND COUNTY NATURAL RESOURCE CONSERVATION SERVICE.

 10. THE CONTRACTOR SHALL HAVE ALL GRADING APPROVED BY LANDSCAPE ARCHITECT PRIOR TO
- INSTALLATION OF PLANT MATERIAL AND NATIVE SEED

 11. THE CONTRACTOR SHALL PROTECT ALL EXISTING VEGETATION TO REMAIN DURING CONSTRUCTION.
- 12. SEE CIVIL EROSION CONTROL PLAN.
- 13. ALL TREES TO BE DEEP WATERED BY HAND OR TRUCK AT TIME OF PLANTING AND CONTINUE UNTIL IRRIGATION SYSTEM IS OPERATING.
- 14. ALL TREES WILL BE IRRIGATED WITH TEMPORARY DRIP IRRIGATION SYSTEM FOR TWO GROWING SEASONS.
- 15. SHRUB BEDS TO INCLUDE 4" OF FIR FIBER MULCH OR AS SPECIFIED BY THE OWNERS REPRESENTATIVE.
- 16. ALL FIR FIBER MULCH MUST BE TREATED WITH FLAME STOP II, PER MANUFACTURES INSTRUCTIONS.
- MANUFACTURER:
 - FLAME STOP INC.
 - 924 BLUE MOUND ROAD FT.WORTH, TX 76131
 - 1-877-397-7867
 - -8//-39/-/86/
- WWW.FLAMESTOP.COM
- 17. ALL PLANT MATERIAL TO BE IRRIGATED BY AN UNDERGROUND AUTOMATIC IRRIGATION SYSTEM THAT UTILIZES SMART WATER TECHNOLOGY. SHRUBS AND GROUNDCOVERS TO BE IRRIGATED WITH AN AUTOMATIC IRRIGATION DRIP SYSTEM. NATIVE SEED AREAS EXCEPT AS NOTED WILL NOT BE IRRIGATED
- 18. FILTER FABRIC TO BE INSTALLED UNDER ALL GRAVEL AND CRUSHER FINES TRAIL PER MANUFACTURES INSTRUCTIONS.
- 19. SOIL AMENDMENT FOR ALL SOD AREAS SHALL BE A MINIMUM OF THREE (3) CUBIC YARDS OF ORGANIC MATTER PER ONE-THOUSAND SQUARE FEET. THIS SOIL AMENDMENT SHALL BE ROTO-TILLED TO A DEPTH OF SIX (6) INCHES. CLASS I OR CLASS II COMPOST IS REQUIRED. INSTALLING CONTRACTOR IS TO PROVIDE SUBMITTAL FROM SUPPLIERS FOR SOD AND NATIVE SEED MIX AT TIME OF LANDSCAPE INSPECTION.
- 20. ALL BASE INFORMATION WAS PROVIDED BY CORE CONSULTANTS.

		TEMPORARY SEED MI	X	
LAND USE	% OF MIX	SPECIES	VARIETY	APPLICATION RATE (LBS/AC)
DRY LAND NON-	50	SMOOTH BROOME	MANCHAR	8
IRRIGATED RECLAIMATION	50	PUBESCENT WHEATGRASS	LUNA	8

NOTES

- The applied seed shall not be covered by a soil thickness greater than 0.5" in depth.
- Seeding shall take place on all disturbed areas and stockpiles expected to remain dormant for a period greater than 30 days.
- To provide temporary erosion control prior to seed application, utilize surface roughening (on the contour
 or perpendicular to prevailing winds) and apply mulch.
- 4. Seed shall be planted with drill seeding equipment, whenever possible.
- 5. Areas that require broadcast seeding shall be mulched and tackified.

Native Grass Seed	% of mix	PLS
Mountain Brome grass, Bromar	10%	5.0
Canada Bluegrass, Talon	5%	2.5
Big Bluegrass, Sherman	5%	5.0
Sheep Fescue, Covar	20%	10.0
Slender Wheatgrass	20%	10.0
Pubescent Wheatgrass, Luna	25%	12.5
Cicer Milkvetch	2%	1.0
Annual Ryegrass, Gulf	5%	2.5
Woods Rose	8%	4.0


SEED APPLICATION: DRILL SEED 0.25"-0.5" INTO THE SOIL. IN AREAS NOT ACCESSIBLE TO A DRILL HAND BROADCAST AT DOUBLE THE ABOVE RATE AND RAKE 0.25"-0.5" INTO THE SOIL. ON SLOPES STEEPER THAN 2:1 HYDROSEED AT DOUBLE THE RATE.

SOIL AMENDMENTS: PREPARE SOIL WITH SAND BASED GRANULAR HUMATE AT THE RATE OF 435 LBS. PER ACRE.

FERTILIZER APPLICATION: APPLY BIOSOL ALL NATURAL ORGANIC FERTILIZER AT THE RATE OF 1800 LBS. PER ACRE IN ALL SEEDING AREAS.

HYDROMULCH APPLICATION: HYDROMULCH SHALL CONSIST OF CELLULOSE FIBER MULCH AND MULCH TACKIFIER AND SHALL BE APPLIED AT THE RATES OF 2,000 LBS PER ACRE AND 100 LBS. PER ACRE CONSECUTIVELY.

Plant Li	ist			
SYMBOL	ABBREVIATION	COMMON NAME	BOTANICAL NAME	SIZE
DECIDU	OUS TREES			
\odot	ASP	ASPEN CLUMP	POPULUS TREMULOIDES	3" CAL.
EVERGR	EEN TREES			
BS BLUE SPRUCE		BLUE SPRUCE	PICEA PUNGENS	8'-10' HT
ES I		ENGLEMAN SPRUCE	PICEA ENGELMANNII	8'-10' HT

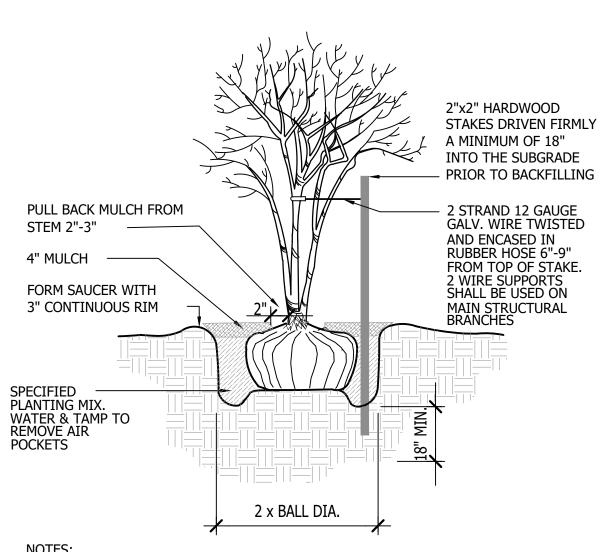

STAKE TO FIRST BRANCHES AS NECESSARY FOR SUPPORT

2. WIRE SHALL NOT TOUCH OR RUB ADJACENT TRUNKS OR BRANCHES

NOT TO SCALE

1 MULTI-TRUNK ASPEN TREE STAKING
L2

DOUBLE STRAND GALVANIZED WIRE PROVIDE 3 GUY SYSTEMS EQUALLY SPACED AROUND TREE, AS PER DIAGRAM PLACE 3/4" DIAmeter WHITE PVC, 36" LENGTH, ON ALL GUYING PLANT TREE W/ TOP OF ROOT BALL 3" ABOVE FINAL GRADE 4" DEPTH MULCH RING UNLESS IN TURF AREAS (SEE BELOW) -4" HEIGHT WATER SAUCER IN NON-TURF AREAS - SPECIFIED STAKES DRIVEN AT AN ANGLE, FLUSH WITH GRADE BACK FILL MIXTURE AS PER SPECIFICATIONS 2"-3" AFTER TREE IS SET IN PLANTING PIT, REMOVE ALL TWINE & WIRE FROM TOP & SIDES OF ROOT BALL 2x DIAMETER OF PULL BURLAP BACK 1/3 (MIN.) ROOT BALL, MIN. UNDISTURBED SUB GRADE - SET ROOT BALL ON EXISTING UNDISTURBED SUBGRADE-DO NOT OVER-EXCAVATE 1. PULL MULCH BACK 2" TO 3" FROM TRUNK OF TREE

DO NOT CUT LEADER

SPECIFIED TRUNK ATTACHMENT

2. INSTALL SPECIFIED MULCH TO DRIP LINE OF TREE WHERE PLANTED

IN LAWN AREAS. MULCH TO BE 2" DEEP IN LAWN AREAS.

3. DO NOT PROVIDE WATER BASIN IN IRRIGATED LAWN AREAS.

2 EVERGREEN TREE PLANTING
L2

E E


NOT TO SCALE

DOCUMENT SET ISSUE DATE
SUBMITTAL SET 05/19/2023
CONSTRUCTION SET

DWN. BY: MT RL & MT

REVISIONS:

LANDSCAPE DETAILS

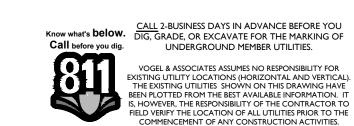

APL PL

MAJOR