

# TOWN OF WINTER PARK PLANNING COMMISSION Tuesday, September 10, 2024 8:00 AM

## AGENDA

#### I. Call to Order

#### II. Roll Call of Commission Members

#### III. Public Comment

This time is reserved for anyone from the public to speak about items not on the agenda. The Planning Commission is not prepared to decide on matters brought up during this time, but if warranted, will place them on a future agenda.

#### IV. Conflict of Interest

#### V. Consent Agenda:

- a. Minutes August 27, 2024
- b. Minor Site Plan Riverwalk at Winter Park Lot 18 135 Apres Way (PLN24-048)
- c. Minor Site Plan Riverwalk at Winter Park Riverfront Pavilion (PLN24-046) and Central Amenity Area and Entry Gates (PLN24-047)

#### VI. General Business:

- a) Election of Vice Chair
- b) Presentation of Community Development Department & UDC Audit
- c) PUBLIC HEARING: Major Site Plan 1097 Winter Park Drive (PLN23-098)

#### VII. Director's Report:

This time is reserved for specific items from staff requiring Commission direction and for relaying important information to the Commission.

# VIII. Planning Commission Items of Discussion

This time is reserved for Commission discussion items that are not listed on the agenda.

Online Meeting Login Instructions - See next page

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Passcode: 113389

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- +1 669 900 6833 US (San Jose)
- +1 564 217 2000 US
- +1 646 931 3860 US
- +1 689 278 1000 US
- +1 929 436 2866 US (New York)
- +1 301 715 8592 US (Washington DC)
- +1 305 224 1968 US
- +1 309 205 3325 US
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International numbers available: <a href="https://us02web.zoom.us/u/kdr9la1HH0">https://us02web.zoom.us/u/kdr9la1HH0</a>

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#### **Public Hearing Process**

If you would like to participate in the public hearing, please follow these instructions so we can make sure everyone that wants to speak has the opportunity. When you log into Zoom you will be automatically muted to limit background noise. When the public hearing is opened for public comment, please use the "raise your hand" feature and staff will unmute citizens in the order they were received. To enable "raise your hand" feature, click on the "Participants" button the bottom of the screen.



# TOWN OF WINTER PARK PLANNING COMMISSION Tuesday, August 27, 2024 8:00 AM

### **MINUTES**

**DATE:** Tuesday, August 27, 2024

**MEETING:** Winter Park Planning Commission

**PLACE:** Town Hall Council Chambers and Zoom Meeting Call

**PRESENT:** Chair Dave Barker, Commissioners Doug Robbins, Chris Tagseth, Thomas

McDonald and Angela McDonough are present. Also present are Community Development Director James Shockey, Senior Planner Brian Kelly, Planning

Consultant Sheila Booth and Town Attorney Mr. Kunal Parikh.

**OTHERS** 

**PRESENT:** None.

#### I. Call to Order

Chair Barker calls the meeting to order at 8:11 a.m.

#### II. Roll Call of Commission Members

All Commissioners are present today. Vice Chair Holzwarth and Commissioner Kish had their last Planning Commission meeting on August 13, 2024. Today is Commissioner Tagseth's last Planning Commission meeting.

#### III. Public Comment

No one comes forward.

#### **IV. Conflict of Interest**

Commissioner Thomas McDonald states that he is currently employed by the developer of 185 Vasquez Road and is recusing himself from this item of business.

## Consent Agenda:

a. Minutes – August 13, 2024

Commissioner Tagseth moves, and Commissioner McDonough seconds the motion approving the consent agenda. Motion carries 5,0.

#### V. General Business:

a) PUBLIC HEARING: Preliminary Plat – The Landings Townhomes – Lot 2, Cullen Minor Plat – 185 Vasquez Road (PLN24-005)

AND

b) PUBLIC HEARING: Major Site Plan – The Landings Townhomes – Lot 2, Cullen Minor Plat – 185 Vasquez Road (PLN23-095)

Planning Consultant Sheila Booth begins her presentation by outlining the background of these two planning applications. Consultant Booth displays the staff report on the screen as she describes the main items related to both the Preliminary Plat and the Major Site Plan. Staff is recommending approval of both the Preliminary Plat and the Major Site Plan.

The applicant, Mr. Jim Candy comes forward. Mr. Candy talks about the potential benefits this project will bring to the Town. Mr. Candy states that they have been in conversations with the community to improve this development.

Then, Mr. Michael Dire the architect of the project and part of the applicant's team comes forward. Mr. Dire describes the renderings of the project. Mr. Dire explains the road and access layouts, the materials, color scheme, architectural elements (siding, balconies, overhangs, etc.). Additionally, Mr. Dire goes over the different perspectives of the development.

Chair Baker opens the Public Hearing for both this Preliminary Plat and Item B, Major Site Plan. Mr. and Mrs. Vandelaar (115 Lions Gate Drive) come forward. They state that they are familiar with the challenges of developing in this area. Their main concern is the value of their property declining due to the increase of traffic through the public ROW adjacent to their home. The Vandelaars are willing to work with the developer on keep a reasonable level of privacy for their home.

Mr. Manuel Uzcathegui (183 Idlewild Lane) comes forward and talks about the environmental impact of this development. Mr. Uzcategui mentions the construction elements such a concrete, noise levels, setbacks to Vasquez Creek including the high-water mark.

With no one else coming forward, Chair Barker closes the public hearing.

Mr. Dire comes forward and addresses the Vandelaars's concerns about access and traffic. Mr. Dire states that the project will improve the access in the public right-of-way that will be shared by three property owners. Regarding the high-water mark, this has been verified and the supporting documentation has been included in the applications.

The Commission then ask about the installation of hot tubs in some of the units. Mr. Dire replies that some of the decks will have hot tubs, and these decks will have the necessary connections to sanitary sewer, and the decks will be engineered to bear the loads.

Then, the Commission and Director Shockey have a conversation about the easements for access from Lions Gate Drive. The conversation includes the depth of the easements and the background of how this particular access came to be. The Town Attorney Mr. Kunal Parikh comes forward and clarifies questions from the Commission concerning the public right-of-way.

The meeting then goes over the water quality aspect. Director Shockey describes how similar developments have handled stormwater detention adjacent to the creek. Consultant Booth and Director Shockey then explain in more detail the stormwater system that the developer is proposing by showing the actual construction plans on the screen.

The Commission then inquires about the 30 ft. undisturbed area. The Commission would like to know if there is any plan to avoid the use of that area to install outdoor furniture or similar items. Director Shockey replies that there is a regulation in place to protect this area during and after construction.

One other topic mentioned is the installation of screens for hot tubs installed adjacent to Lions Gate Drive and Vasquez Road. The applicant, Mr. Dire comes forward and states hot tubs will only be installed on the second story decks adjacent to Lions Gate and Vasquez Road. They are allowed on the first level for the two buildings adjacent to the creek.

Commissioner Robbins moves, and Commissioner McDonough seconds the motion recommending approval of the Preliminary Plat and approving the Major Site Plan with staff conditions and the following two additional conditions - add a note to the site plan, preliminary plat and in the homeowners association documents stating hot tubs are not allowed on the first floor for Buildings A and D adjacent to Lions Gate Road and Vasquez Road and add the following note to the preliminary plat and the homeowners association documents - No improvements are allowed within the 30 foot Water Quality and Riparian

Buffer including benches, trails or landscaping. Motion carries 4,0.

# VI. Director's Report:

Director Shockey informs the Commission that today is Commissioner Tagseth last day. Three new members will be attending the next Planning Commission meeting on September 10<sup>th</sup>, 2024.

Also, on September 10<sup>th</sup>, 2024, the Commission will elect a new Vice Chair.

# VII. Planning Commission Items of Discussion

There being no further business to discuss, upon a motion regularly adopted, the meeting was adjourned at 9:40 a.m.

The next scheduled meeting of the Planning Commission will be Tuesday, September 10<sup>th</sup>, 2024, at 9:00 a.m.

Irene Kilburn, Planning and Building Technician II





TO Planning Commission

FROM James Shockey, Community Development Director

DATE September 10, 2024

RE Riverwalk at Winter Park, Lot 18 (PLN24-048)

Property Owner: Riverwalk, LLC

Applicant: Adam Casias, Studio 1

Location: West side of Apres Way, north of Ski Idlewild Road.

**<u>Legal Description</u>**: Lots 18, Riverwalk at Winter Park

Architects: Adam Casias, Studio 1

Zoning: R-2 (Multiple Family, Residential) (Riverwalk Final Development Plan (FDP)

#### **Authority:**

Pursuant to § 5-B-3 of the Winter Park Unified Development Code (the "UDC"), the Director considers building configurations, colors, materials and general compatibility of proposed structures and outdoor advertising within the Town of Winter Park and Minor Site Plan approval is required before building permit issuance.

#### Variances:

No Board of Adjustment (BOA) or administrative variance requests were requested with this application.

#### Architecture:

Satisfactory. One (1) new single-family detached dwelling unit (DU) is proposed on vacant unimproved land. The building utilizes a contemporary, pitched roof form with deep eaves with timber architectural features, and the building shape clearly identifies the entrance. The building has a V-shaped footprint with a two-car garage underneath a second-floor porch. Patios are located along each façade. The architecture is consistent with Mountain Town character seen throughout Winter Park. The proposed single family dwelling complies with Winter Park Design Guidelines.

#### Title Commitment:

Unsatisfactory. The submitted title commitment is dated October 23, 2023. A Title commitment shall not be more than six months older than the submittal date.

The applicant shall provide an updated Title Commitment that is not older than 6 months from initial submittal date.



#### Homeowner's Association Review:

Satisfactory. The applicant provided a letter from the HOA with blanket approval of all residential lots and improvements. The Roam Design Review Committee has provided a letter stating its approval of all elements of Riverwalk.

### **Material and Color:**

Satisfactory. The material palette shows a stone veneer base, a combination of gabled standing seam metal roofing, and cedar lap siding visually dividing the stories. The roof has timber snow guards. The design primarily utilizes stone and natural wood colors with the exception of black metal features on the roof, roof caps, and patio metal railings. Use of materials is balanced and matches architectural character of the Town. Black metal-lined windows appear inset to visually strengthen the wall. The proposed design complies with Winter Park Design Guidelines.

#### **Outdoor Lighting:**

Unsatisfactory. One (1) type of exterior fixture is proposed with a total of 19 fixtures throughout the site. The fixture does not contain the International Dark Sky Association (IDA) approval stamp (UDC, § 3-K-3(A)(1)). Spec sheet from manufacturer states it is Dark Sky compliant but does not have the IDA stamp nor does the fixture appear on the IDA website. The applicant states the total lumens per fixture is 575 per fixture and there are 19 fixtures. According to sec. 3-K-5(A), the maximum lumens for a single family property is 5,100. Based on the provided lumen values, the proposed lighting exceeds the code requirement by 5,825 lumens

➤ The applicant shall provide a light fixture with the International Dark Sky Association stamp and reduce the total lumens on sight to 5,100 CCT or less.

	Fixture Name	Proposed # of Fixtures	Proposed Lumens per Fixture	Proposed CCT
Lot 18	Hinkley Wall mount barn light	19	575 per fixture	3000

## **Accessory Dwelling Unit (ADU):**

N/A, not proposed. One ADU is permitted on each lot, according to the FDP.

#### Site Plan:

Unsatisfactory. Overall, the Site Plan for Lot 18 provides all information required for staff review; however, there are two additional items that must be clarified. First, a five-foot tall, three-rail fence is proposed on the western and northern property lines per the FDP but the site plan does not show the fence. Secondly, the Limit of Disturbance line extends beyond the property line.

- > Applicant shall verify when the proposed fence approved with the FDP will be constructed, and if it will be constructed on the subject property.
- Provide clarity in site plan notes that adjacent properties that are under separate ownership will not be disturbed permanently nor temporarily during all phases of construction. Specifically, show that the limit of disturbance does not include any of the adjacent jurisdictional wetlands.



#### Floorplans:

Unsatisfactory. There are three floors total. Floor plans do not indicate the square footage for individual rooms or entire floor. A roof plan was not included in the submittal. Notes indicate that the elevation documents contain additional information on the roof, but the elevation plans primarily outline materials.

- Applicant shall provide a roof plan as another sheet with the floor plans.
- > Applicant shall provide square footage for each room in the floor plan or provide total square footage of each floor in the floor plan.

#### **Building Elevations:**

Unsatisfactory. Elevation plan includes all materials required for review. As previously noted, the proposed building is compliant with the Winter Park Design Guidelines. Elevation markers do not provide enough information for staff to properly measure height.

The Elevation plans shall be modified to accurately depict and measure building height from top of existing grade or top of exposed foundation.

#### Setbacks:

Unsatisfactory. Some architectural features encroach into setback requirements, such as column and roof, but the FDP permits these items to extend up to 24-inches into required setback. The proposed hot tub and firepit are encroaching into the 10-foot rear setback and a step or similar structure appears to encroach 3-inches into the side setback.

- Identify the structure on the southside of the garage, it appears to be a step, but there is no door. The structure identified encroaches the 5-ft side setback approximately 3 inches.
- Applicant shall remove or relocate the fire pit and hot tub from the proposed location in the rear setback. Alternatively, the Applicant may seek a setback variance from the Board of Adjustment.
- > The structure on the south side of the garage shall be modified to stay within the 5-ft setback.

#### **Building Coverage:**

Unsatisfactory. The building coverage maximum is 40 percent (40%) as required by the R-2 zoning district and the approved FDP. Based on building coverage measurement standards found in Sec. 3-A-7, the proposed building coverage exceeds the maximum permitted 40 percent (40%) by approximately four percent (4%).

> Update the site plan to reduce total building coverage by approximately four percent (4%) to meet the 40 percent (40%) building coverage requirement.

#### **Building Height:**

Unsatisfactory. The elevation plans accurately state the maximum height of 35-feet, per the Riverwalk FDP but the height appears to be measured from "concrete". As previously noted, the Elevation plan shall be updated so that building height may be accurately reviewed for compliance.

### Parking:

Unsatisfactory. All on-site parking as designed is permissible. The site includes a two-car garage and a driveway. All parking shall be located on-site in accordance with the requirements of the FDP. Construction parking is shown on the adjacent Trust property.

> Applicant shall provide confirmation that construction staging and parking are acceptable on



adjacent property, owned by the Wheeler Trust.

#### Landscaping:

Unsatisfactory. The FDP, states that lots in Riverwalk are required to follow the Town of Winter Park Landscape Design Regulations and Guidelines. Tree Removal and Protection plans are not required for single family minor site plans. According to the FDP, a Residential LTZ (B) is located along the northern property line. The landscape plan is not at a proper scale to effectively evaluate the buffer. The buffer yard details are included in the site plan application but indicate the total, instead of those specific to Lot 18. The overall buffer yard provided was approved with the FDP. The applicant shall update the Landscape Plan in compliance with the UDC and FDP.

- ➤ The landscape plan does not provide a landscaping plan specific to Lot 18. It only depicts the overall landscape plan approved with the FDP. Provide a Landscape Plan, scale of 1' = 20', for Lot 18 that includes the following:
  - a. Proposed species name.
  - b. Property lines labeled with required bufferyard types.
  - c. Structures, existing and proposed.
  - d. Landscaping, existing and proposed.
  - e. Hardscaping, existing and proposed.
  - f. Top-of-wall and bottom-of-wall elevations of all retaining walls and site walls.

#### **Snow Storage:**

Partially satisfactory. The FDP has an approved Snow Storage Plan; however this submittal does not include site specific snow storage locations. According to the approved snow storage plan, snow storage is located on the subject property. Provide snow storage locations and amounts on the Site Plan.

> Applicant shall provide a snow storage table that includes landscaped area, hardscape area, required snow storage, and provided snow storage.

Lot #	Landscape Area (SF)	Asphalt Hardscape (SF)	Snow Storage required (SF)	Snow Storage provided. (SF)
18				

#### Erosion Control / Drainage Plan / Drainage Report / Grading / Engineer Review:

Satisfactory. The overall grading and drainage plan and drainage report were approved with the FDP and the submitted plan has been stamped by professional engineer.

#### **Driveway**:

Unsatisfactory. The proposed driveway slope is 2.1 percent (2.1%) which is an acceptable slope; however, the driveway is too short. At midpoint it is approximately 18.5 feet in length. The length of the driveway, as shown on the FDP, is approximately 24-feet. The driveway does not meet the road at a perpendicular angle. The driveway at its shortest is 15-ft and at its longest is 21.5-ft.

Applicant shall redesign driveway to be consistent with the approved FDP.



#### **Utility Review:**

N/A, the overall utility plan was approved with the FDP. Applicant has submitted a utility plan which shows sanitary sewer and water mains abutting the subject property. Utility easements are shown along eastern and northern property lines.

#### Inspection:

Building Division staff have not performed a Pre-Disturbance inspection of the property.

No site clearing shall be permitted until the Building Division has verified the Pre-Disturbance Checklist has been implemented on the site.

#### Staff Recommendation:

Staff approves the Minor Site Plan with the following conditions:

- 1. The applicant shall provide an update Title Commitment that is not older than 6 months from initial submittal date.
- 2. The applicant shall provide a light fixture with the International Dark Sky Association stamp, and reduce the total lumens on sight to 5,100 CCT or less.
- 3. Applicant shall verify when the proposed fence that approved with the FDP will be constructed, and if it will be constructed on the subject property.
- 4. Identify the structure on the southside of the garage and verify it is allowed in to encroach into the 5-ft side setback.
- 5. The Elevation plans shall be modified to accurately depict and measure building height from top of existing grade or top of exposed foundation.
- Applicant shall remove or relocate the fire pit and hot tub from the proposed location in the rear setback or seek a setback variance from the Board of Adjustment. The structure on the south side of the garage shall be modified to stay with the 5-ft setback.
- 7. Limit of Disturbance line extends beyond the property line. Provide clarity in note that adjacent properties under separate ownership will not be disturbed permanently nor temporarily during all phases of construction. Specifically, show that the limit of disturbance does not include any of the adjacent jurisdictional wetlands.
- 8. Applicant shall provide a roof plan as another sheet with the floor plans.
- 9. Applicant shall provide the square footage for each room on the floor plan or provide total square footage of each floor in the floor plan.
- 10. Applicant shall provide confirmation that construction staging and parking are acceptable on adjacent property, owned by the Wheeler Trust.
- 11. Update the landscape plan to provide landscaping specific to Lot 18.
- 12. Update the site plan to provide a snow storage table that includes landscaped area, hardscape area, required snow storage, and provided snow storage specific to Lot 18.
- 13. Applicant shall redesign driveway to be compliant with the approved FDP.
- 14. Revise the site plan and site design to reduce total building coverage by approximately 4 percent (4%) to comply with maximum building coverage regulations.
- 15. No site clearing shall be permitted until the Building Division has verified the Pre-Disturbance Checklist has been implemented on the site.

#### **Required Permits:**

- ✓ Building Permit
- ✓ Driveway Permit
- ✓ SFD/Duplex Deposit Agreement





# **Land Use Review Application Form**

# **Contact Information**

**Property Owner** 

Riverwalk, LLC				
Company	Phone #	Email Address  ZACH@NASSARDEVELOPMENT.COM		
NASSAR DELVOPMENT	3037758522			
Mailing Address	City	State Zip		
3000 Airport Drive, Suite 203	ERIE	CO 80516		

## Billing Contact (where invoices should be directed)

Laurie Hurd				
Company Phone # Email Address				
NASSAR DELVOPMENT	3037758522 accounting@nassardevelopment.c		assardevelopment.com	
Mailing Address	City	State	Zip	
3000 Airport Drive, Suite 203	ERIE	СО	80516	

# Representative (i.e., the point of contact)

ADAM CASIAS		
Company	Phone #	Email Address
STUDIO 1	9709489836	ADAM@STUDIO1.COMPANY
Mailing Address	City	State Zip
255 SAINT PAUL STREET	DENVER	CO 80206

# Site Description

Site Address
Parcel Identification Number(s) (PIN)

137 Apres Way

Existing Zone Classification
Site Area (acres and sq. ft.)

R-2 (MULTIPLE FAMILY RESIDENTIAL)

10579 SF

# **Project Description**

Project Name

**LOT 18** 

Brief description of the proposed project

SINGLE FAMILY RESIDENCE WITH ATTACHED GARAGE

# **Required Documents**

For an application to be considered complete and for Planning Division staff to begin review and schedule any applicable public hearings, this Land Use Review Application Form must be fully completed and all required attachments included. Staff will review the application for completeness and notify the representative and/or owner whether the application has been deemed complete.

# Certifications

#### REPRESENTATIVE CERTIFICATION

By signing this application, I attest that I am acting with the knowledge and consent of all owners of the property that is the subject of this application, and that I have been designated to act as the representative for the project described in this land the application. I further certify that all information submitted with this application is true and accurate to the best of my knowledge.

Representative

Date

**ADAM CASIAS** 

2024.06.04

# OWNER CERTIFICATION

I hereby certify that I am the legal owner of record of the property that is the subject of this application. I authorize the representative listed on this application, if any, to communicate directly with Town officials and to submit documentation and information regarding this application on my behalf.

Owner Date

DAVID NASSAR 2024.06.04

In addition to the base fees the applicant is required to pay the cost of any referral agency reviews, public notices, hearings, and record keeping as outlined within § 5-B-6, Application Fees, in the UDC.


Development Improvements Dedications, Agreements, and Guarantees (Article 4.B)	Site Development and Permit Decisions (Article 5.E)
☐ Development Improvements Agreements (DIA)	☐ Major Site Plan*
☐ Public Improvement Cost-Recovery Agreement	Minor Site Plan
Standardized Development Review Procedures (Article 5.B)	Administrative Site Plan
☐ Pre-Application Conference	Special Use Permit (Including High-Impact Short-Term Rentals)*
Renewal of Approvals	Limited Use Authorization
☐ Vested Rights	☐ Temporary Use Permit
Ordinance and Zoning Amendment Decisions (Article 5.C)	☐ Floodplain Development Permit
☐ Text Amendment	☐ Lighting by Special Permit
Rezoning	Parking Reductions and Alternative Parking Plan Permit
Rezoning to Planned Development:  Preliminary Development Plan*	☐ Street Renaming
☐ Final Development Plan* ☐ Amended Final Development Plan*	
	Appeal, Variance, and Interpretation Decisions (Article 5.F)
Amended Final Development Plan*	Appeal, Variance, and Interpretation Decisions
☐ Amended Final Development Plan* ☐ Annexation*	Appeal, Variance, and Interpretation Decisions (Article 5.F)
☐ Amended Final Development Plan* ☐ Annexation*  Subdivision and Platting Decisions (Article 5.D)	Appeal, Variance, and Interpretation Decisions (Article 5.F)  Appeal
<ul> <li>☐ Amended Final Development Plan*</li> <li>☐ Annexation*</li> <li>Subdivision and Platting Decisions (Article 5.D)</li> <li>☐ Exemption Plat</li> </ul>	Appeal, Variance, and Interpretation Decisions (Article 5.F)  Appeal  Appeal of Administrative Decisions
<ul> <li>☐ Amended Final Development Plan*</li> <li>☐ Annexation*</li> <li>Subdivision and Platting Decisions (Article 5.D)</li> <li>☐ Exemption Plat</li> <li>☐ Minor Plat*</li> </ul>	Appeal, Variance, and Interpretation Decisions (Article 5.F)  Appeal  Appeal of Administrative Decisions  Variance*
<ul> <li>☐ Amended Final Development Plan*</li> <li>☐ Annexation*</li> <li>Subdivision and Platting Decisions (Article 5.D)</li> <li>☐ Exemption Plat</li> <li>☐ Minor Plat*</li> <li>☐ Preliminary Plat*</li> </ul>	Appeal, Variance, and Interpretation Decisions (Article 5.F)  Appeal  Appeal of Administrative Decisions  Variance*
☐ Amended Final Development Plan*   ☐ Annexation*   Subdivision and Platting Decisions (Article 5.D)   ☐ Exemption Plat   ☐ Minor Plat*   ☐ Preliminary Plat*   ☐ Final Plat*	Appeal, Variance, and Interpretation Decisions (Article 5.F)  Appeal  Appeal of Administrative Decisions  Variance*
☐ Amended Final Development Plan*   ☐ Annexation*   Subdivision and Platting Decisions (Article 5.D)   ☐ Exemption Plat   ☐ Minor Plat*   ☐ Preliminary Plat*   ☐ Final Plat*   ☐ Resubdivision*	Appeal, Variance, and Interpretation Decisions (Article 5.F)  Appeal  Appeal of Administrative Decisions  Variance*
☐ Amended Final Development Plan*   ☐ Annexation*   Subdivision and Platting Decisions (Article 5.D)   ☐ Exemption Plat   ☐ Minor Plat*   ☐ Preliminary Plat*   ☐ Final Plat*   ☐ Resubdivision*   ☐ Waiver*   ☐ Vacation of Plat, Street, Right of Way, and	Appeal, Variance, and Interpretation Decisions (Article 5.F)  Appeal  Appeal of Administrative Decisions  Variance*




River Walk by Nassar Development LLC
River Walk Owners Association (ROA)
3000 Airport Drive
Unit 203
Erie, CO 80516
303-775-5502
roa@riverwalkwp.com

Narrative - pln24-048 137 Apres Way - Lot 18

- A. Project Name Lot 18
- B. Street Address 137 Apres Way
- C. Name River Walk by Nassar Development LLC
  Address 3000 Airport Drive, Unit 203 Erie, Colorado 80516
  email and telephone number david@nassardevelopment.com, 303-775-5502
  applicant River Walk by Nassar Development LLC
  HOA River Walk Owners Association (ROA)
  project manager Zach Nassar
  architecture ADAM CASIAS, Studio 1
  engineer David Mitchell, Front Range Structural Engineering
  surveyor CORE CONSULTANTS, LLC
  and land planner River Walk by Nassar Development LLC
- D. Legal description A REPLAT OF TRACT F-1, IDLEWILD MINOR SUBDIVISION A PART OF THE SOUTHWEST QUARTER OF THE SOUTHEAST QUARTER OF SECTION 28, TOWNSHIP 1 SOUTH, RANGE 75 WEST OF THE 6TH P.M.TOWN OF WINTER PARK, COUNTY OF GRAND, STATE OF COLORADO
- E. Zoning district R-2 (MULTIPLE FAMILY RESIDENTIAL)
- F. Lot size 10579 SF
- G. All proposed uses single family residence
- H. Number of dwelling units 1
- I. Number of bedrooms per dwelling unit 5
- J. Size of residential space 7500 sf
- K. Number of proposed off-street parking spaces 1
- L. Construction schedule indicating major milestones for project Start Construction 09.01.2024

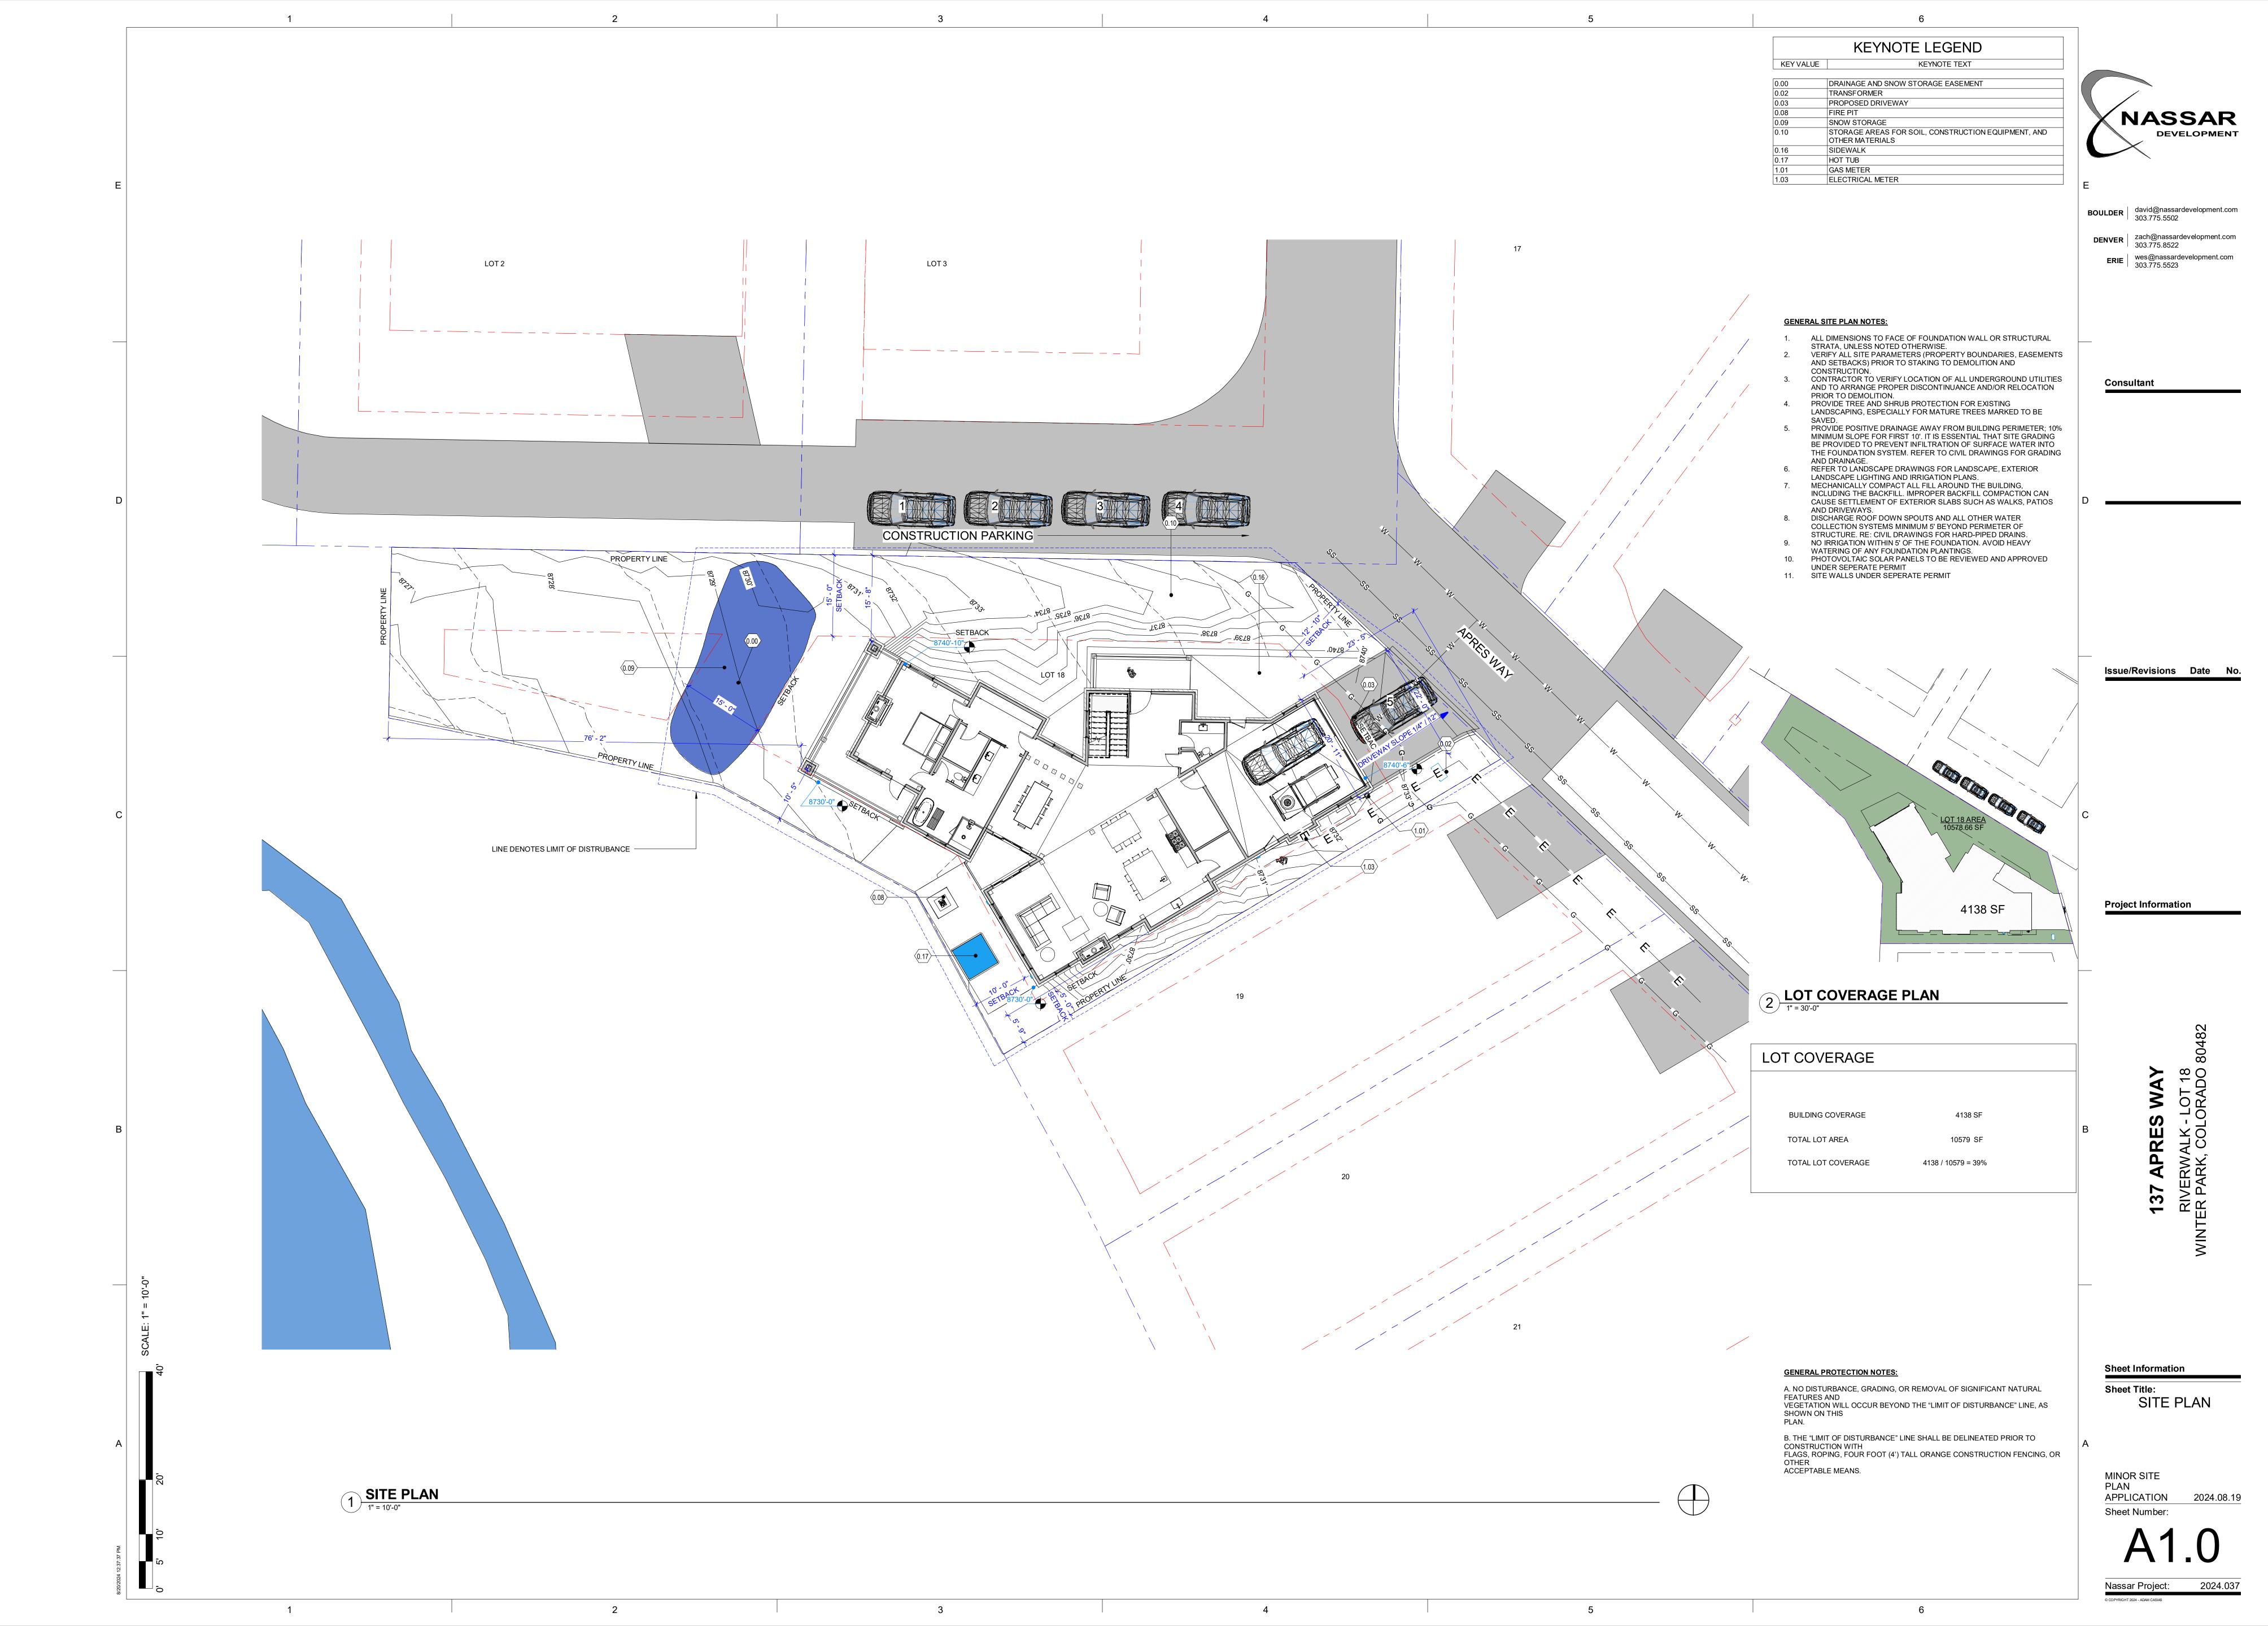



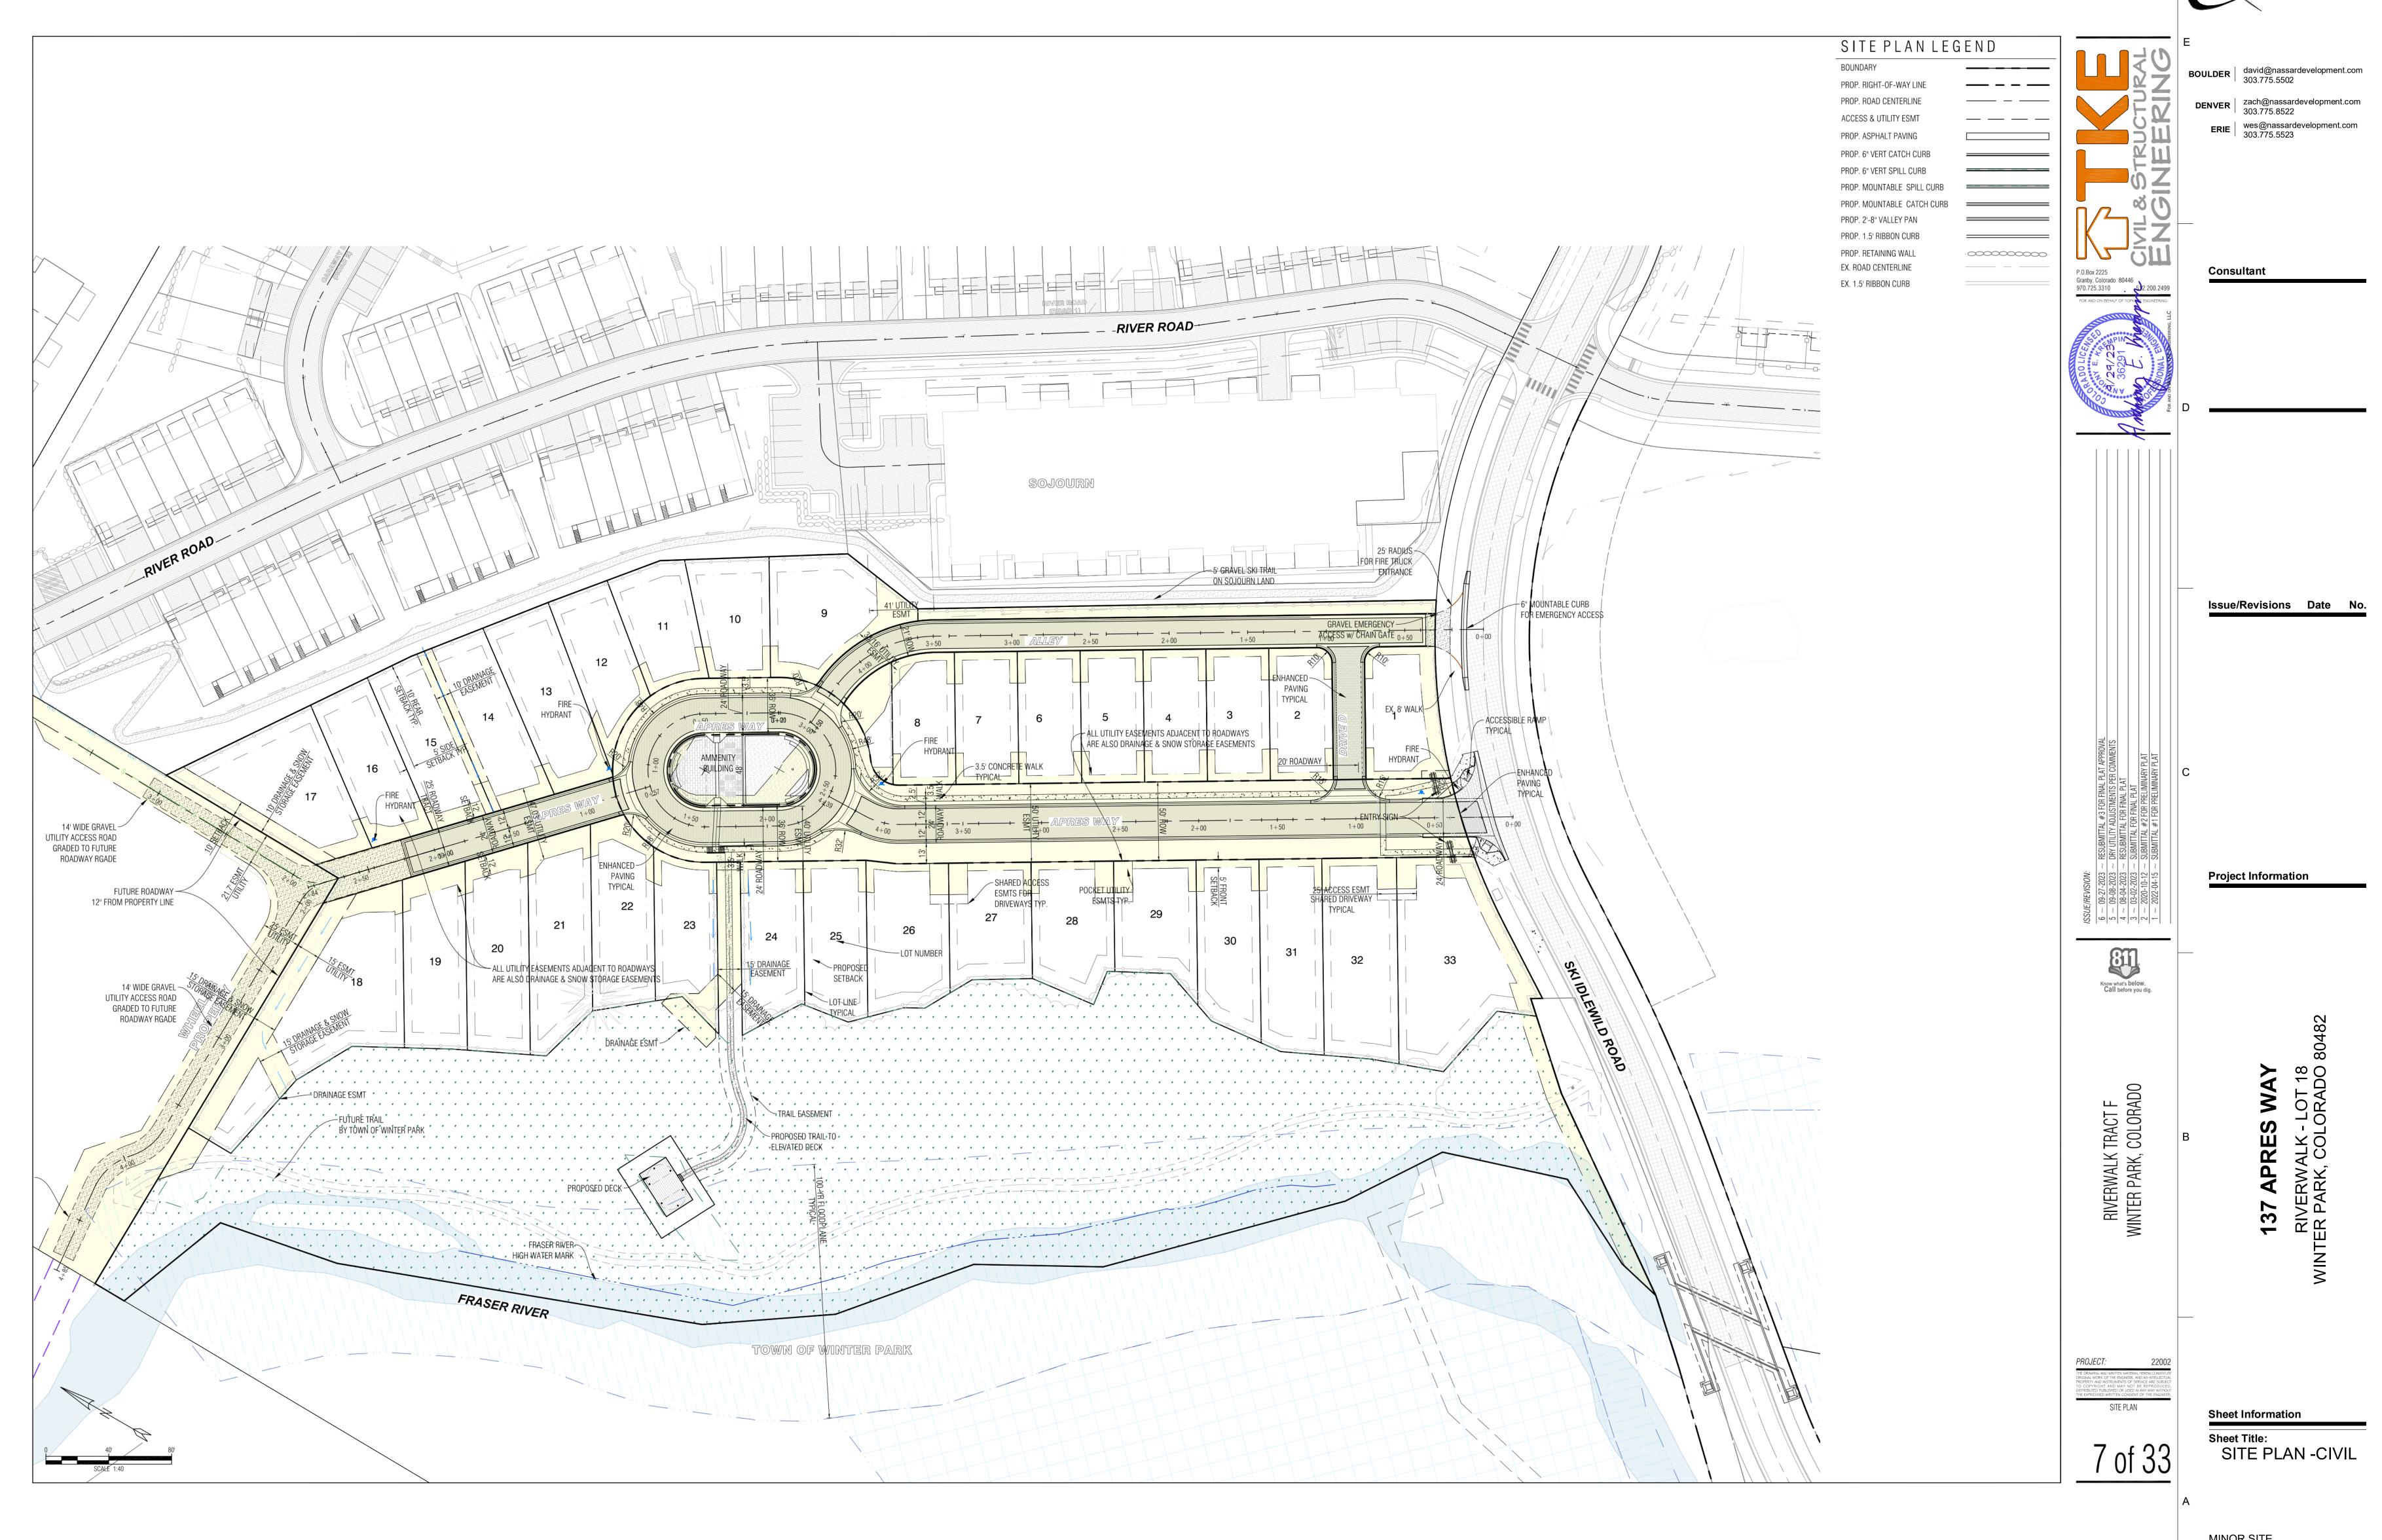


1 SITE PLAN - CIVIL
1" = 20'-0"

MINOR SITE
PLAN
APPLICATION 2024.08.19
Sheet Number:

Nassar Project: 2024 0

Nassar Project: 2024.0

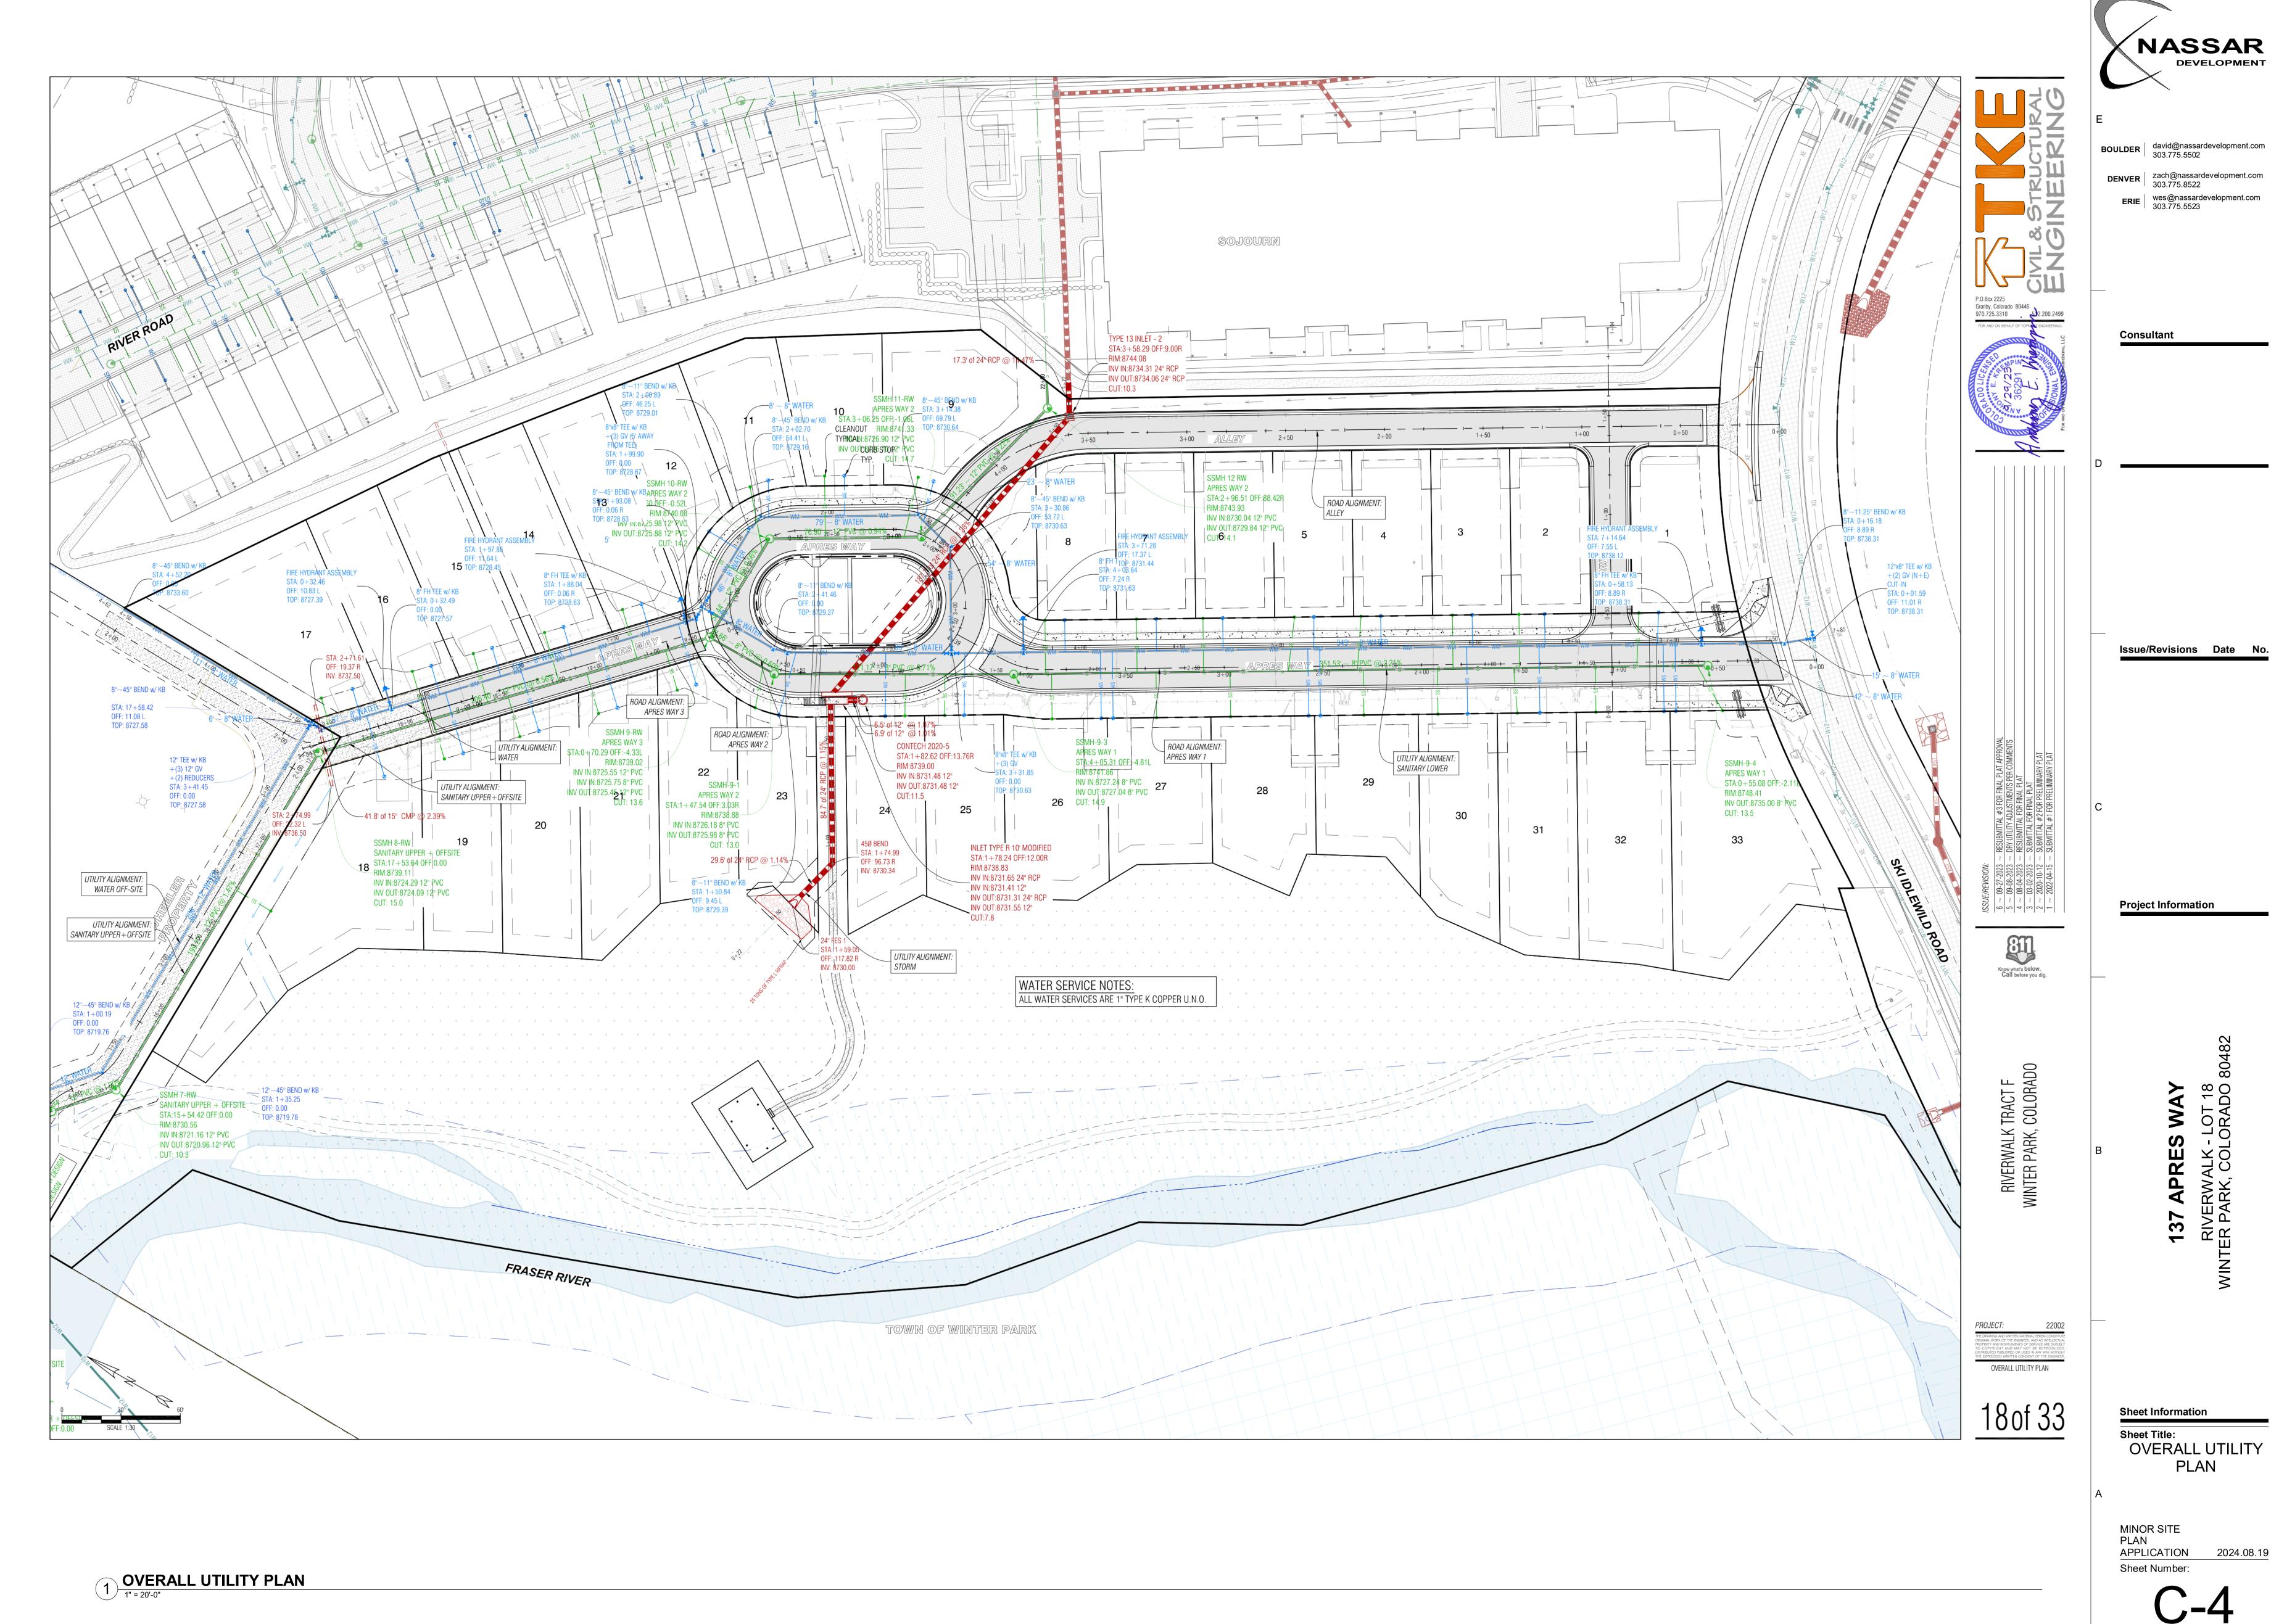



BOULDER david@nassardevelopment.com 303.775.5502

**DENVER** zach@nassardevelopment.com 303.775.8522

ERIE wes@nassardevelopment.com 303.775.5523



1 GRADING AND DRAINGE PLAN - SITE

siteworks

creativity for the built environment

Consultant

OR ADO LICENSTILLING 36045

— Issue/Revisions Date No.

**Project Information** 

137 Apres Way Winter Park, Co

# Date Description1 07/23/24 Grading Plan

 Project No:
 22206C

 By:
 DRS/DPA

 File:
 22206C-1 Lot 18\*.dwg

Grading,
Drainage and
Erosion Control
Plan

C-101

Sheet Information

137


Sheet Title:
GRADING,
DRAINAGE - SITE

MINOR SITE
PLAN
APPLICATION 2024.08.19
Sheet Number:

C-101


Nassar Project: 2024.037

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Nassar Project: 2024.037

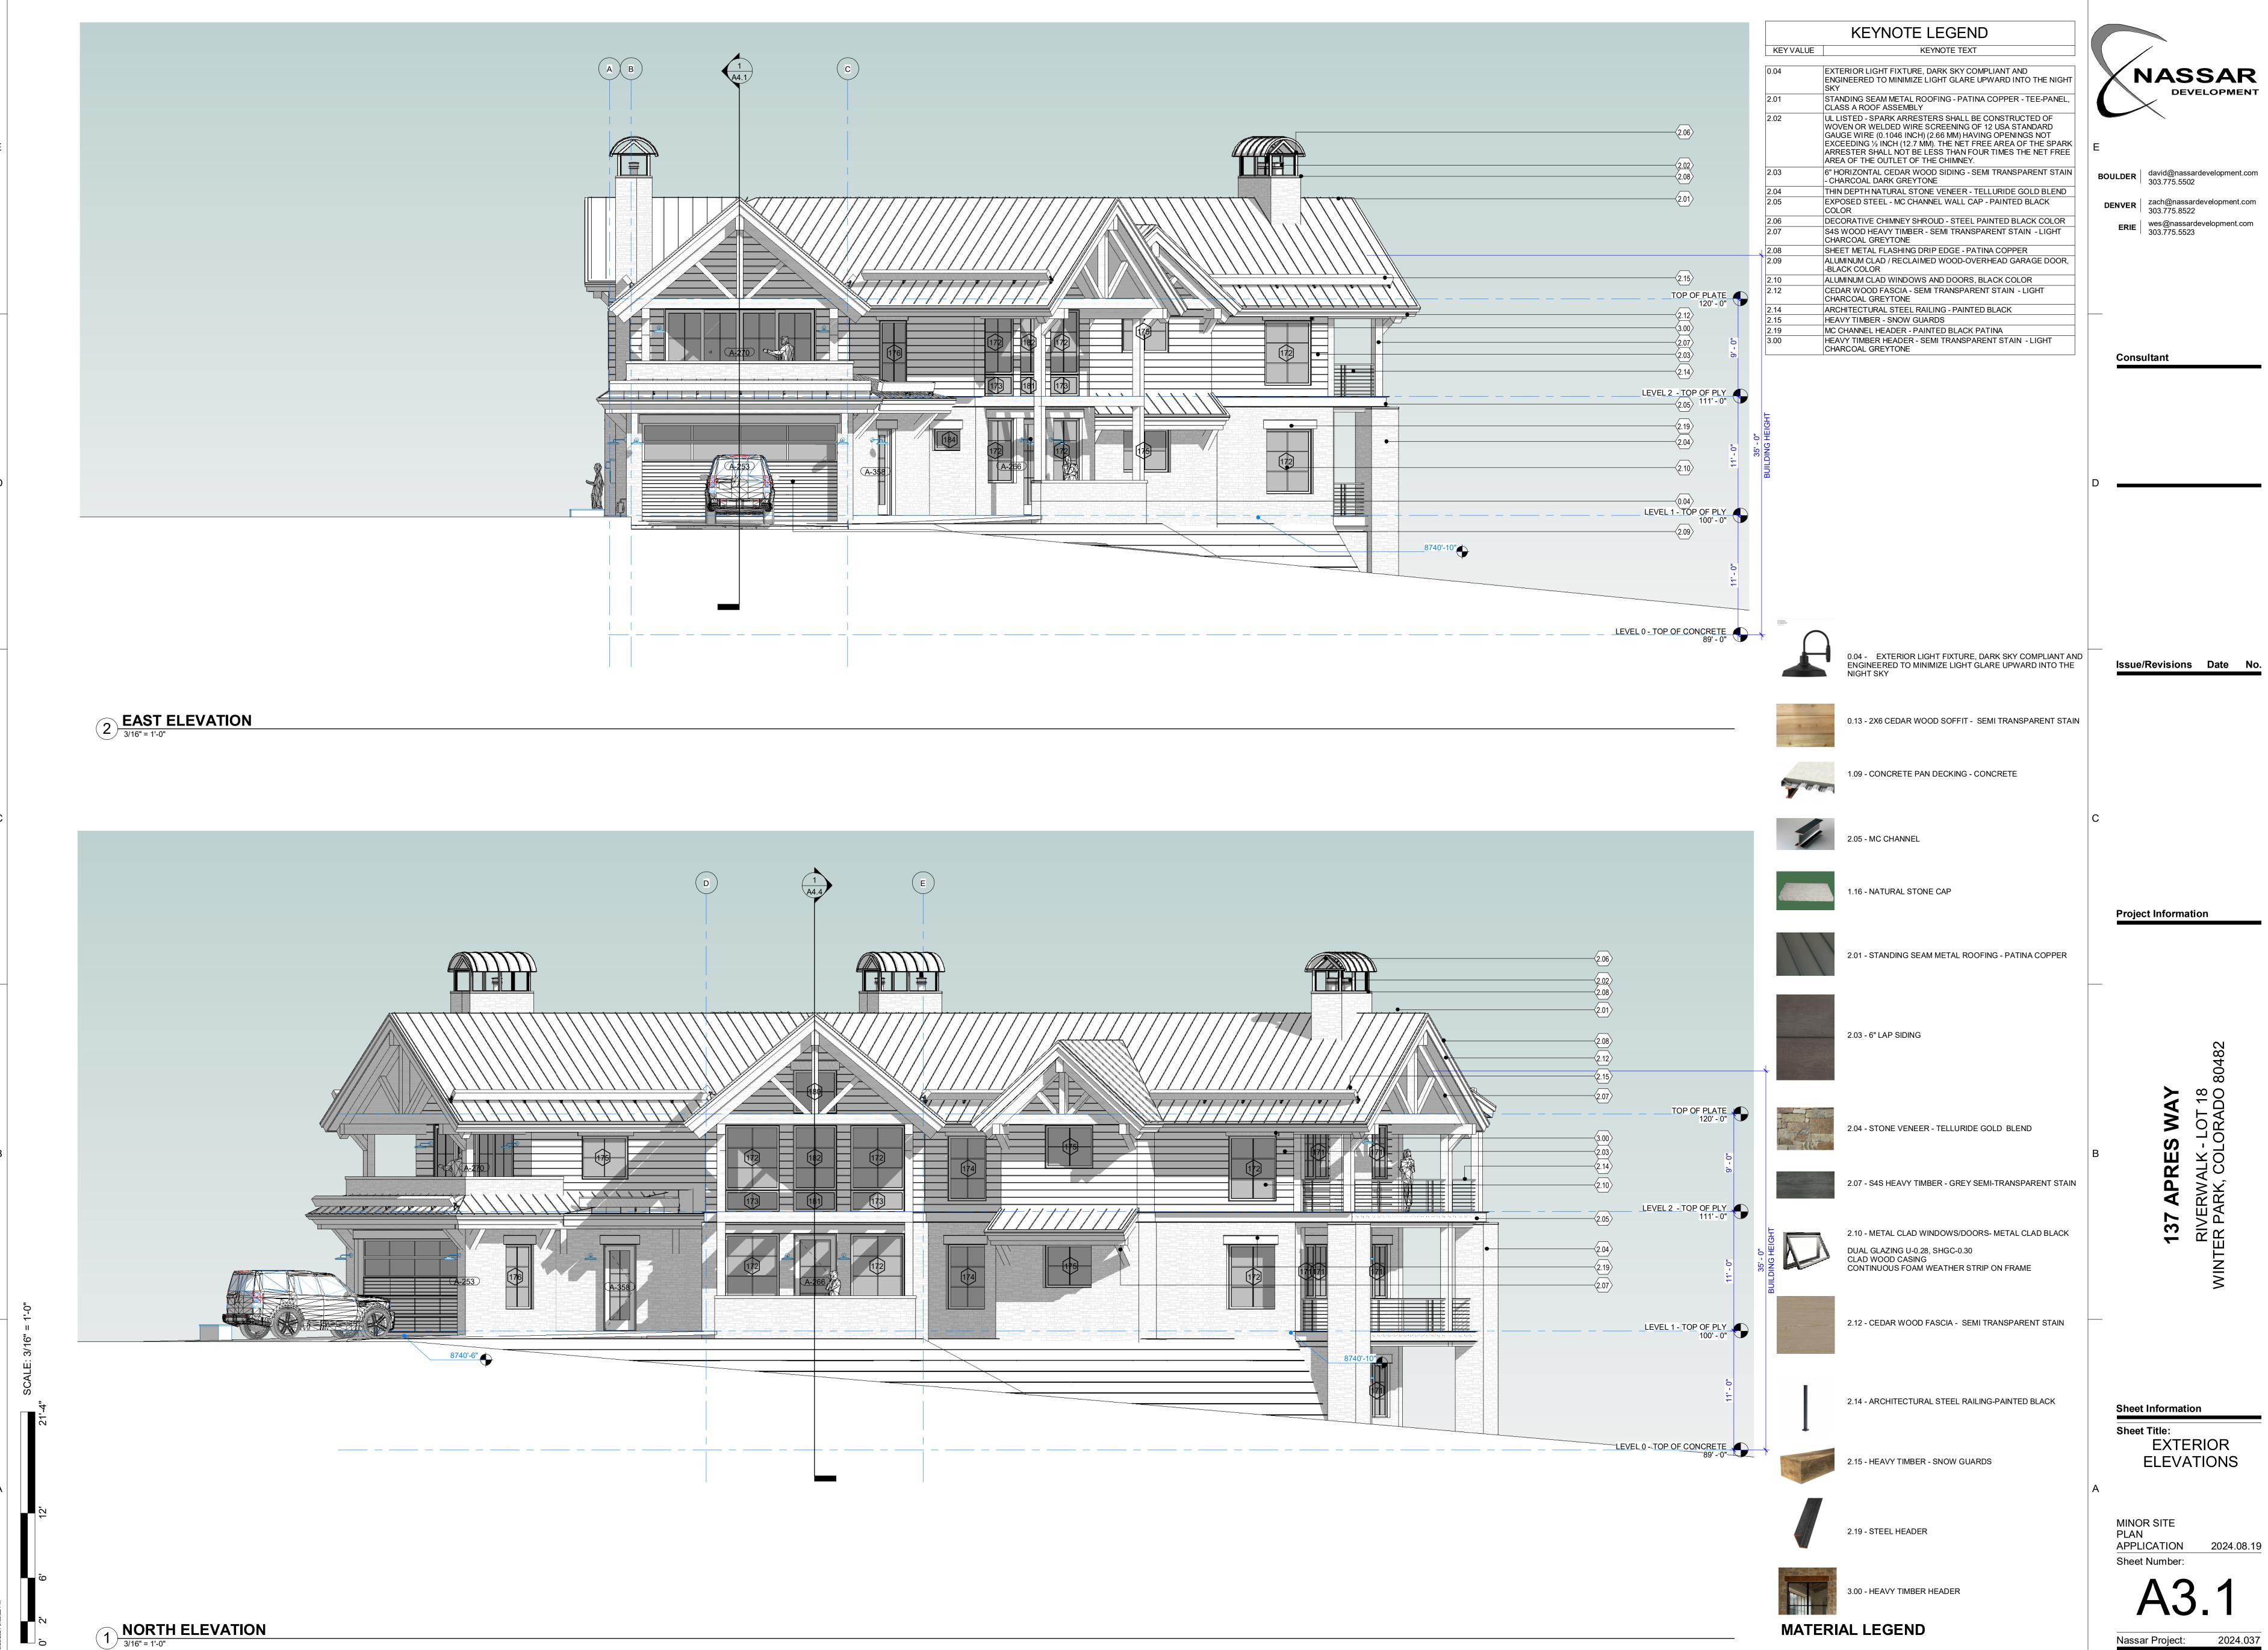



	KEYNOTE LEGEND
KEY VALUE	KEYNOTE TEXT
0.04	EXTERIOR LIGHT FIXTURE, DARK SKY COMPLIANT AND ENGINEERED TO MINIMIZE LIGHT GLARE UPWARD INTO THE NICSKY
2.01	STANDING SEAM METAL ROOFING - PATINA COPPER - TEE-PANE CLASS A ROOF ASSEMBLY
2.04	THIN DEPTH NATURAL STONE VENEER - TELLURIDE GOLD BLEN
2.07	S4S WOOD HEAVY TIMBER - SEMI TRANSPARENT STAIN - LIGHT CHARCOAL GREYTONE
2.08	SHEET METAL FLASHING DRIP EDGE - PATINA COPPER
2.10	ALUMINUM CLAD WINDOWS AND DOORS, BLACK COLOR
2.12	CEDAR WOOD FASCIA - SEMI TRANSPARENT STAIN - LIGHT CHARCOAL GREYTONE
2.15	HEAVY TIMBER - SNOW GUARDS
2.19	MC CHANNEL HEADER - PAINTED BLACK PATINA
3.00	HEAVY TIMBER HEADER - SEMI TRANSPARENT STAIN - LIGHT CHARCOAL GREYTONE

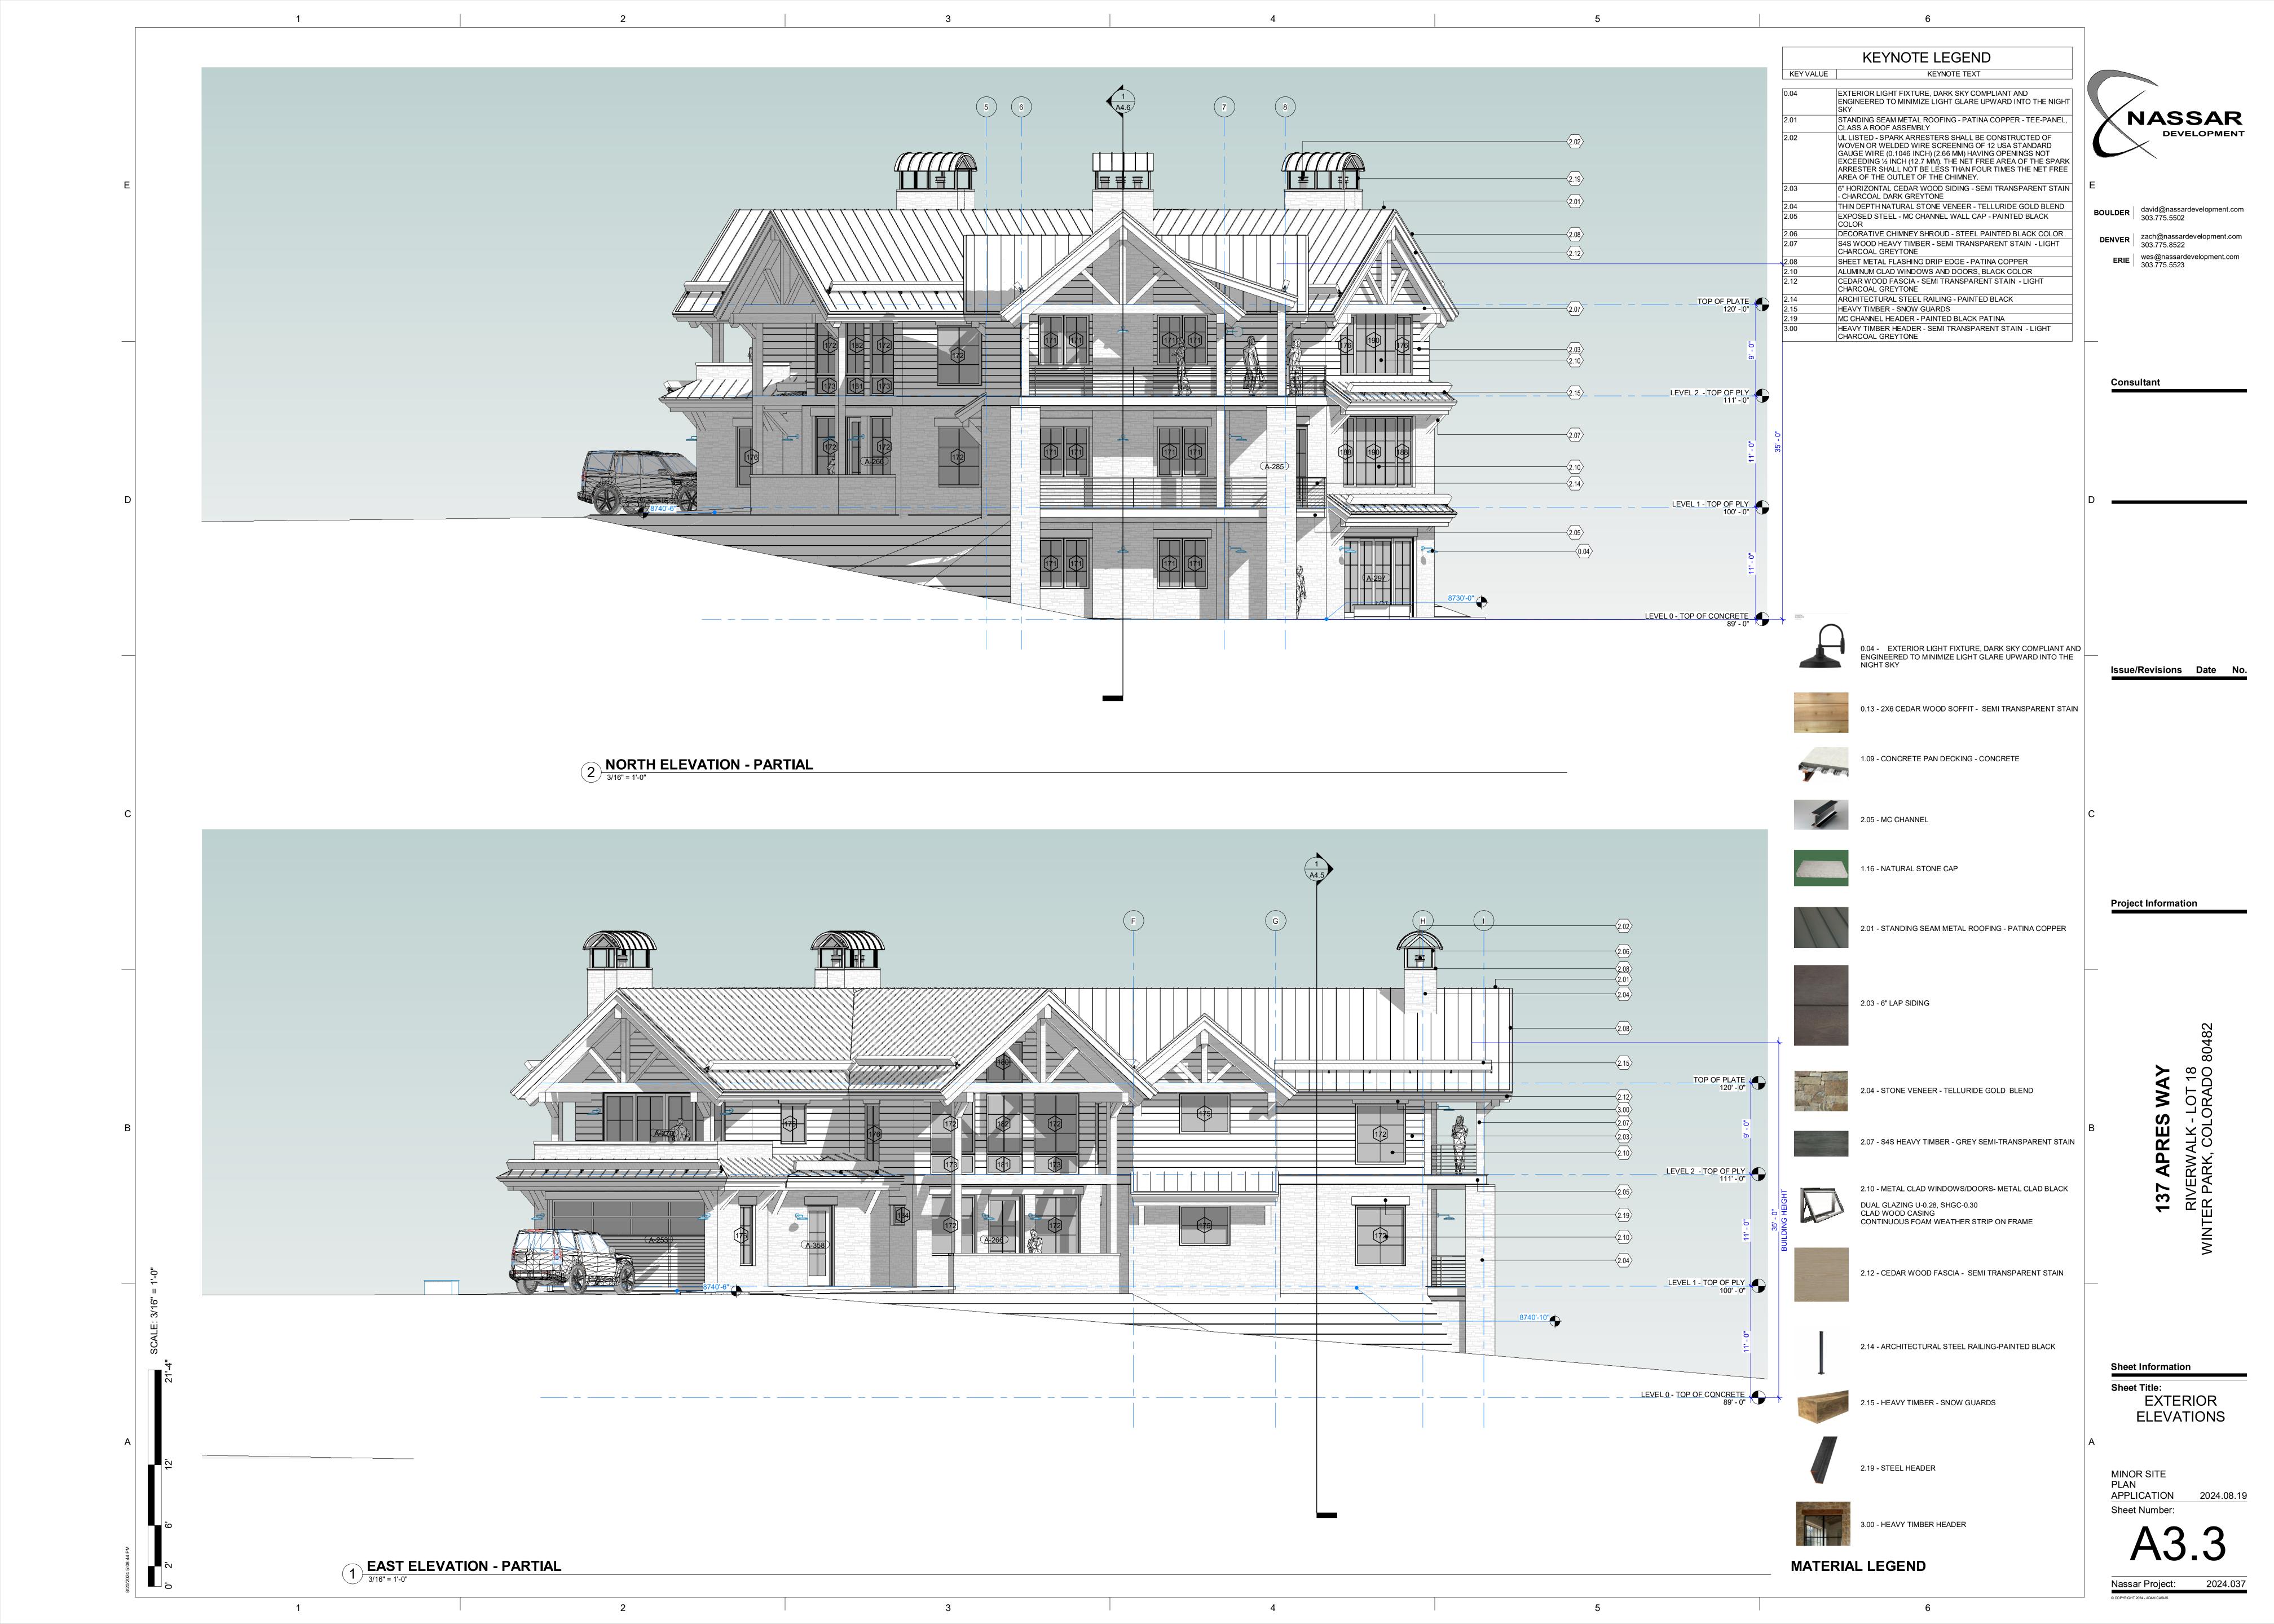

BOULDER david@nassardevelopment.com 303.775.5502

DENVER | zach@nassardevelopment.com 303.775.8522

ERIE | wes@nassardevelopment.com 303.775.5523

Consultant

Issue/Revisions Date No

Project Information

0.04 - EXTERIO ENGINEERED TO NIGHT SKY

0.04 - EXTERIOR LIGHT FIXTURE, DARK SKY COMPLIANT AND ENGINEERED TO MINIMIZE LIGHT GLARE UPWARD INTO THE NIGHT SKY

0.13 - 2X6 CEDAR WOOD SOFFIT - SEMI TRANSPARENT STAIN

1.09 - CONCRETE PAN DECKING - CONCRETE

1.16 - NATURAL STONE CAP

1.10 TVTTGTVTE GTGTVE GTG

2.01 - STANDING SEAM METAL ROOFING - PATINA COPPER

2.03 - 6" LAP SIDING

2.03 - 6" LAP SIDING

2.04 - STONE VENEER - TELLURIDE GOLD BLEND

2.07 - S4S HEAVY TIMBER - GREY SEMI-TRANSPARENT STAIN

2.10 - METAL CLAD WINDOWS/DOORS- METAL CLAD BLACK

DUAL GLAZING U-0.28, SHGC-0.30

CLAD WOOD CASING

CONTINUOUS FOAM WEATHER STRIP ON FRAME

2.12 - CEDAR WOOD FASCIA - SEMI TRANSPARENT STAIN

2.14 - ARCHITECTURAL STEEL RAILING-PAINTED BLACK

1

2.15 - HEAVY TIMBER - SNOW GUARDS

2.19 - STEEL HEADER

200 HEAVY TIMBER HEADER

3.00 - HEAVY TIMBER HEADER

**MATERIAL LEGEND** 

Sheet Title:
EXTERIOR
ELEVATIONS

A

MINOR SITE
PLAN
APPLICATION 2024.08.19
Sheet Number:

**Sheet Information** 

137

A3.4

Nassar Project: 20





KEYNOTE LEGEND KEYNOTE TEXT KEY VALUE STANDING SEAM METAL ROOFING - PATINA COPPER - TEE-PANEL, CLASS A ROOF ASSEMBLY 6" HORIZONTAL CEDAR WOOD SIDING - SEMI TRANSPARENT STAIN - CHARCOAL DARK GREYTONE THIN DEPTH NATURAL STONE VENEER - TELLURIDE GOLD BLEND EXPOSED STEEL - MC CHANNEL WALL CAP - PAINTED BLACK DECORATIVE CHIMNEY SHROUD - STEEL PAINTED BLACK COLOR S4S WOOD HEAVY TIMBER - SEMI TRANSPARENT STAIN - LIGHT CHARCOAL GREYTONE ALUMINUM CLAD WINDOWS AND DOORS, BLACK COLOR CEDAR WOOD FASCIA - SEMI TRANSPARENT STAIN - LIGHT CHARCOAL GREYTONE ARCHITECTURAL STEEL RAILING - PAINTED BLACK HEAVY TIMBER - SNOW GUARDS MC CHANNEL HEADER - PAINTED BLACK PATINA HEAVY TIMBER HEADER - SEMI TRANSPARENT STAIN - LIGHT CHARCOAL GREYTONE



0.04 - EXTERIOR LIGHT FIXTURE, DARK SKY COMPLIANT AND ENGINEERED TO MINIMIZE LIGHT GLARE UPWARD INTO THE



0.13 - 2X6 CEDAR WOOD SOFFIT - SEMI TRANSPARENT STAIN



1.09 - CONCRETE PAN DECKING - CONCRETE





1.16 - NATURAL STONE CAP



2.01 - STANDING SEAM METAL ROOFING - PATINA COPPER



2.03 - 6" LAP SIDING



2.04 - STONE VENEER - TELLURIDE GOLD BLEND



2.07 - S4S HEAVY TIMBER - GREY SEMI-TRANSPARENT STAIN



2.10 - METAL CLAD WINDOWS/DOORS- METAL CLAD BLACK DUAL GLAZING U-0.28, SHGC-0.30 CLAD WOOD CASING CONTINUOUS FOAM WEATHER STRIP ON FRAME



2.12 - CEDAR WOOD FASCIA - SEMI TRANSPARENT STAIN



2.14 - ARCHITECTURAL STEEL RAILING-PAINTED BLACK



2.15 - HEAVY TIMBER - SNOW GUARDS



2.19 - STEEL HEADER



3.00 - HEAVY TIMBER HEADER

**MATERIAL LEGEND** 

MATERIAL VIEW

1/4" = 1'-0"

Project title: 137 APRES WAY

Project Number: 2024.037

RIVERWALK - LOT 18
WINTER PARK, COLORADO 80482
Project Issue: MINOR SITE PLAN APPLICATION



KEYNOTE LEGEND KEYNOTE TEXT KEY VALUE STANDING SEAM METAL ROOFING - PATINA COPPER - TEE-PANEL, CLASS A ROOF ASSEMBLY 6" HORIZONTAL CEDAR WOOD SIDING - SEMI TRANSPARENT STAIN - CHARCOAL DARK GREYTONE THIN DEPTH NATURAL STONE VENEER - TELLURIDE GOLD BLEND EXPOSED STEEL - MC CHANNEL WALL CAP - PAINTED BLACK DECORATIVE CHIMNEY SHROUD - STEEL PAINTED BLACK COLOR S4S WOOD HEAVY TIMBER - SEMI TRANSPARENT STAIN - LIGHT CHARCOAL GREYTONE ALUMINUM CLAD WINDOWS AND DOORS, BLACK COLOR CEDAR WOOD FASCIA - SEMI TRANSPARENT STAIN - LIGHT CHARCOAL GREYTONE ARCHITECTURAL STEEL RAILING - PAINTED BLACK HEAVY TIMBER - SNOW GUARDS MC CHANNEL HEADER - PAINTED BLACK PATINA HEAVY TIMBER HEADER - SEMI TRANSPARENT STAIN - LIGHT CHARCOAL GREYTONE



0.04 - EXTERIOR LIGHT FIXTURE, DARK SKY COMPLIANT AND ENGINEERED TO MINIMIZE LIGHT GLARE UPWARD INTO THE



0.13 - 2X6 CEDAR WOOD SOFFIT - SEMI TRANSPARENT STAIN



1.09 - CONCRETE PAN DECKING - CONCRETE





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2.01 - STANDING SEAM METAL ROOFING - PATINA COPPER



2.03 - 6" LAP SIDING



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2.15 - HEAVY TIMBER - SNOW GUARDS



2.19 - STEEL HEADER



3.00 - HEAVY TIMBER HEADER

**MATERIAL LEGEND** 


MATERIAL VIEW


1/4" = 1'-0"


Project title: 137 APRES WAY


Project Number: 2024.037

RIVERWALK - LOT 18
WINTER PARK, COLORADO 80482
Project Issue: MINOR SITE PLAN APPLICATION

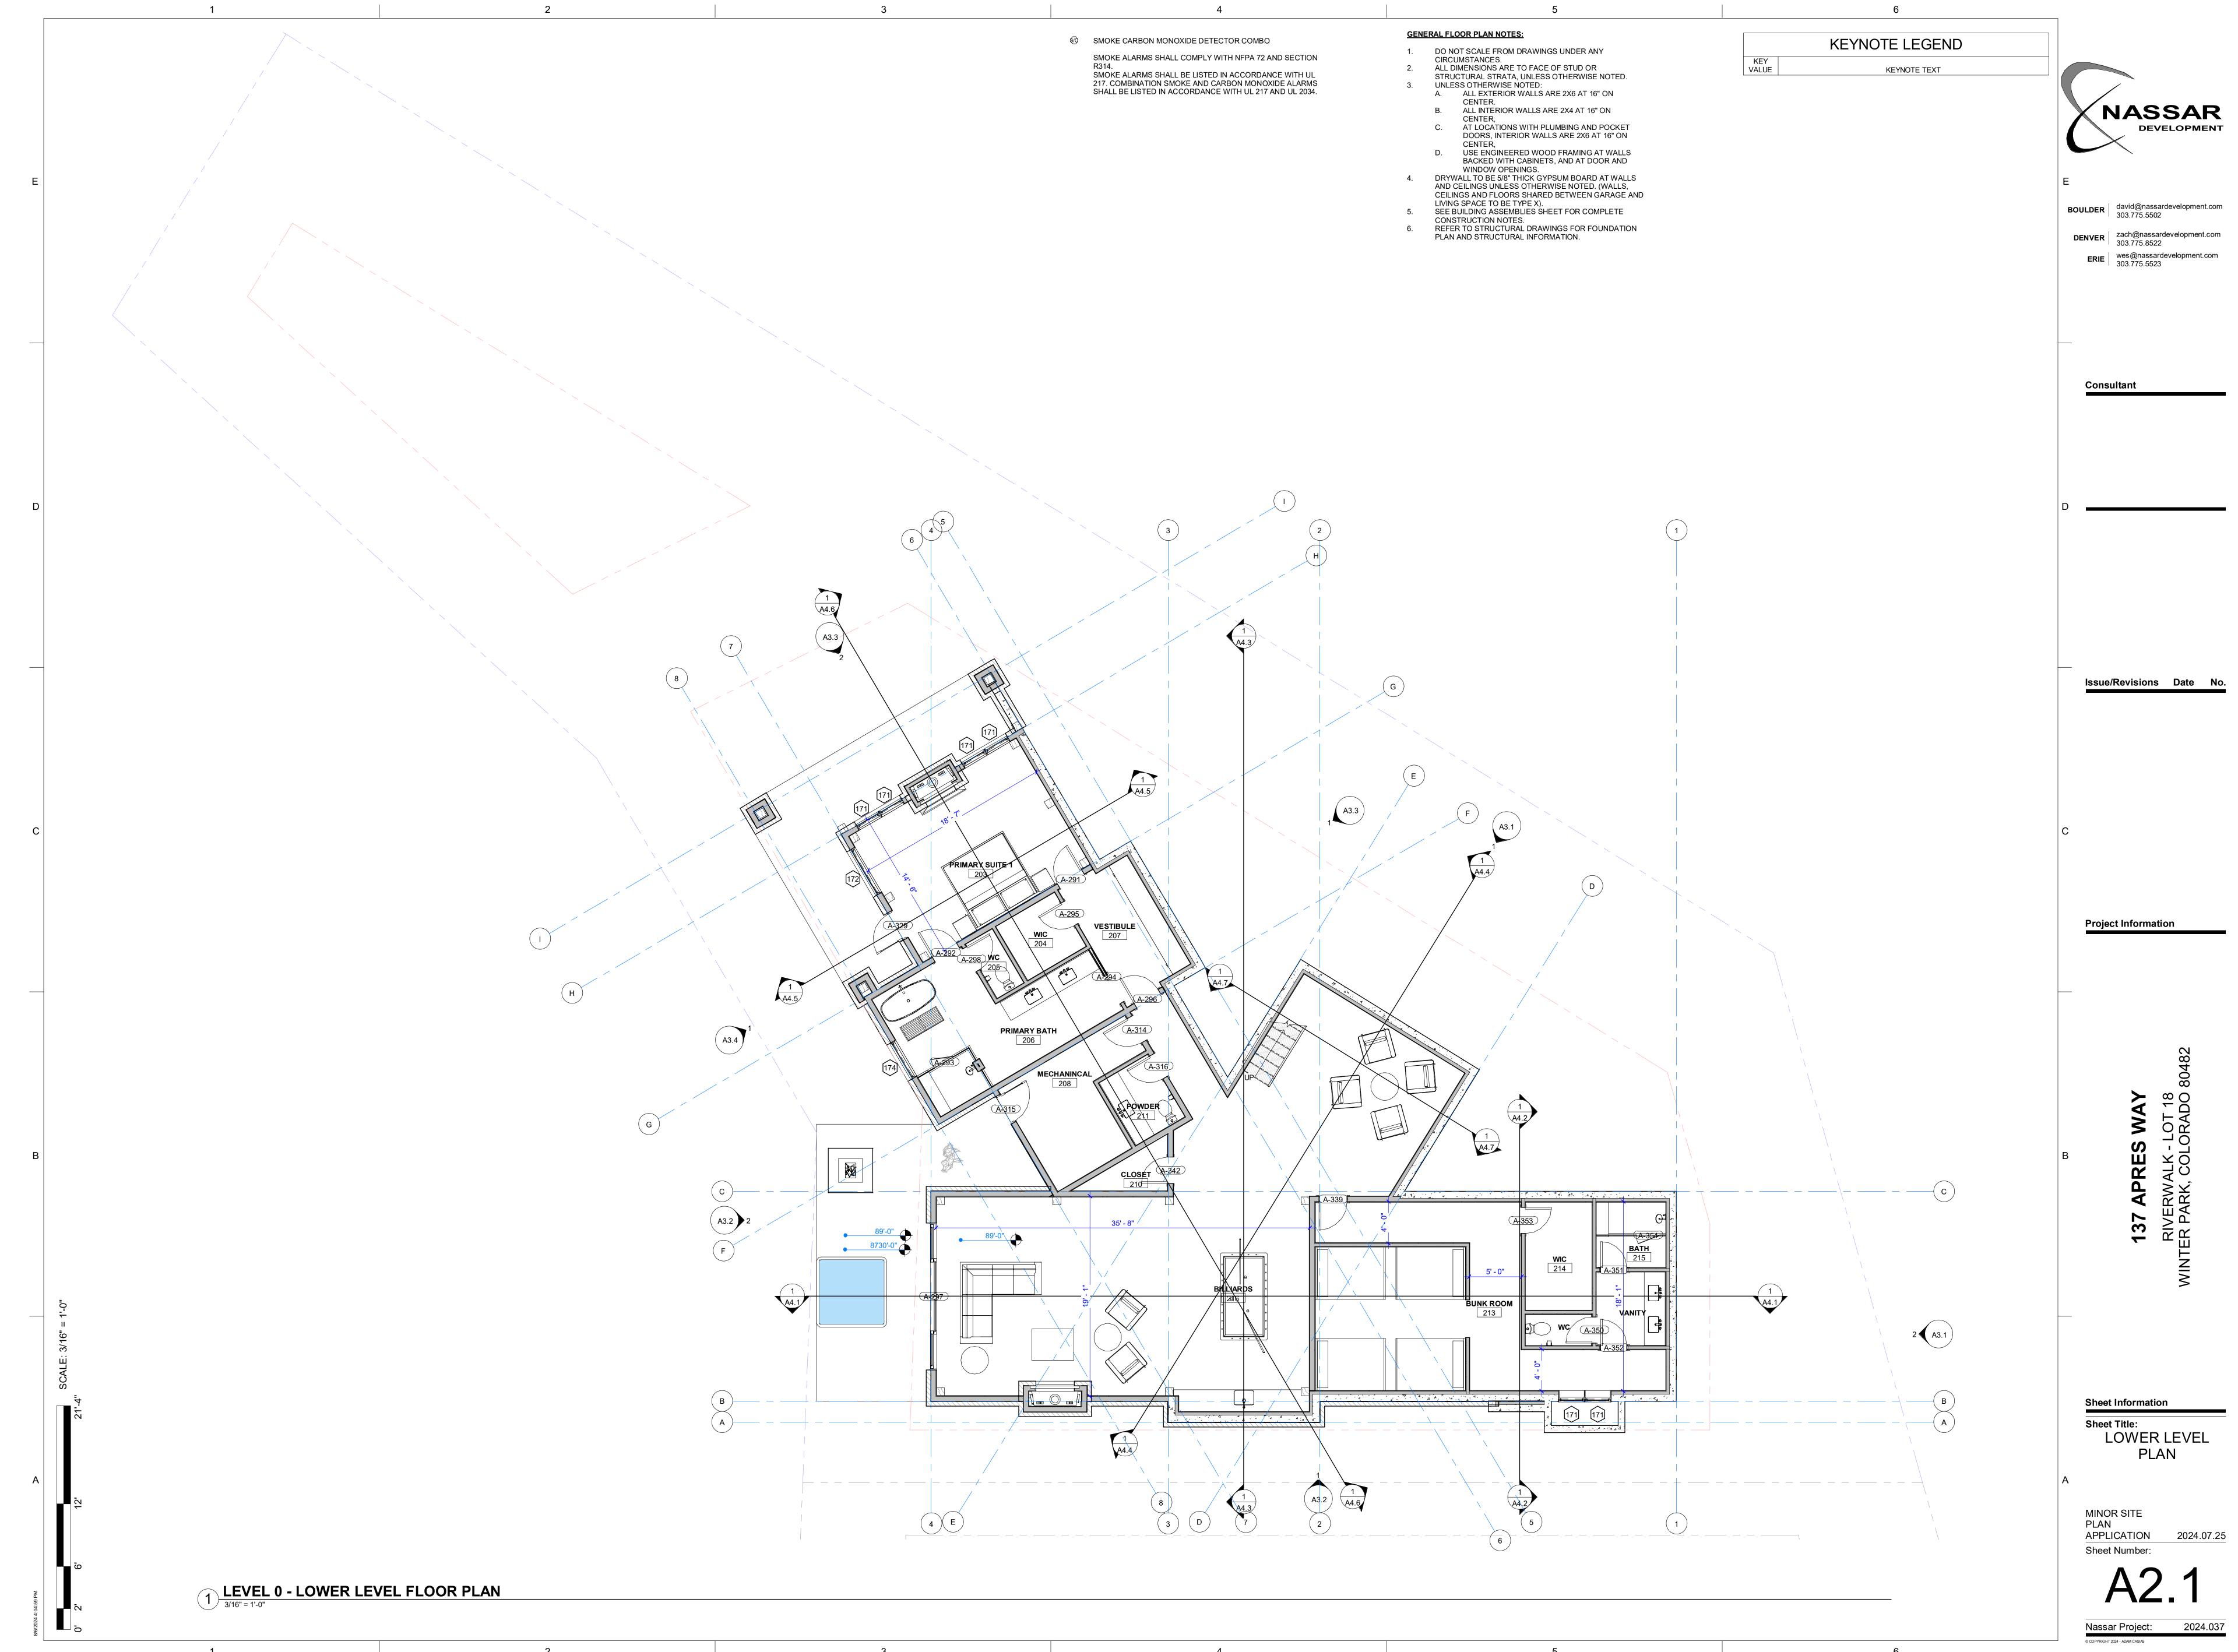

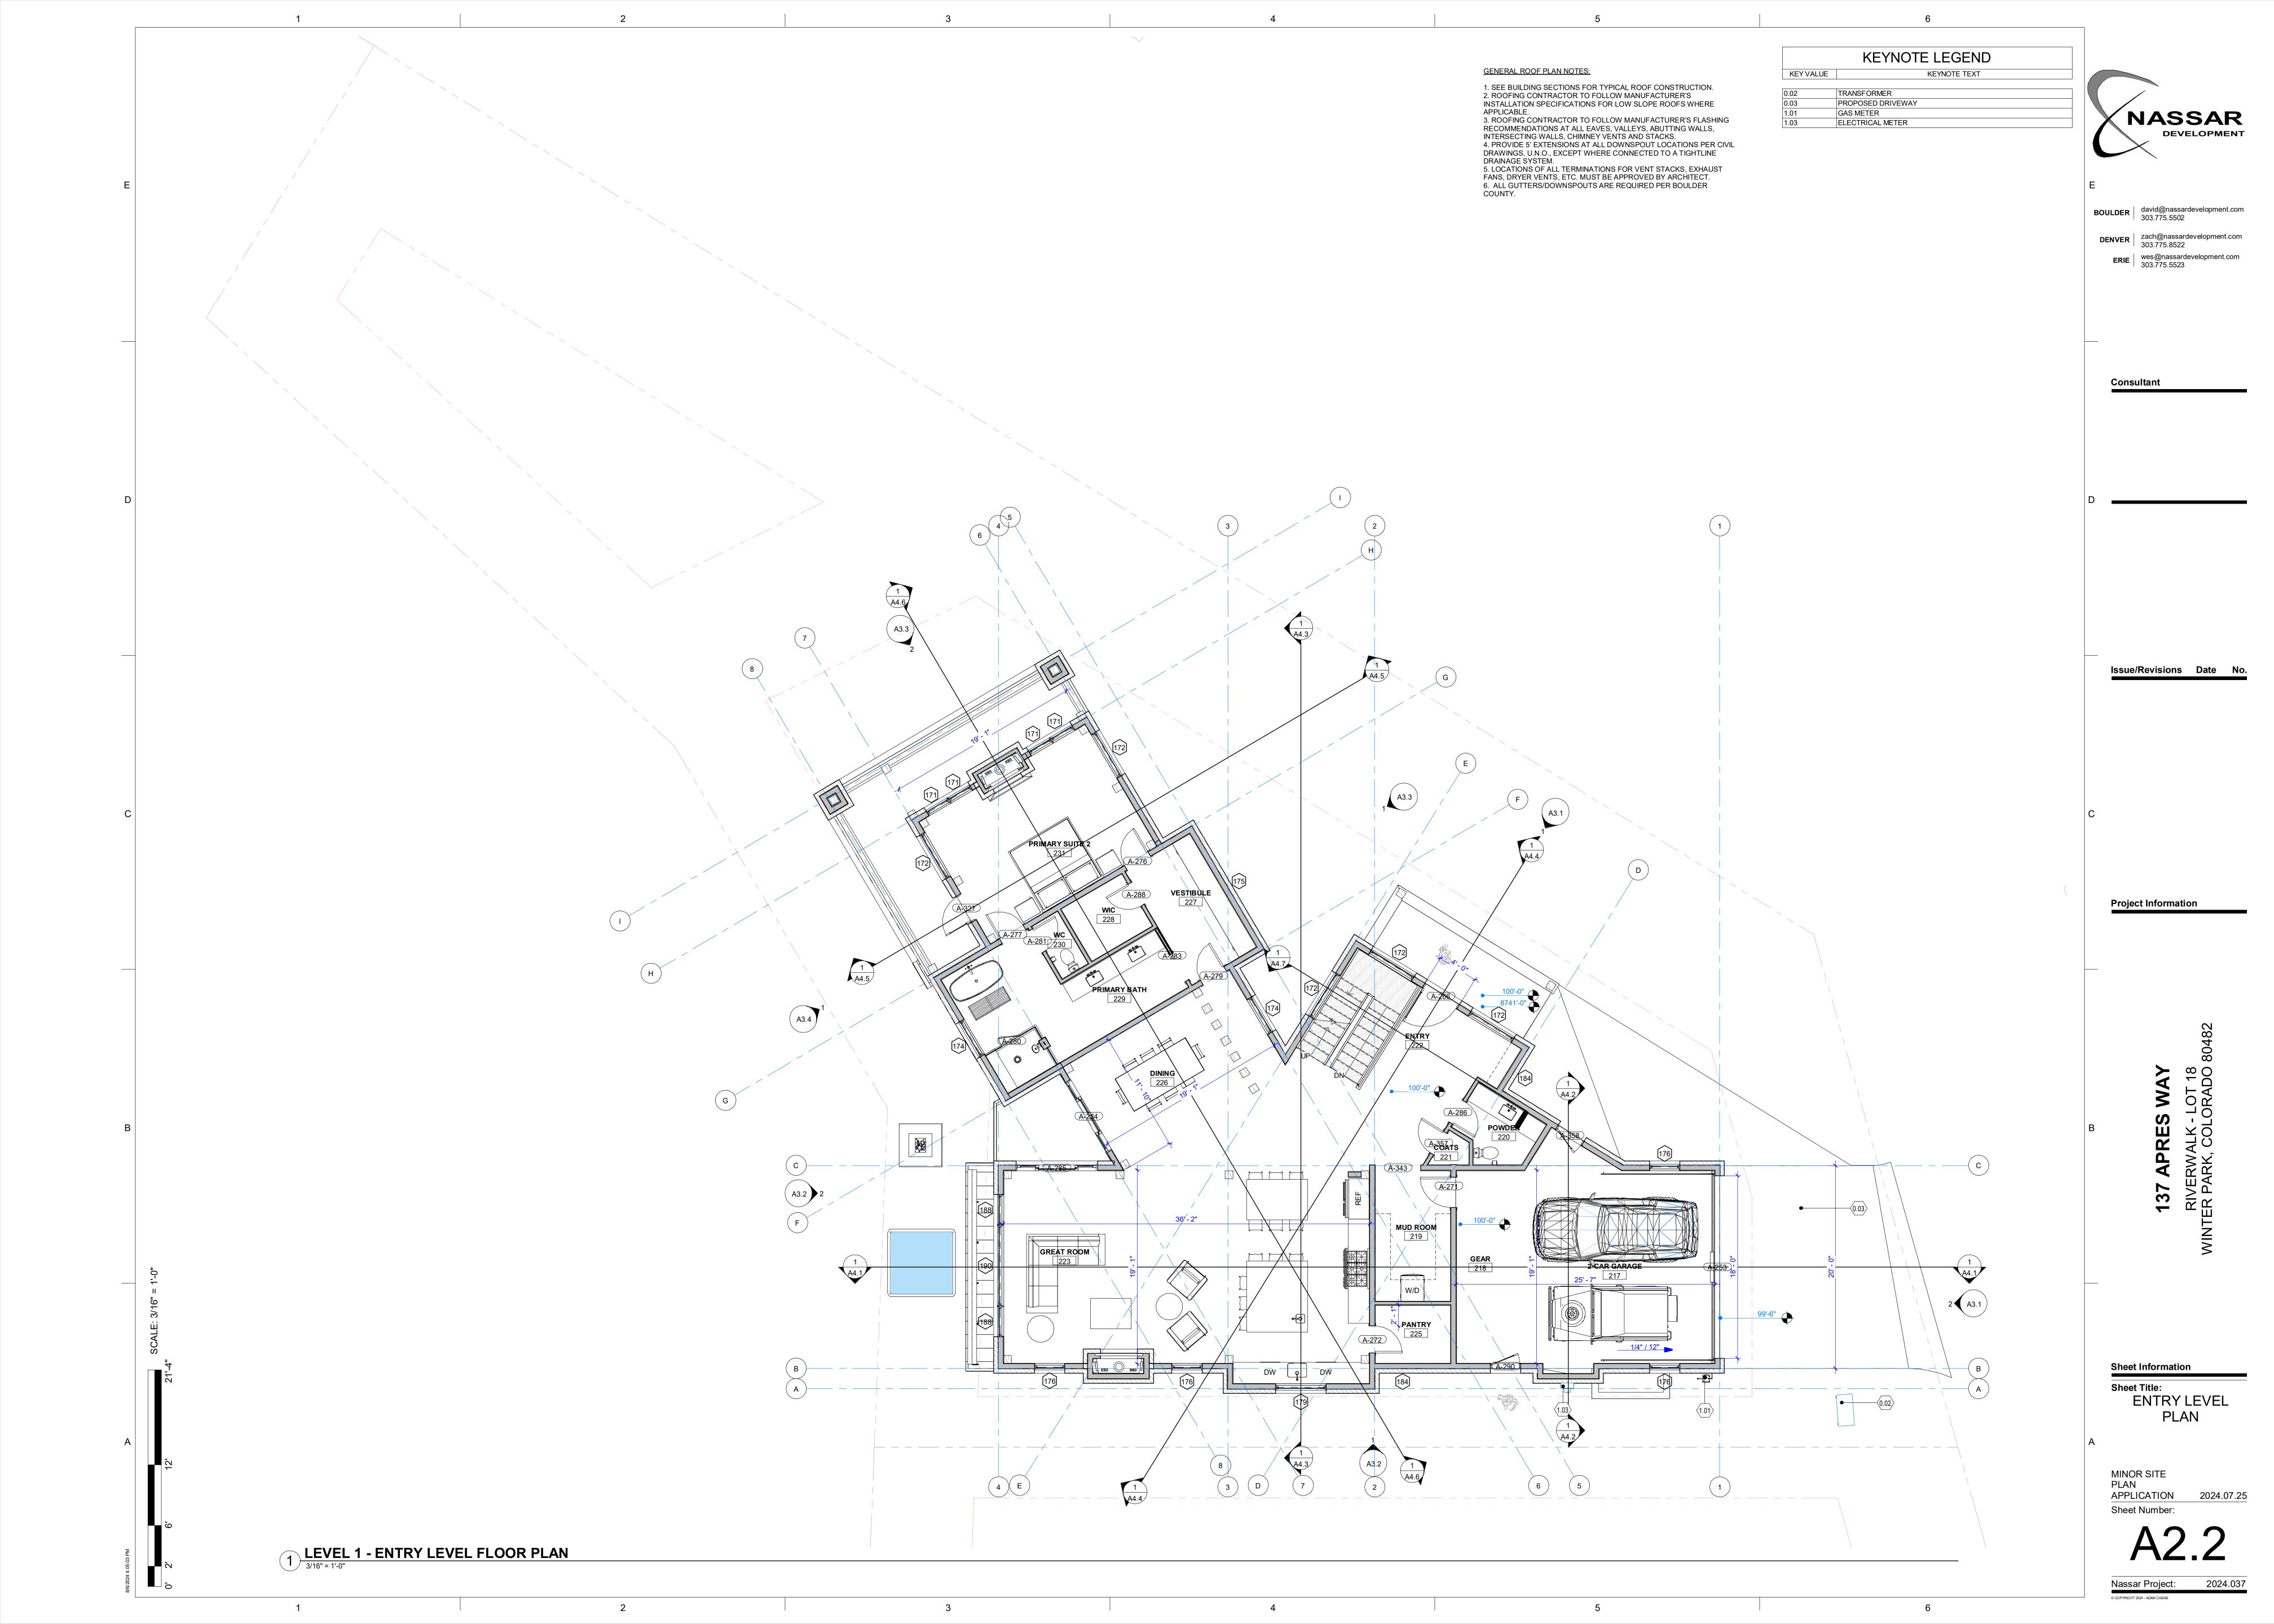

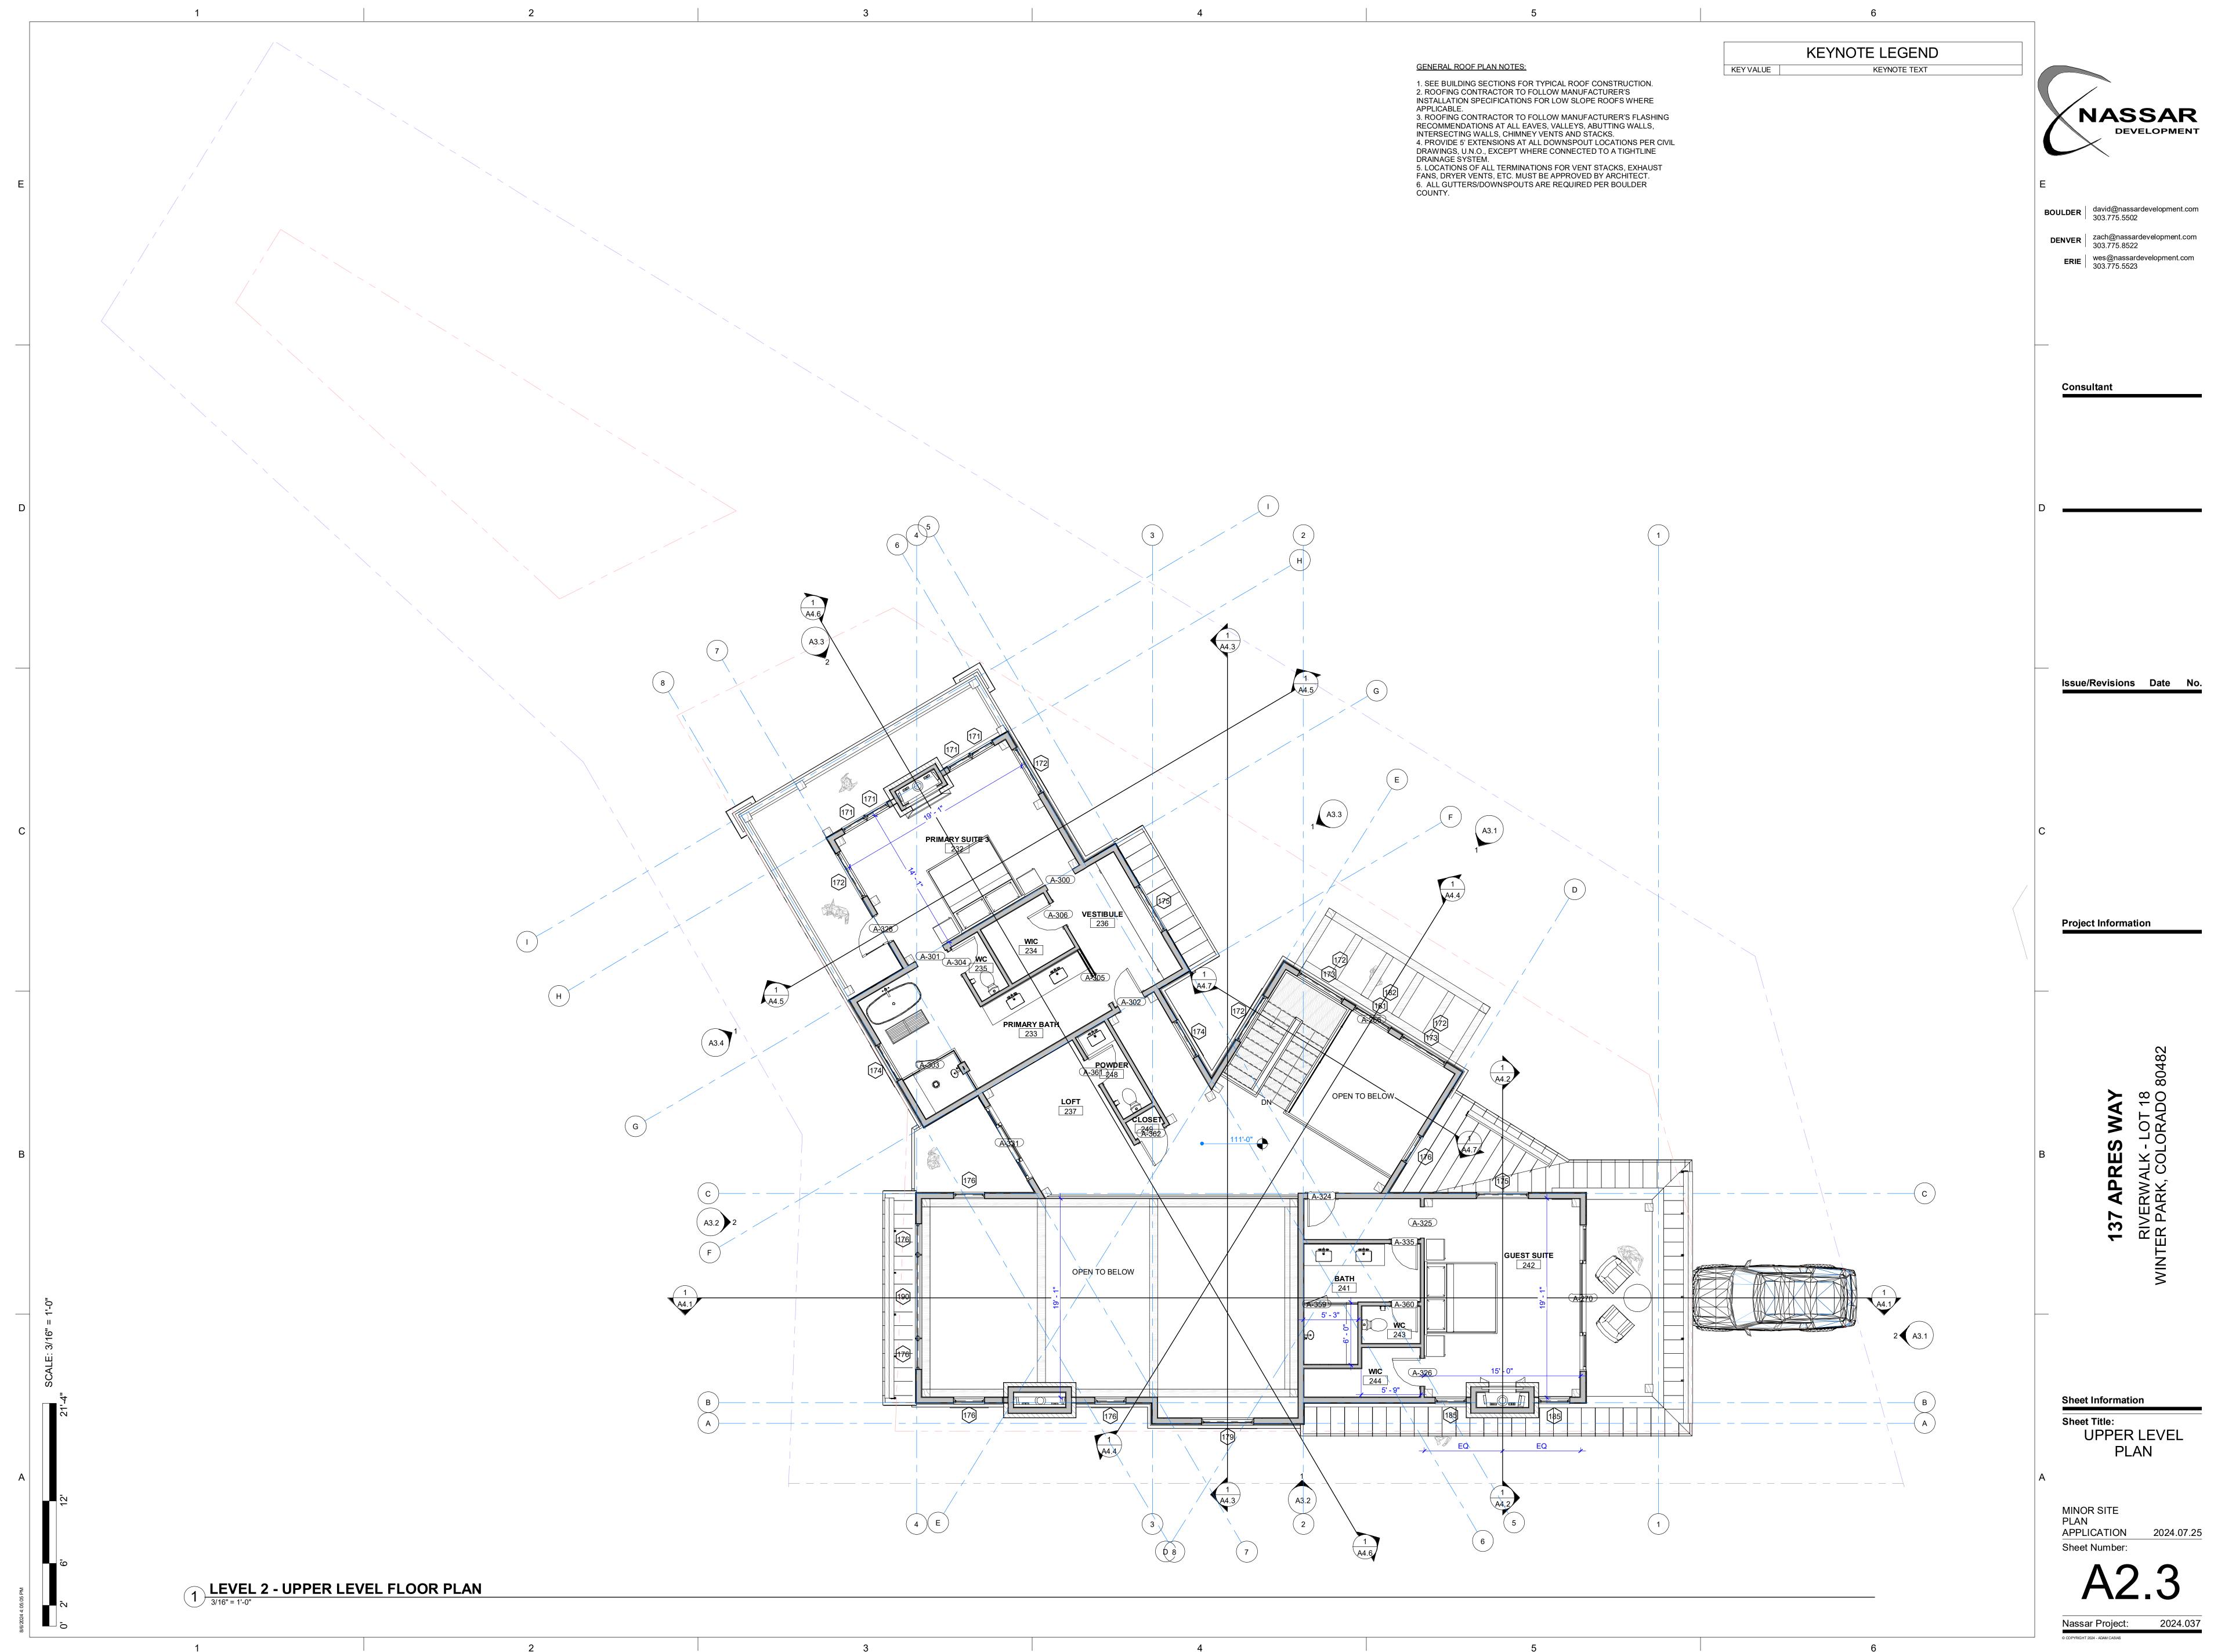

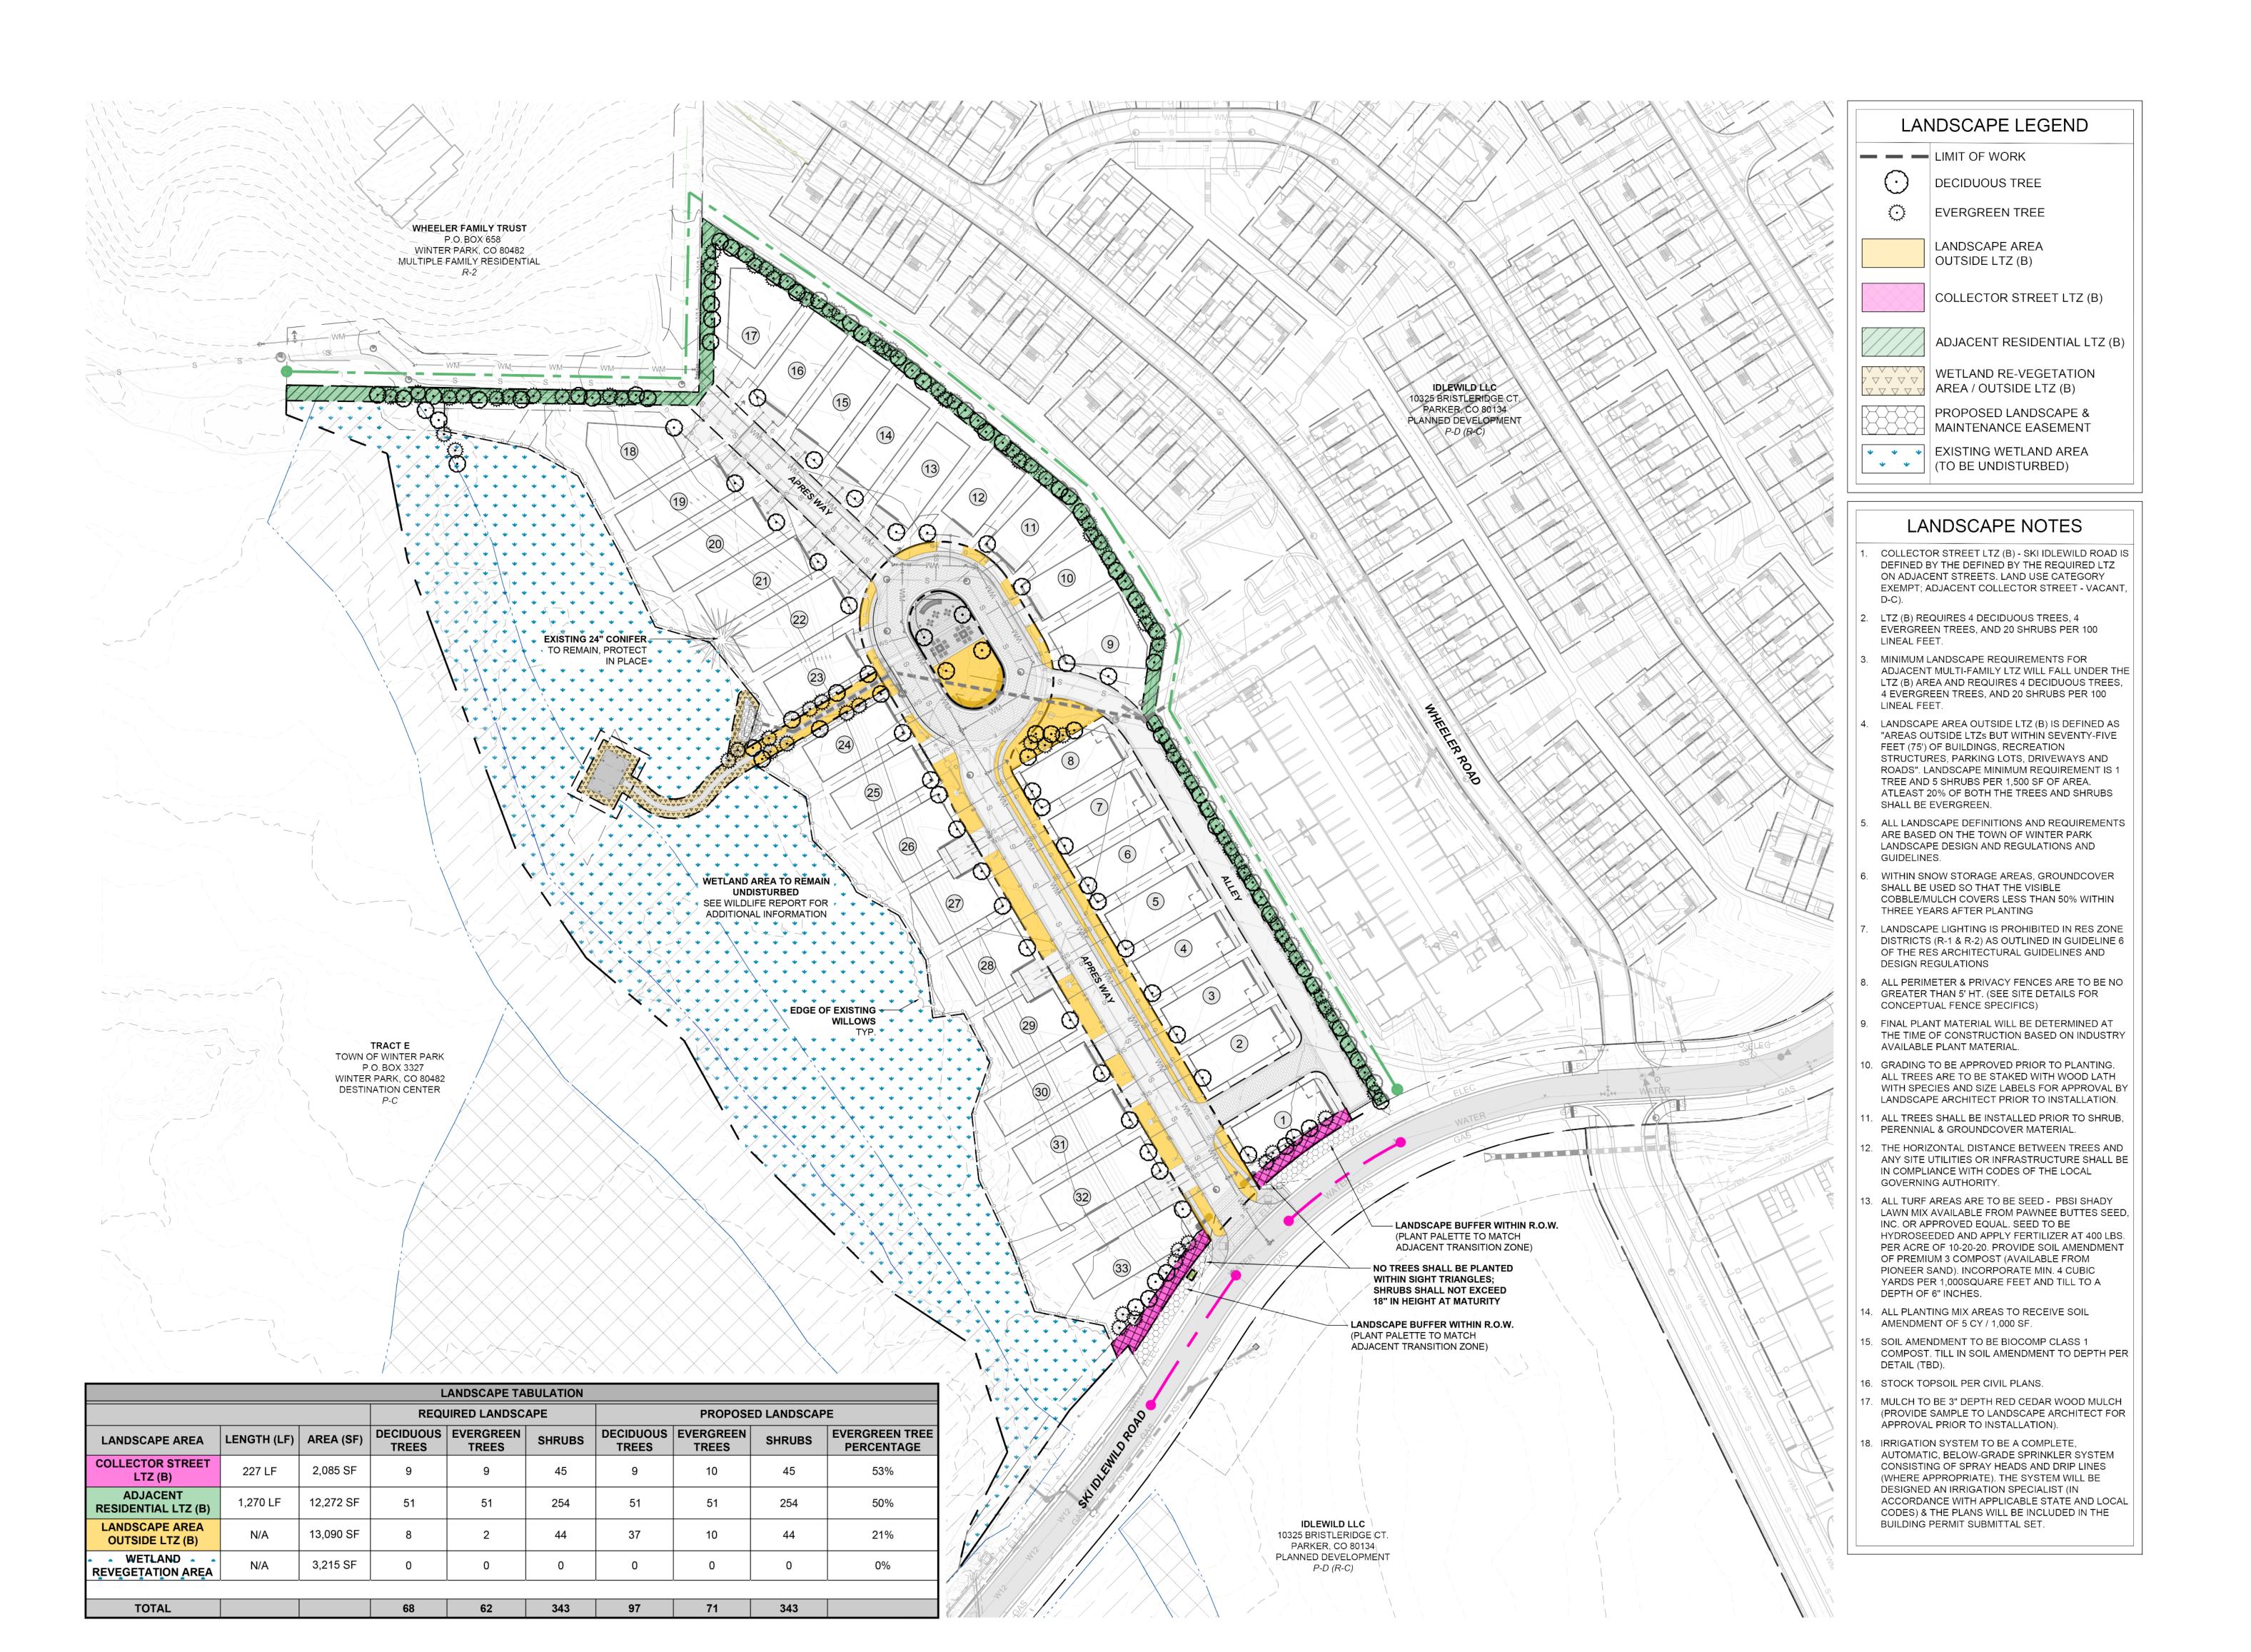

BOULDER david@nassardevelopment.com 303.775.5502

**DENVER** zach@nassardevelopment.com 303.775.8522

**ERIE** wes@nassardevelopment.com 303.775.5523

Consultant

Issue/Revisions

**Project Information** 

3

**Sheet Information** Sheet Title: LANDSCAPE PLAN

MINOR SITE APPLICATION 2024.07.25

Sheet Number:

Nassar Project:

1 LANDSCAPE PLAN
1" = 20'-0"

BOULDER david@nassardevelopment.com 303.775.5502

DENVER | zach@nassardevelopment.com 303.775.8522 **ERIE** wes@nassardevelopment.com 303.775.5523

Issue/Revisions Date No

Project Information

Consultant

HINKLEY

HINKLEY 33000 Pin Oak Parkway, Avon Lake, OH 44012 800.446.5539 / 440.653.5500 hinkley.com

7' and 9'6" above the floor

COASTAL **ELEMENTS** collection

FORGE 12070BK MEDIUM WALL MOUNT BARN LIGHT Inspired by a lighting industry staple barn light, Forge features a practical outdoor lighting solution to withstand the elements. Whether it is enduring harsh sunrays, extreme cold or continuous salt air, Forge is built to last with an industrial chic flair. Part of the Coastal Elements Collection, Forge is available in a variety of anti-facility finishes that are resistant to rust and corrosion with a 5-year warranty.

YES, WITH DIMMABLE LAMP (NOT INCLUDED) LIGHT SOURCE SHIPPING CARTON LENGTH: CARTON WIDTH: CARTON HEIGHT: 16.

PRODUCT DETAILS:

Suitable for use in wet (outdoor direct rain) locations as defined by NEC

and CEC. Meets United States UL Underwriters Laboratories & CSA Canadian Standards Association Product Safety Standards Fixture is Dark Sky compliant and engineered to minimize light glare upward into the night sky

 5-year finish warranty The Coastal Elements Collection offers versatile designs, constructed of composite materials and coated with anti-fading finishes, for maximum durability in harsh climates Angular lines, a bold finish and robust details create an industrial edge to

HINKLEY

add flair to any type of facade

HINKLEY 33000 Pin Oak Parkway Avon Lake, OH 44012

**PHONE: (440) 653-5500** hinkley.com Toll Free: 1 (800) 446-5539

0.04 - EXTERIOR LIGHT FIXTURE SPECIFICATION-DARK SKY COMPLIANT
12" = 1'-0"

**Sheet Information** 

137

Sheet Title: EXTERIOR LIGHTING FIXTURE

MINOR SITE
PLAN
APPLICATION 2024.08.19
Sheet Number:

Nassar Project: 2024.037
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# **MEMO**



TO Planning Commission

FROM James Shockey, Community Development Director

DATE September 10, 2024

RE Riverwalk at Winter Park, Riverfront Pavilion (PLN24-046) and Central Amenity Area

and Entry Gates (PLN24-047)

**Property Owner:** Riverwalk, LLC

**Applicant:** Adam Casias, Studio 1

**Location:** Outlot A, Riverwalk at Winter Park

Architects: Adam Casias, Studio 1

Zoning: R-2 (Multiple Family, Residential) (Riverwalk Final Development Plan) (FDP)

#### **Authority**:

Pursuant to § 5-B-3 of the Winter Park Unified Development Code (the "UDC"), the Director considers building configurations, colors, materials and general compatibility of proposed structures and outdoor advertising within the Town of Winter Park Minor Site Plan approval is required before building permit issuance.

#### Variances:

No Board of Adjustment (BOA) or administrative variance requests were requested with the applications.

### **Architecture**:

Satisfactory.

Entry Gates: Two gates are proposed at the entrance intersection of Ski Idlewild. The gates are the same design. The gates feature a limestone veneer base, with perforated metal panels holding up a timber trellis that stretches over a sidewalk on either side of Apres Way. These structures are generally consistent with the architecture of the single family dwelling reviewed for Lot 18 and other residences shown in submitted renderings. Architecture is consistent with the Winter Park Design Guidelines.

Central Community Amenity: The Outlot A containing the central amenity includes a wooden amphitheater with a standing seam metal roof and timber trusses for support. Other structures within the outlot include amphitheater seating with two rows of boulders along the south rim of the outlot. There is a stone wall blocking the view of Outlot A from the north. The architecture is consistent with the Mountain Town character seen throughout Winter Park and complies with Winter Park Design Guidelines.

Riverfront Pavilion: The pavilion features a metal gable roof with a timber snow guard similar to the homes reviewed in Riverwalk. The pavilion is supported by heavy timber trusses and is placed on an elevated



platform to protect it from wetlands drainage. The architecture is consistent with the Mountain Town character seen throughout Winter Park and complies with Winter Park Design Guidelines.

#### Title Commitment:

Unsatisfactory. The submitted title commitment is dated October 23, 2023. A title commitment shall not be more than six months older than the submittal date.

> The applicant shall provide an updated Title Commitment that is not older than 6 months from initial submittal date.

#### **Homeowner's Association Review:**

Satisfactory. The applicant provided an approval letter from the HOA with blanket approval of all residential lots and improvements.

#### **Material and Color:**

Satisfactory.

*Entry Gates*: As described previously, materials utilized for entry gates are consistent with the Winter Park Design Guidelines. Renderings show gates have a visually balanced proportion of cedar timber metal, and stone.

Central Community Amenity: As described previously, materials utilized for amenities in Outlot A are consistent with the Winter Park Design Guidelines. Renderings show the amphitheater is primarily natural cedar timber with a standing seam metal roof. Amphitheater seating is natural stone boulders on top of grass turf. A stone wall along the back is made of a stone veneer called "telluride gold blend", that is complementary of the wood and boulder colors.

Riverfront Pavilion: The material palette is a stone veneer base, a combination of metal standing seam metal roofing, and cedar lap siding visually dividing the stories. The roof has timber snow guards. The structure primarily utilizes stone and natural wood colors with the exception of black metal features on the roof, roof caps, and patio metal railings. The use of materials is balanced and matches the architectural character of the Town. Black metal-lined windows appear inset to visually strengthen the wall. The design complies with Winter Park Design Guidelines.

#### **Outdoor Lighting:**

Satisfactory. Four (4) types of exterior lighting fixtures are proposed with a total of 128 fixtures throughout the site plan. The majority of those lights are ceilings lights within the pavilion and amphitheater. Lighting poles are provided along sidewalks on Apres Way. There are 0.0 footcandles measured at the property line along Ski Idlewild Rd and all other property lines. All products have International Dark Sky approval and have the approval stamp on the product details.

Fixture Name	Proposed # of Fixtures	Proposed Lumens per Fixture	Proposed CCT
Beacon Urban Series Area Light	17	Min. 3,300 per fixture	3000 K
Spectrum Lighting, 6" Round Direct Ceiling	4	1000	3000K



Spectrum Lighting, 4" Deep Downlight	10	1000	3000K
ALUZ, Festoon Light	97	256	2400K

### **Accessory Dwelling Unit (ADU):**

N/A, not proposed.

#### Site Plan:

Unsatisfactory. The HOA shall maintain all proposed community features included in PLN 24-046 and PLN24-047.

*Entry Gates:* Proposed signage is located outside of proposed sign easement as shown on the approved Plat. The plat shall be updated to modify the easements, or the sign placement modified to fit within the existing easements. According to Sec. 6-2-7-6 of the Code of Ordinances, only one residential complex identification sign is permitted per primary street access. The pedestrian gates identify the subdivision, and only one sign is permitted.

- According to Sec. 6-2-7-6 of the Winter Park Code of Ordinances, only one residential sign is permitted per primary street access. One of the pedestrian gates for the subdivision shall be removed or signage removed from the gate.
- The proposed signage is only partially located within a designated sign easement. The gates are otherwise located in sanitary sewer and similar utility easements. Provide clarification or documentation that allows the proposed signage to be located outside of a sign easement, within the utility easement or modify the existing sign easement to encompass the new location.

Central Community Amenity: The amenity is located within Outlot A, a drive island within Apres Way. It includes two seating areas around fire pits and amphitheater seating. The amphitheater structure is approximately 800 square feet and is shaped in half-circle to align with the curve of the island. It has two sidewalk ramps, one on the east side and one on the west side. The ramp on the west side faces the access to trail for the other community amenity area in Outlot E and F.

Riverfront Pavilion: Located within Outlot E, and accessed via a trail easement in Outlot F, this structure is designated as common open space with a private deck structure. No other development is permitted. Wetlands exist around all of Outlot E and are located within Tract F. UDC 3-E-5(B)(3) requires a 30-foot water quality setback measured from the approximate high water mark of the stream watercourse embankment and the FDP established a 30-ft setback. The proposed deck structure is within the 100-year flood plain but meets the 30 foot setback requirement.

#### Floorplans:

N/A. No floor plans are part of the review. Review consists of two common areas and the entrance gateway signage.

#### **Building Elevations:**

Satisfactory. Elevation plans include all materials required for review. As previously noted, the proposed building is compliant with the Winter Park Design Guidelines.



#### **Building Coverage:**

Satisfactory.

Entry Gates: N/A

Central Community Amenity: The proposed building coverage for Outlot A, which includes the amphitheater and unenclosed patio, is 38 percent (38%) and the maximum building coverage is 40 percent (40%).

Riverfront Pavilion: Outlot E includes one covered pavilion and has approximately 30 percent (30%) building coverage. The maximum building coverage is 40 percent (40%).

#### **Building Height:**

Satisfactory. As provided by the Riverwalk FDP, the maximum building height is 35-feet. The Winter Park Code of Ordinances establishes a maximum height of 18-feet for residential identification signs.

Entry Gates: Proposed height is 11-feet, 4 inches.

Central Community Amenity: Outlot A includes the amphitheater and unenclosed patio, the amphitheater is approximately 14-feet, 1-inch measured from the midpoint of the shed roof.

Riverfront Pavilion: Outlot E includes one covered pavilion and has approximately 30 percent building coverage. The maximum building coverage is 40 percent.

#### Parking:

Satisfactory. All parking shall be located on-site in accordance with the requirements of the FDP.

#### Landscaping:

Unsatisfactory. According to the FDP, a landscaped area with Outside LTZ (B) is located along the sidewalks on Apres Way, within the southern portion of Outlot A, and within the trail easement of Outlot F. Outlot E is within a wetland and existing vegetation within the wetland easement will remain undisturbed. The overall landscaping plan was approved as part of the FDP approval. The landscaping plan shows the location of proposed trees, but not shrubs.

- For the landscaping areas within Outlot A and around the proposed pedestrian gates, clarify if shrubs are proposed and/or required.
- Provide species names for evergreen trees, deciduous trees, and shrubs.

#### Snow Storage:

Unsatisfactory. The FDP has an approved Snow Storage Plan. This submittal does not include snow storage locations as shown on the FDP. According to the approved snow storage plan, snow storage is located on Outlot A, but it has been removed in this submittal. The proposed snow storage in Outlot F and between Lot 23 and 24 has been modified.

- > Depict snow storage on the site plan as shown on the approved FDP or otherwise verify the proposed snow storage is sufficient for the overall site development.
- Provide square footage of all proposed snow storage on the site plan.



#### Erosion Control / Drainage Plan / Drainage Report / Grading / Engineer Review:

Satisfactory. The overall grading and drainage plan and drainage report were approved with the FDP and the submitted plan has been stamped by a professional engineer.

#### **Driveway**:

N/A, no driveways are proposed for common open spaces.

#### **Utility Review:**

N/A, the overall utility plan was approved with the FDP. Applicant has submitted a utility plan which shows sanitary sewer and water mains abutting the subject property. Utility easements are shown along eastern and northern property lines.

#### Inspection:

Building Division staff have not performed a Pre-Disturbance inspection of the property.

➤ No site clearing shall be permitted until the Building Division has verified the Pre-Disturbance Checklist has been implemented on the site.

#### Staff Recommendation:

Staff approves the Minor Site Plan with the following conditions:

- 1. According to Sec. 6-2-7-6 of the Winter Park Code of Ordinances, only one residential sign is permitted per primary street access. One of the pedestrian gates for the subdivision shall be removed or otherwise modified to comply.
- Provide clarification or documentation that allows the proposed signage to be located outside of the platted sign easement, redesign the signs to fit within the easement or modify the easement location to accommodate the new location.
- 3. Provide information on proposed shrubs on the landscape plan for the landscaping areas within Outlot A and around the proposed pedestrian gates.
- 4. Update the landscape plan to provide species names for proposed evergreen trees, deciduous trees, and shrubs.
- 5. Depict snow storage on the site plan as shown on the approved FDP or otherwise verify the proposed snow storage is sufficient for the overall site development.
- 6. Provide square footage of all proposed snow storage on the site plan for the subject properties.

### **Required Permits:**

- Building Permit
- Sign Permit





# **Land Use Review Application Form**

# **Contact Information**

**Property Owner** 

Riverwalk, LLC				
Company	Phone #	Email Address  ZACH@NASSARDEVELOPMENT.COM		
NASSAR DELVOPMENT	3037758522			
Mailing Address	City	State Zip		
3000 Airport Drive, Suite 203	ERIE	CO 80516		

## Billing Contact (where invoices should be directed)

Laurie Hurd				
Company Phone # Email Address				
NASSAR DELVOPMENT	3037758522 accounting@nassardevelopment.c		assardevelopment.com	
Mailing Address	City	State	Zip	
3000 Airport Drive, Suite 203	ERIE	СО	80516	

# Representative (i.e., the point of contact)

ADAM CASIAS		
Company	Phone #	Email Address
STUDIO 1	9709489836	ADAM@STUDIO1.COMPANY
Mailing Address	City	State Zip
255 SAINT PAUL STREET	DENVER	CO 80206

Site Description	
Site Address	Parcel Identification Number(s) (PIN)
87 Apres Way - Outlot D	
Existing Zone Classification	Site Area (acres and sq. ft.)
PD-R-2 (MULTIPLE FAMILY RESIDENTIAL)	2080 SF
Project Description  Project Name	
•	
pavilion structure	
Brief description of the proposed project	
pavilion open structure	
applicable public hearings, this Land Use Review	for Planning Division staff to begin review and schedule any Application Form must be fully completed and all required on for completeness and notify the representative and/or ownerse.
Certifications	
REPRESENTATIVE CERTIFICATION	
that is the subject of this application, and that I have	with the knowledge and consent of all owners of the property we been designated to act as the representative for the project fy that all information submitted with this application is true and Date
ADAM CASIAS	2024.06.19
OWNER CERTIFICATION	
	of the property that is the subject of this application. I authorize y, to communicate directly with Town officials and to submit cation on my behalf.
Owner	Date
DAVID NASSAR	2024 06 05

In addition to the base fees the applicant is required to pay the cost of any referral agency reviews, public notices, hearings, and record keeping as outlined within § 5-B-6, Application Fees, in the UDC.

2024.06.05

Development Improvements Dedications, Agreements, and Guarantees (Article 4.B)	Site Development and Permit Decisions (Article 5.E)
☐ Development Improvements Agreements (DIA)	☐ Major Site Plan*
☐ Public Improvement Cost-Recovery Agreement	Minor Site Plan
Standardized Development Review Procedures (Article 5.B)	Administrative Site Plan
☐ Pre-Application Conference	Special Use Permit (Including High-Impact Short-Term Rentals)*
Renewal of Approvals	Limited Use Authorization
☐ Vested Rights	☐ Temporary Use Permit
Ordinance and Zoning Amendment Decisions (Article 5.C)	☐ Floodplain Development Permit
☐ Text Amendment	☐ Lighting by Special Permit
Rezoning	Parking Reductions and Alternative Parking Plan Permit
Rezoning to Planned Development:  Preliminary Development Plan*	☐ Street Renaming
☐ Final Development Plan* ☐ Amended Final Development Plan*	
	Appeal, Variance, and Interpretation Decisions (Article 5.F)
Amended Final Development Plan*	Appeal, Variance, and Interpretation Decisions
☐ Amended Final Development Plan* ☐ Annexation*	Appeal, Variance, and Interpretation Decisions (Article 5.F)
☐ Amended Final Development Plan* ☐ Annexation*  Subdivision and Platting Decisions (Article 5.D)	Appeal, Variance, and Interpretation Decisions (Article 5.F)  Appeal
<ul> <li>☐ Amended Final Development Plan*</li> <li>☐ Annexation*</li> <li>Subdivision and Platting Decisions (Article 5.D)</li> <li>☐ Exemption Plat</li> </ul>	Appeal, Variance, and Interpretation Decisions (Article 5.F)  Appeal  Appeal of Administrative Decisions
<ul> <li>☐ Amended Final Development Plan*</li> <li>☐ Annexation*</li> <li>Subdivision and Platting Decisions (Article 5.D)</li> <li>☐ Exemption Plat</li> <li>☐ Minor Plat*</li> </ul>	Appeal, Variance, and Interpretation Decisions (Article 5.F)  Appeal  Appeal of Administrative Decisions  Variance*
<ul> <li>☐ Amended Final Development Plan*</li> <li>☐ Annexation*</li> <li>Subdivision and Platting Decisions (Article 5.D)</li> <li>☐ Exemption Plat</li> <li>☐ Minor Plat*</li> <li>☐ Preliminary Plat*</li> </ul>	Appeal, Variance, and Interpretation Decisions (Article 5.F)  Appeal  Appeal of Administrative Decisions  Variance*
☐ Amended Final Development Plan*   ☐ Annexation*   Subdivision and Platting Decisions (Article 5.D)   ☐ Exemption Plat   ☐ Minor Plat*   ☐ Preliminary Plat*   ☐ Final Plat*	Appeal, Variance, and Interpretation Decisions (Article 5.F)  Appeal  Appeal of Administrative Decisions  Variance*
☐ Amended Final Development Plan*   ☐ Annexation*   Subdivision and Platting Decisions (Article 5.D)   ☐ Exemption Plat   ☐ Minor Plat*   ☐ Preliminary Plat*   ☐ Final Plat*   ☐ Resubdivision*	Appeal, Variance, and Interpretation Decisions (Article 5.F)  Appeal  Appeal of Administrative Decisions  Variance*
☐ Amended Final Development Plan*   ☐ Annexation*   Subdivision and Platting Decisions (Article 5.D)   ☐ Exemption Plat   ☐ Minor Plat*   ☐ Preliminary Plat*   ☐ Final Plat*   ☐ Resubdivision*   ☐ Waiver*   ☐ Vacation of Plat, Street, Right of Way, and	Appeal, Variance, and Interpretation Decisions (Article 5.F)  Appeal  Appeal of Administrative Decisions  Variance*





# **Land Use Review Application Form**

### **Contact Information**

**Property Owner** 

Riverwalk, LLC		
Company	Phone #	Email Address  ZACH@NASSARDEVELOPMENT.COM
NASSAR DELVOPMENT	3037758522	
Mailing Address	City	State Zip
3000 Airport Drive, Suite 203	ERIE	CO 80516

#### Billing Contact (where invoices should be directed)

Laurie Hurd			
Company	Phone #	Email Ad	ldress
NASSAR DELVOPMENT	3037758522	accounting@n	assardevelopment.com
Mailing Address	City	State	Zip
3000 Airport Drive, Suite 203	ERIE	СО	80516

#### Representative (i.e., the point of contact)

ADAM CASIAS		
Company	Phone #	Email Address
STUDIO 1	9709489836	ADAM@STUDIO1.COMPANY
Mailing Address	City	State Zip
255 SAINT PAUL STREET	DENVER	CO 80206

### Site Description

Site Address

Apres Way outlot A

Existing Zone Classification

Parcel Identification Number(s) (PIN)

Site Area (acres and sq. ft.)

R-2 (MULTIPLE FAMILY RESIDENTIAL)

4613 SF amenity center + Gates 31239 SF

### **Project Description**

Project Name

Amenity Center and Entry Gates

Brief description of the proposed project

Amenity Center and Entry Gates

### **Required Documents**

For an application to be considered complete and for Planning Division staff to begin review and schedule any applicable public hearings, this Land Use Review Application Form must be fully completed and all required attachments included. Staff will review the application for completeness and notify the representative and/or owner whether the application has been deemed complete.

### Certifications

#### REPRESENTATIVE CERTIFICATION

By signing this application, I attest that I am acting with the knowledge and consent of all owners of the property that is the subject of this application, and that I have been designated to act as the representative for the project described in this land the application. I further certify that all information submitted with this application is true and accurate to the best of my knowledge.

Representative

Date

**ADAM CASIAS** 

2024.06.19

### OWNER CERTIFICATION

I hereby certify that I am the legal owner of record of the property that is the subject of this application. I authorize the representative listed on this application, if any, to communicate directly with Town officials and to submit documentation and information regarding this application on my behalf.

Owner Date

DAVID NASSAR 2024.06.05

In addition to the base fees the applicant is required to pay the cost of any referral agency reviews, public notices, hearings, and record keeping as outlined within § 5-B-6, Application Fees, in the UDC.

Development Improvements Dedications, Agreements, and Guarantees (Article 4.B)	Site Development and Permit Decisions (Article 5.E)
☐ Development Improvements Agreements (DIA)	☐ Major Site Plan*
☐ Public Improvement Cost-Recovery Agreement	Minor Site Plan
Standardized Development Review Procedures (Article 5.B)	Administrative Site Plan
☐ Pre-Application Conference	Special Use Permit (Including High-Impact Short-Term Rentals)*
Renewal of Approvals	Limited Use Authorization
☐ Vested Rights	☐ Temporary Use Permit
Ordinance and Zoning Amendment Decisions (Article 5.C)	☐ Floodplain Development Permit
☐ Text Amendment	☐ Lighting by Special Permit
Rezoning	Parking Reductions and Alternative Parking Plan Permit
Rezoning to Planned Development:  Preliminary Development Plan*	☐ Street Renaming
☐ Final Development Plan* ☐ Amended Final Development Plan*	
	Appeal, Variance, and Interpretation Decisions (Article 5.F)
Amended Final Development Plan*	Appeal, Variance, and Interpretation Decisions
☐ Amended Final Development Plan* ☐ Annexation*	Appeal, Variance, and Interpretation Decisions (Article 5.F)
☐ Amended Final Development Plan* ☐ Annexation*  Subdivision and Platting Decisions (Article 5.D)	Appeal, Variance, and Interpretation Decisions (Article 5.F)  Appeal
<ul> <li>☐ Amended Final Development Plan*</li> <li>☐ Annexation*</li> <li>Subdivision and Platting Decisions (Article 5.D)</li> <li>☐ Exemption Plat</li> </ul>	Appeal, Variance, and Interpretation Decisions (Article 5.F)  Appeal  Appeal of Administrative Decisions
<ul> <li>☐ Amended Final Development Plan*</li> <li>☐ Annexation*</li> <li>Subdivision and Platting Decisions (Article 5.D)</li> <li>☐ Exemption Plat</li> <li>☐ Minor Plat*</li> </ul>	Appeal, Variance, and Interpretation Decisions (Article 5.F)  Appeal  Appeal of Administrative Decisions  Variance*
<ul> <li>☐ Amended Final Development Plan*</li> <li>☐ Annexation*</li> <li>Subdivision and Platting Decisions (Article 5.D)</li> <li>☐ Exemption Plat</li> <li>☐ Minor Plat*</li> <li>☐ Preliminary Plat*</li> </ul>	Appeal, Variance, and Interpretation Decisions (Article 5.F)  Appeal  Appeal of Administrative Decisions  Variance*
☐ Amended Final Development Plan*   ☐ Annexation*   Subdivision and Platting Decisions (Article 5.D)   ☐ Exemption Plat   ☐ Minor Plat*   ☐ Preliminary Plat*   ☐ Final Plat*	Appeal, Variance, and Interpretation Decisions (Article 5.F)  Appeal  Appeal of Administrative Decisions  Variance*
☐ Amended Final Development Plan*   ☐ Annexation*   Subdivision and Platting Decisions (Article 5.D)   ☐ Exemption Plat   ☐ Minor Plat*   ☐ Preliminary Plat*   ☐ Final Plat*   ☐ Resubdivision*	Appeal, Variance, and Interpretation Decisions (Article 5.F)  Appeal  Appeal of Administrative Decisions  Variance*
☐ Amended Final Development Plan*   ☐ Annexation*   Subdivision and Platting Decisions (Article 5.D)   ☐ Exemption Plat   ☐ Minor Plat*   ☐ Preliminary Plat*   ☐ Final Plat*   ☐ Resubdivision*   ☐ Waiver*   ☐ Vacation of Plat, Street, Right of Way, and	Appeal, Variance, and Interpretation Decisions (Article 5.F)  Appeal  Appeal of Administrative Decisions  Variance*



River Walk by Nassar Development LLC River Walk Owners Association (ROA) 3000 Airport Drive Unit 203 Erie, CO 80516 303-775-5502

roa@riverwalkwp.com

Narrative - pln24-046 Pavilion

- A. Project Name Pavilion
- B. Street Address 87 Apres Way, OUTLOT D
- C. Name River Walk by Nassar Development LLC
  Address 3000 Airport Drive, Unit 203 Erie, Colorado 80516
  email and telephone number david@nassardevelopment.com, 303-775-5502
  applicant River Walk by Nassar Development LLC
  HOA River Walk Owners Association (ROA)
  project manager Zach Nassar
  architecture ADAM CASIAS, Studio 1
  engineer David Mitchell, Front Range Structural Engineering
  surveyor CORE CONSULTANTS, LLC
  and land planner River Walk by Nassar Development LLC

Legal description - OUTLOT E, A REPLAT OF TRACT F-1, IDLEWILD MINOR SUBDIVISION A PART OF THE SOUTHWEST QUARTER OF THE SOUTHEAST QUARTER OF SECTION 28, TOWNSHIP 1 SOUTH, RANGE 75 WEST OF THE 6TH P.M.TOWN OF WINTER PARK, COUNTY OF GRAND, STATE OF COLORADO

D.


- E. Zoning district PD R-2 (PLANNED DEVELOPMENTMULTIPLE FAMILY RESIDENTIAL
- F. Lot size 2080 SF
- G. All proposed uses Open Pavilion
- H. Number of dwelling units 0
- I. Number of bedrooms per dwelling unit 0
- J. Size of residential space 0, open Pavilion 640 sf
- K. Number of proposed off-street parking spaces 1
- L. Construction schedule indicating major milestones for project Completion of Amenity Center, Pavilion, and Wet Land Deck: Commences 9/1/24 and complete 10/15/24 M.Please note that all existing trees have previously been removed.




River Walk by Nassar Development LLC
River Walk Owners Association (ROA)
3000 Airport Drive
Unit 203
Erie, CO 80516
303-775-5502
roa@riverwalkwp.com

#### Narrative - pln24-047 Amenity Center and Gates

- A. Project Name Amenity Center and Gates
- B. Street Address Après Way OUTLOT A, PRIVATE ROW A
- C. Name River Walk by Nassar Development LLC
  Address 3000 Airport Drive, Unit 203 Erie, Colorado 80516
  email and telephone number david@nassardevelopment.com, 303-775-5502
  applicant River Walk by Nassar Development LLC
  HOA River Walk Owners Association (ROA)
  project manager Zach Nassar
  architecture ADAM CASIAS, Studio 1
  engineer David Mitchell, Front Range Structural Engineering
  surveyor CORE CONSULTANTS, LLC
  and land planner River Walk by Nassar Development LLC
- D. Legal description OUTLOT A, PRIVATE ROW A A REPLAT OF TRACT F-1, IDLEWILD MINOR SUBDIVISION A PART OF THE SOUTHWEST QUARTER OF THE SOUTHEAST QUARTER OF SECTION 28, TOWNSHIP 1 SOUTH, RANGE 75 WEST OF THE 6TH P.M.TOWN OF WINTER PARK, COUNTY OF GRAND, STATE OF COLORADO E. Zoning district R-2 (MULTIPLE FAMILY RESIDENTIAL)
- F. Lot size OUTLOA A 4613 SF, PRIVATE ROW A, 31239 SF
- G. All proposed uses open Amenity Center, and Entry Gates
- H. Number of dwelling units 0
- I. Number of bedrooms per dwelling unit 0
- J. Size of residential space 0,
- K. Number of proposed off-street parking spaces 1
- L. Construction schedule indicating major milestones for project Completion of Amenity Center, Pavilion, and Wet Land Deck: Commences 9/1/24 and complete 10/15/24

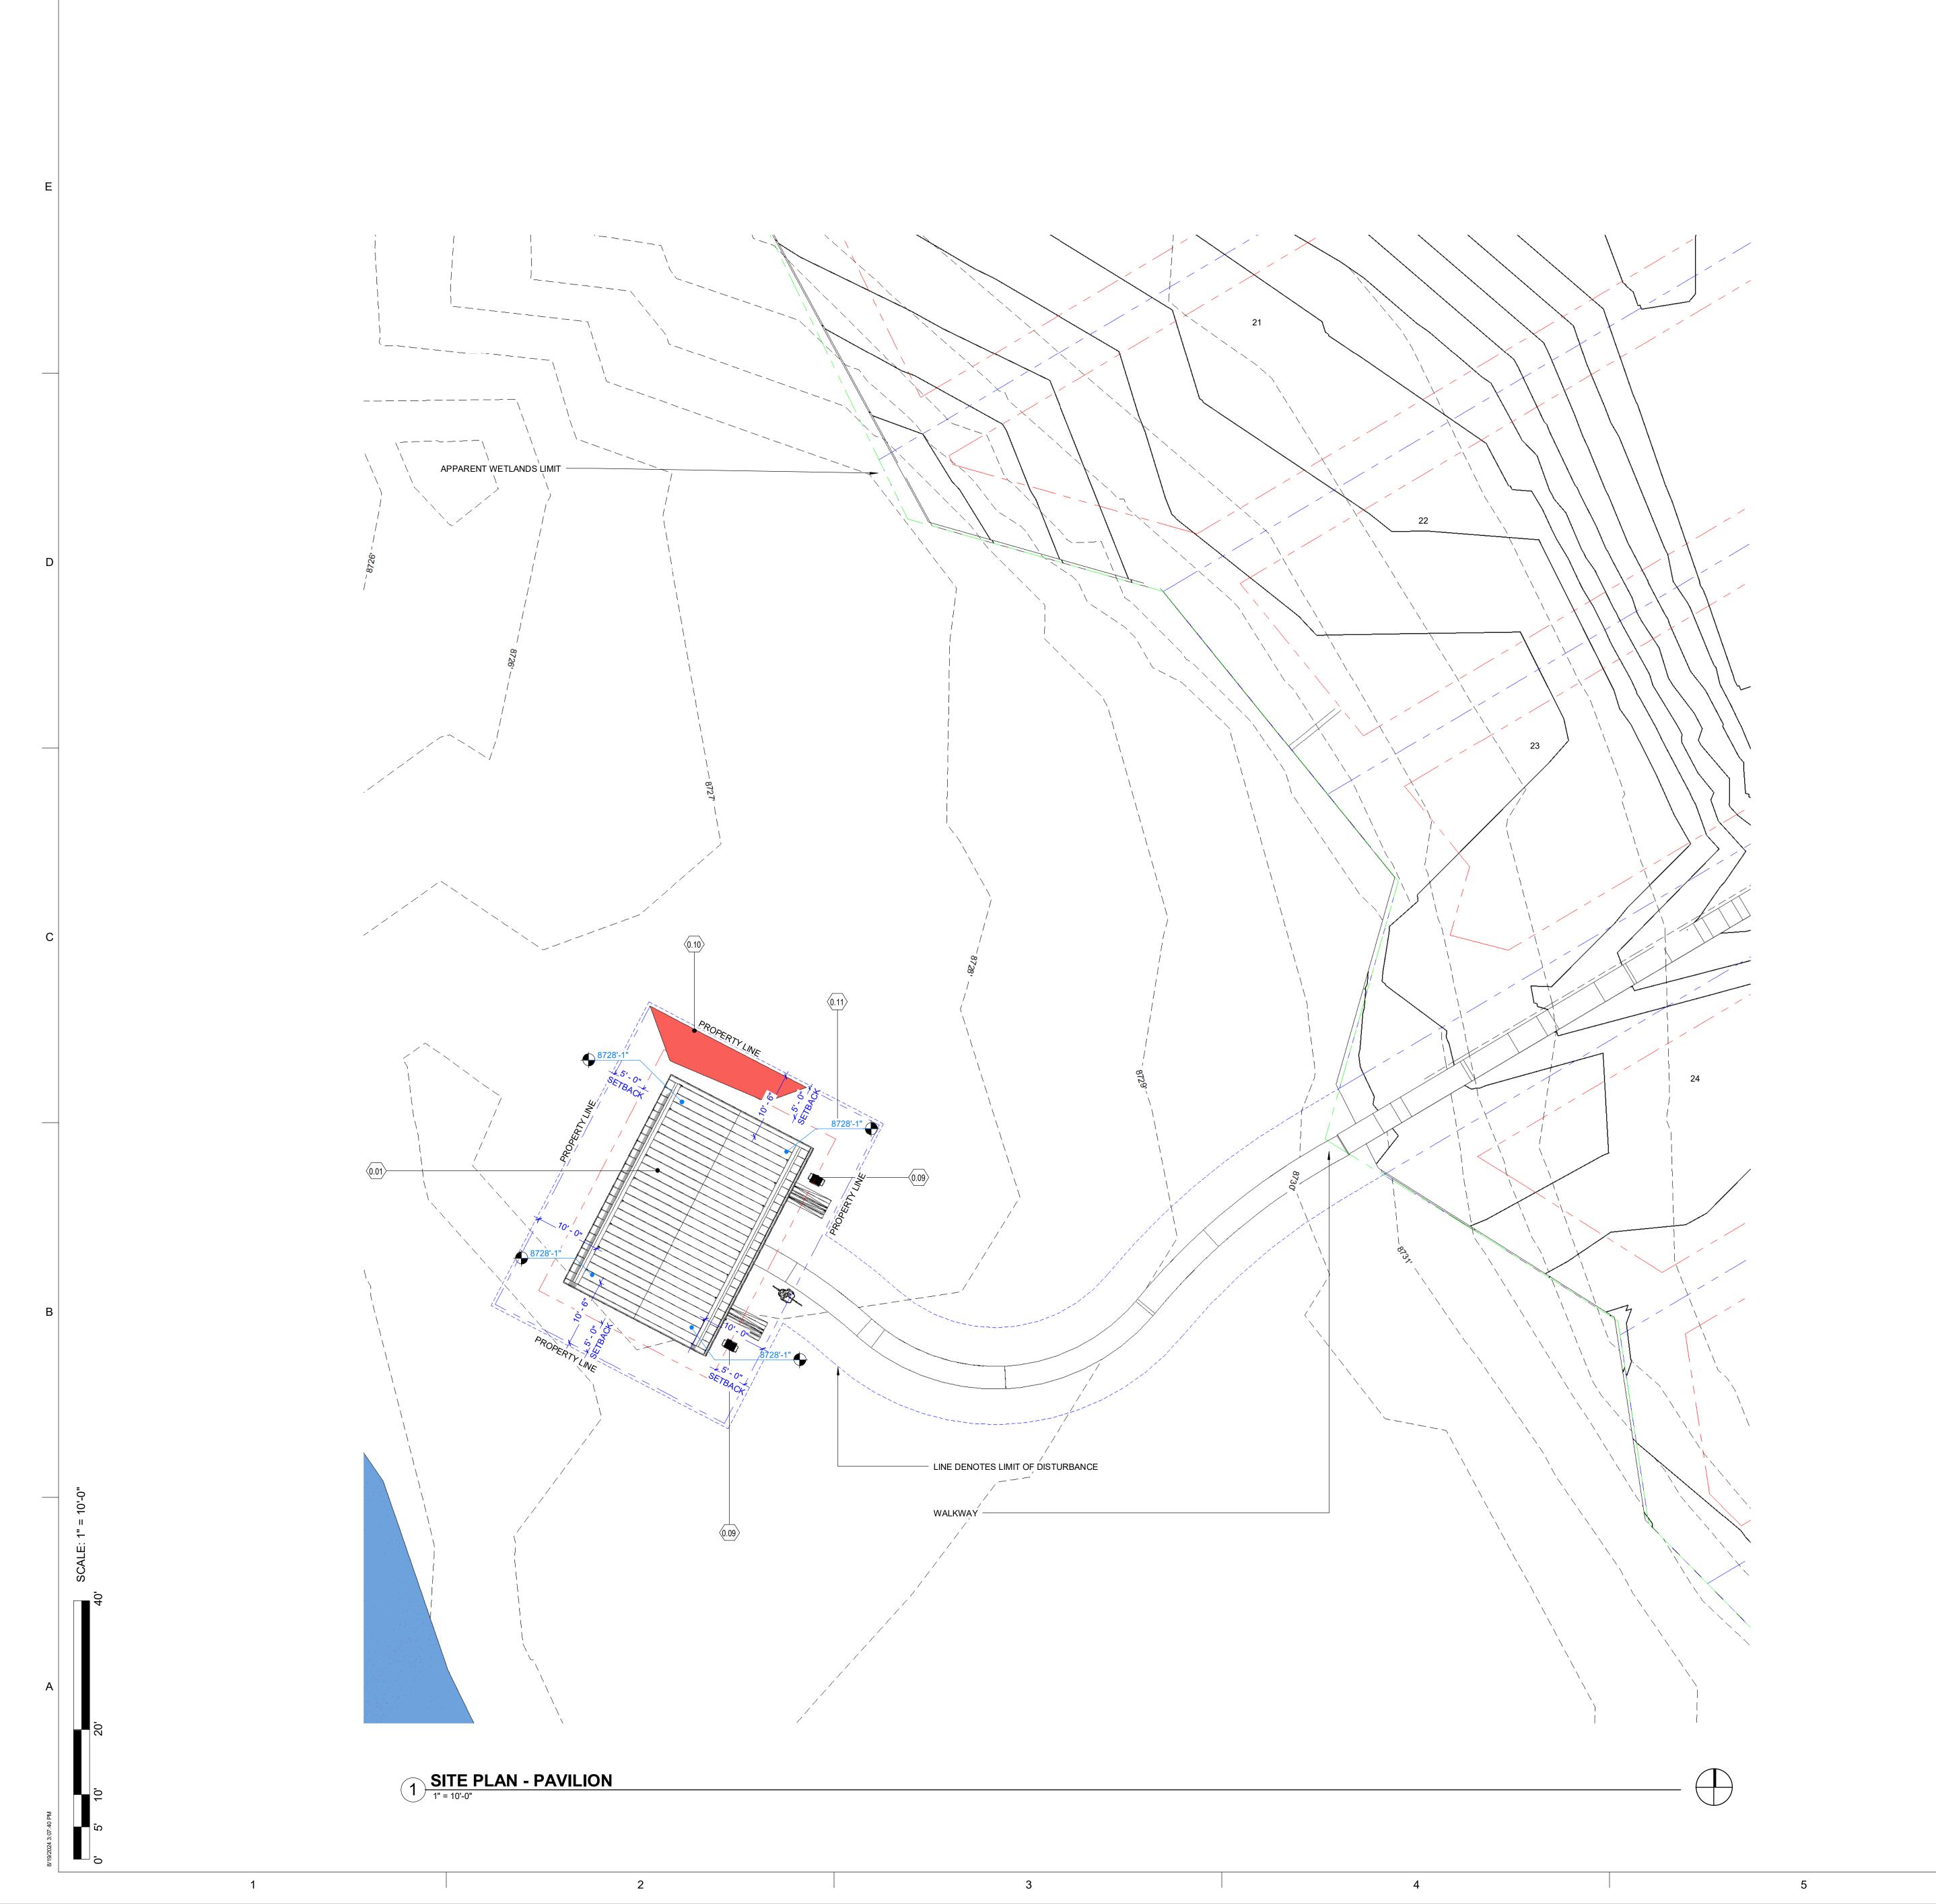

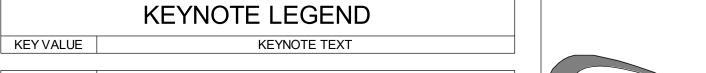

PROPOSED PAVILION STRUCTURE AFFIXED BARBEQUE GRILL SNOW STORAGE AREA STORAGE AREAS FOR SOIL, CONSTRUCTION EQUIPMENT, AND OTHER MATERIALS



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**ERIE** wes@nassardevelopment.com 303.775.5523

Consultant

## **GENERAL SITE PLAN NOTES:**

- ALL DIMENSIONS TO FACE OF FOUNDATION WALL OR STRUCTURAL STRATA, UNLESS NOTED OTHERWISE.
   VERIFY ALL SITE PARAMETERS (PROPERTY BOUNDARIES, EASEMENTS
- AND SETBACKS) PRIOR TO STAKING TO DEMOLITION AND CONSTRUCTION. CONTRACTOR TO VERIFY LOCATION OF ALL UNDERGROUND UTILITIES
- AND TO ARRANGE PROPER DISCONTINUANCE AND/OR RELOCATION PRIOR TO DEMOLITION.

  4. PROVIDE TREE AND SHRUB PROTECTION FOR EXISTING
- LANDSCAPING, ESPECIALLY FOR MATURE TREES MARKED TO BE
- 5. PROVIDE POSITIVE DRAINAGE AWAY FROM BUILDING PERIMETER; 10% MINIMUM SLOPE FOR FIRST 10'. IT IS ESSENTIAL THAT SITE GRADING BE PROVIDED TO PREVENT INFILTRATION OF SURFACE WATER INTO THE FOUNDATION SYSTEM. REFER TO CIVIL DRAWINGS FOR GRADING
- AND DRAINAGE.

  REFER TO LANDSCAPE DRAWINGS FOR LANDSCAPE, EXTERIOR

  LANDSCAPE LIGHTING AND IRRIGATION PLANS.
- MECHANICALLY COMPACT ALL FILL AROUND THE BUILDING, INCLUDING THE BACKFILL. IMPROPER BACKFILL COMPACTION CAN
- CAUSE SETTLEMENT OF EXTERIOR SLABS SUCH AS WALKS, PATIOS AND DRIVEWAYS.
- 8. DISCHARGE ROOF DOWN SPOUTS AND ALL OTHER WATER COLLECTION SYSTEMS MINIMUM 5' BEYOND PERIMETER OF STRUCTURE. RE: CIVIL DRAWINGS FOR HARD-PIPED DRAINS.
- NO IRRIGATION WITHIN 5' OF THE FOUNDATION. AVOID HEAVY
  WATERING OF ANY FOUNDATION PLANTINGS.
  PHOTOVOLTAIC SOLAR PANELS TO BE REVIEWED AND APPROVED
- UNDER SEPERATE PERMIT
- 11. SITE WALLS UNDER SEPERATE PERMIT

Issue/Revisions Date No

640 SF

**Project Information** 

# SITE COVERAGE - PAVILION 3/32" = 1'-0"

# LOT COVERAGE

**BUILDING COVERAGE** 640 SF 2080 SF TOTAL LOT AREA 640 / 2080 = 30% TOTAL LOT COVERAGE

# **LEGEND**

PROPRTY LINE

**PROTECTION SITE PLAN NOTES:** 

A. NO DISTURBANCE, GRADING, OR REMOVAL OF SIGNIFICANT NATURAL FEATURES AND VEGETATION WILL OCCUR BEYOND THE LIMIT OF DISTURBANCE LINE, AS SHOWN ON THIS

B. THE LIMIT OF DISTURBANCE LINE SHALL BE DELINEATED PRIOR TO CONSTRUCTION WITH FLAGS, ROPING, FOUR FOOT (4') TALL ORANGE CONSTRUCTION FENCING, OR OTHER ACCEPTABLE MEANS.

Sheet Information


Sheet Title: SITE PLAN -PAVILION

MINOR SITE PLAN APPLICATION 2024.08.19

Sheet Number:

Nassar Project:




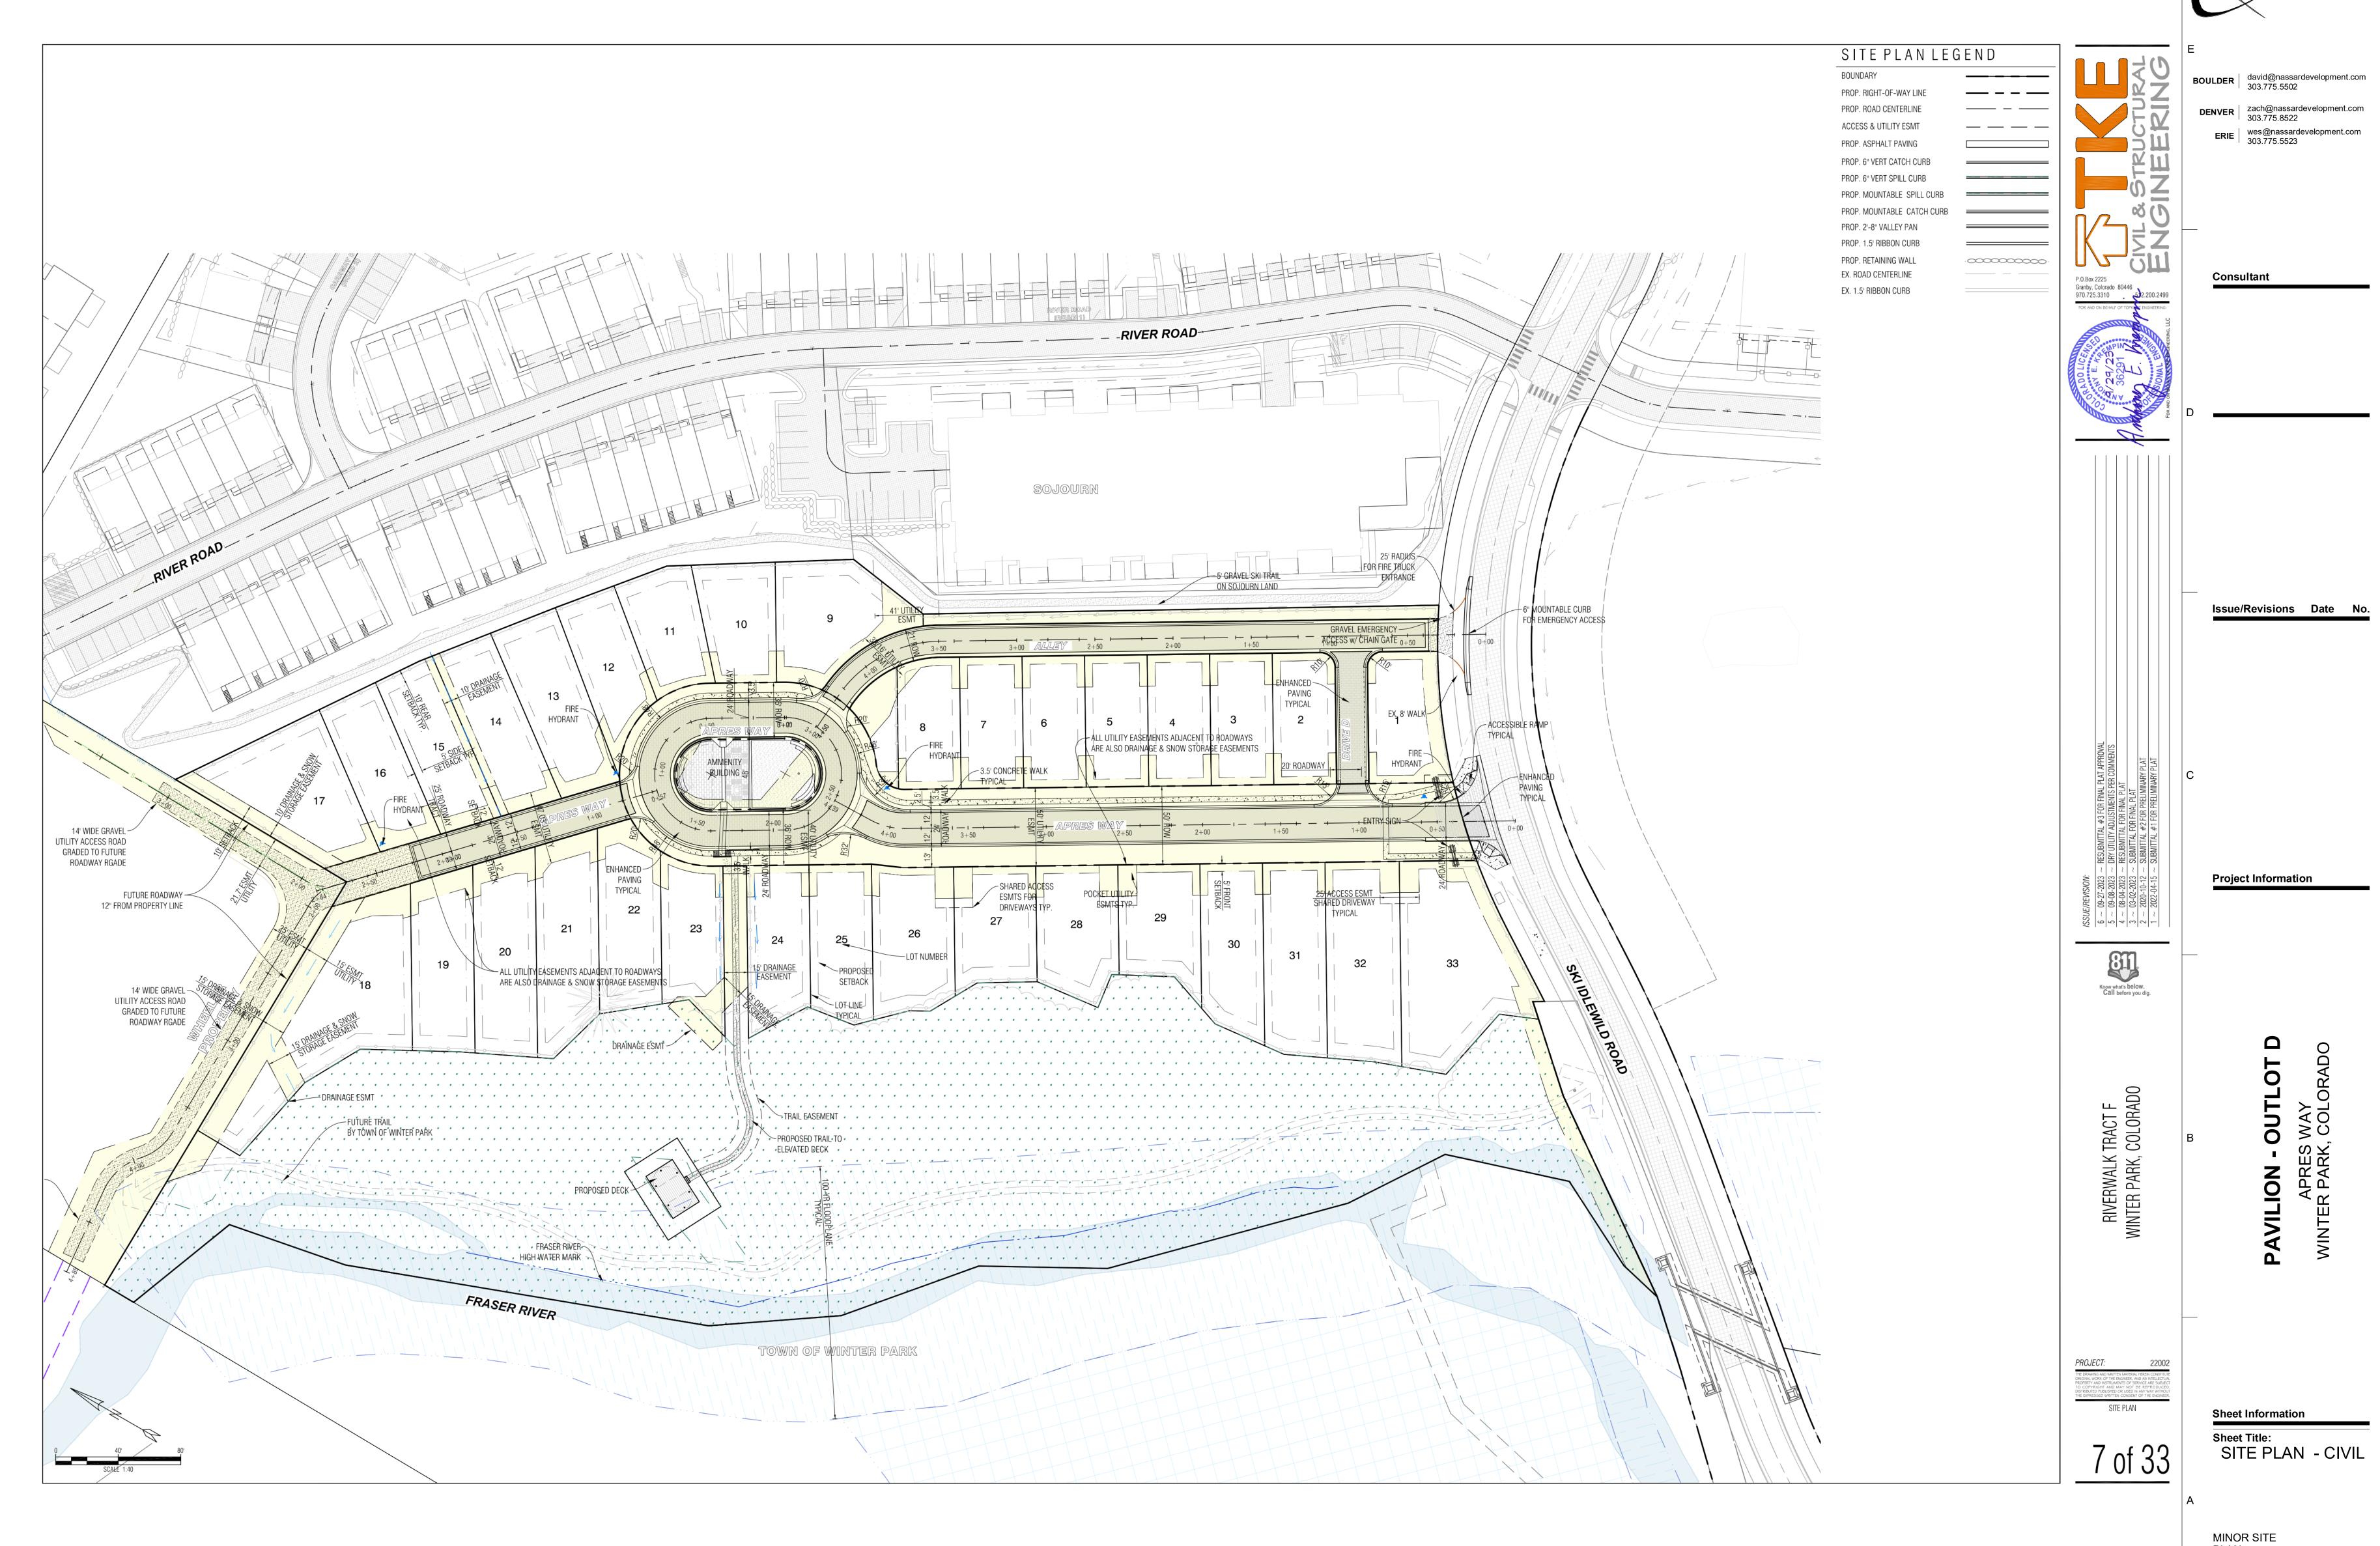


1 SITE PLAN - CIVIL
1" = 20'-0"

MINOR SITE PLAN

APPLICATION 2024.08.19 Sheet Number:

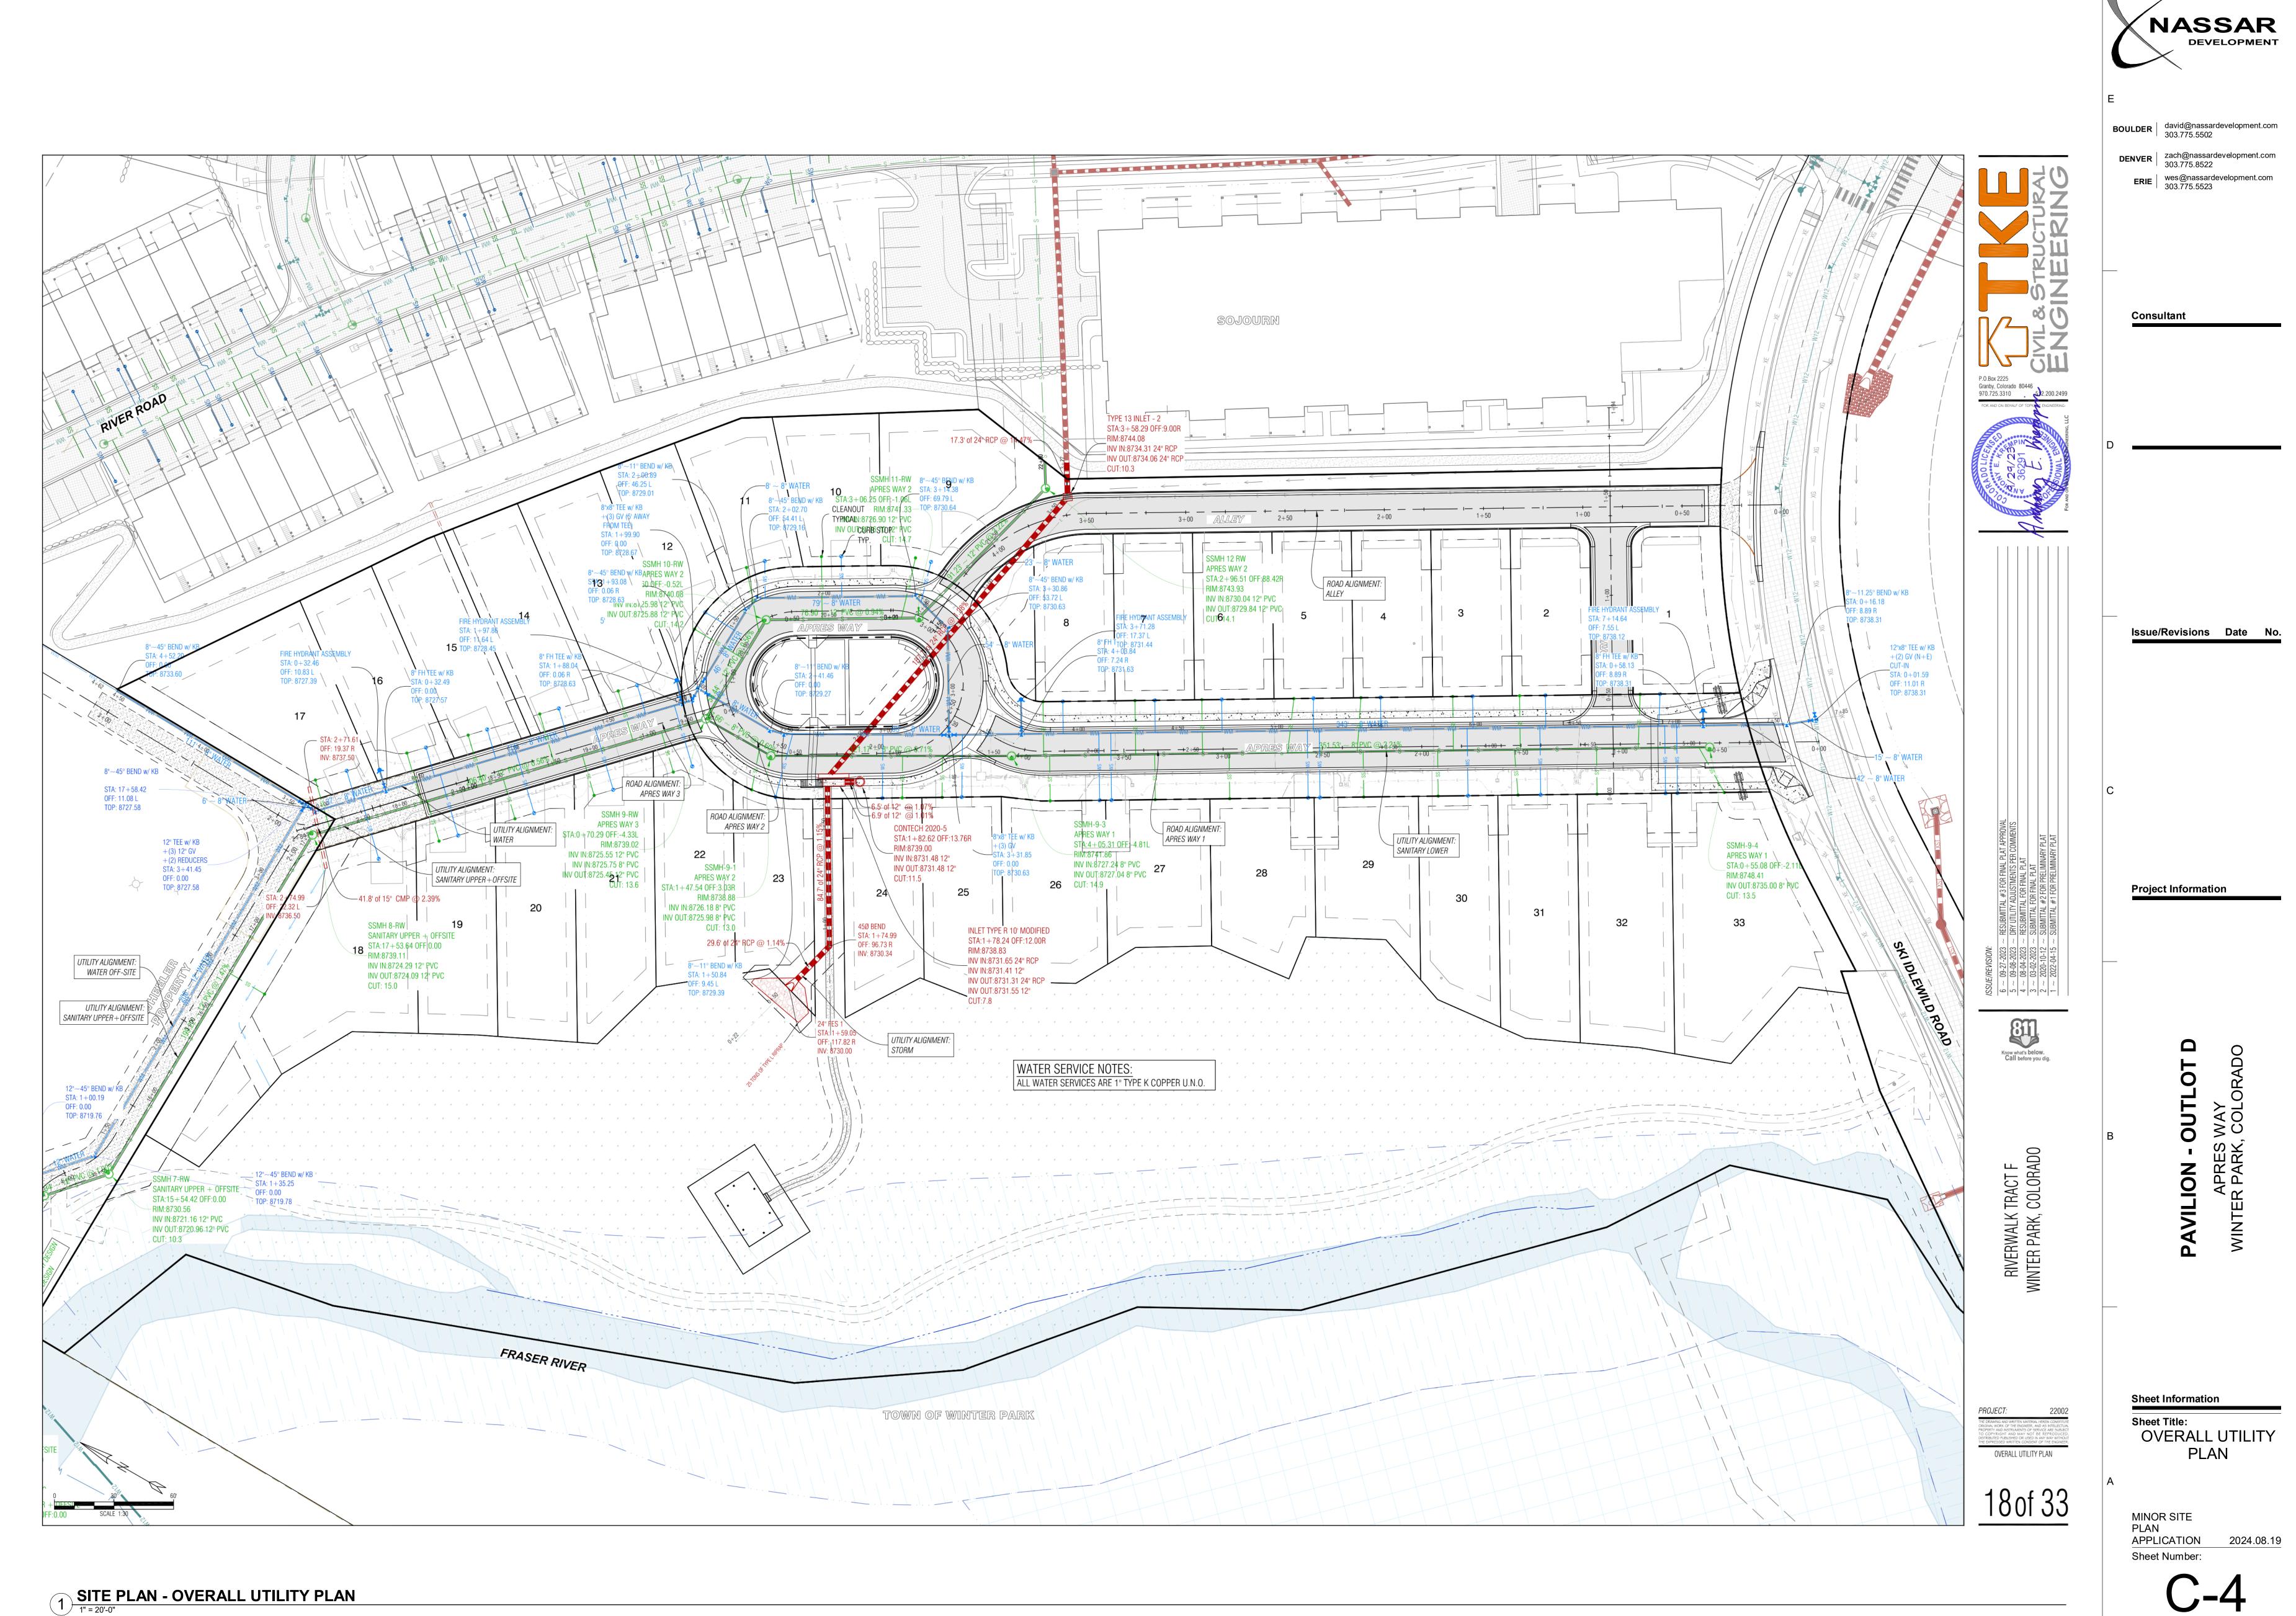

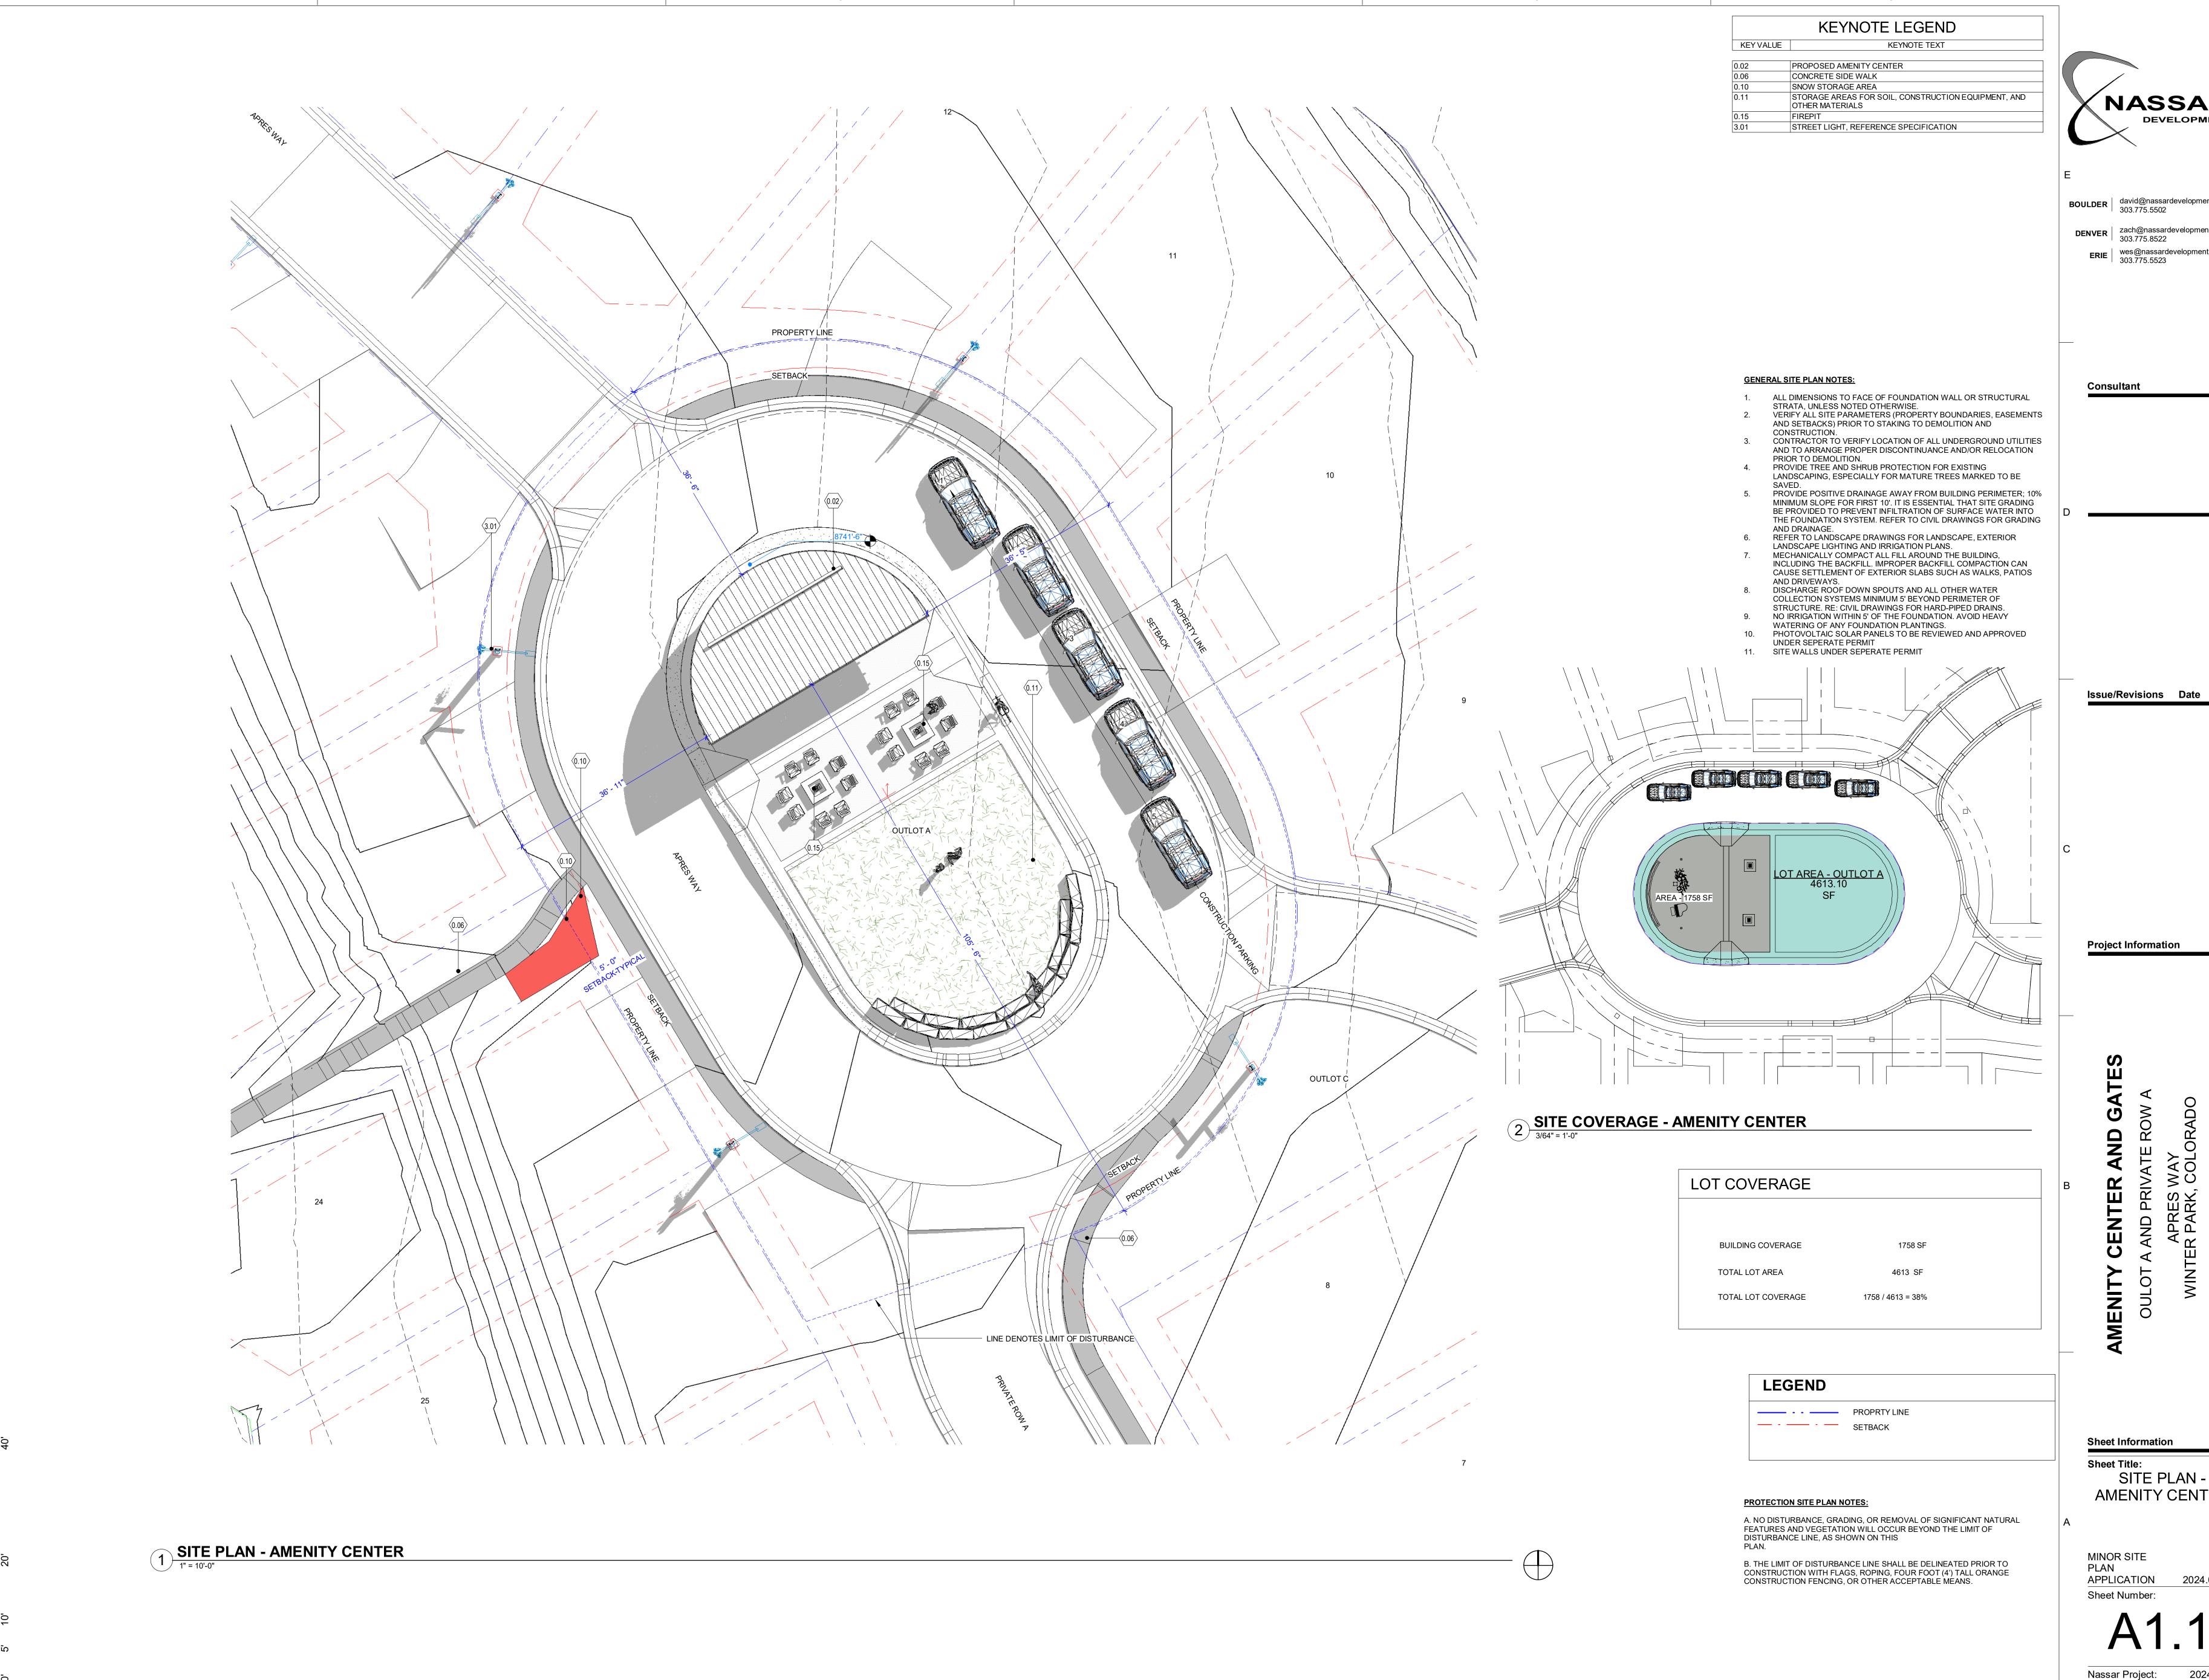

NASSAR DEVELOPMENT

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**DENVER** zach@nassardevelopment.com 303.775.8522


ERIE wes@nassardevelopment.com 303.775.5523

Sheet Information

Sheet Title: SITE PLAN -**AMENITY CENTER** 

MINOR SITE APPLICATION 2024.08.19

Nassar Project:

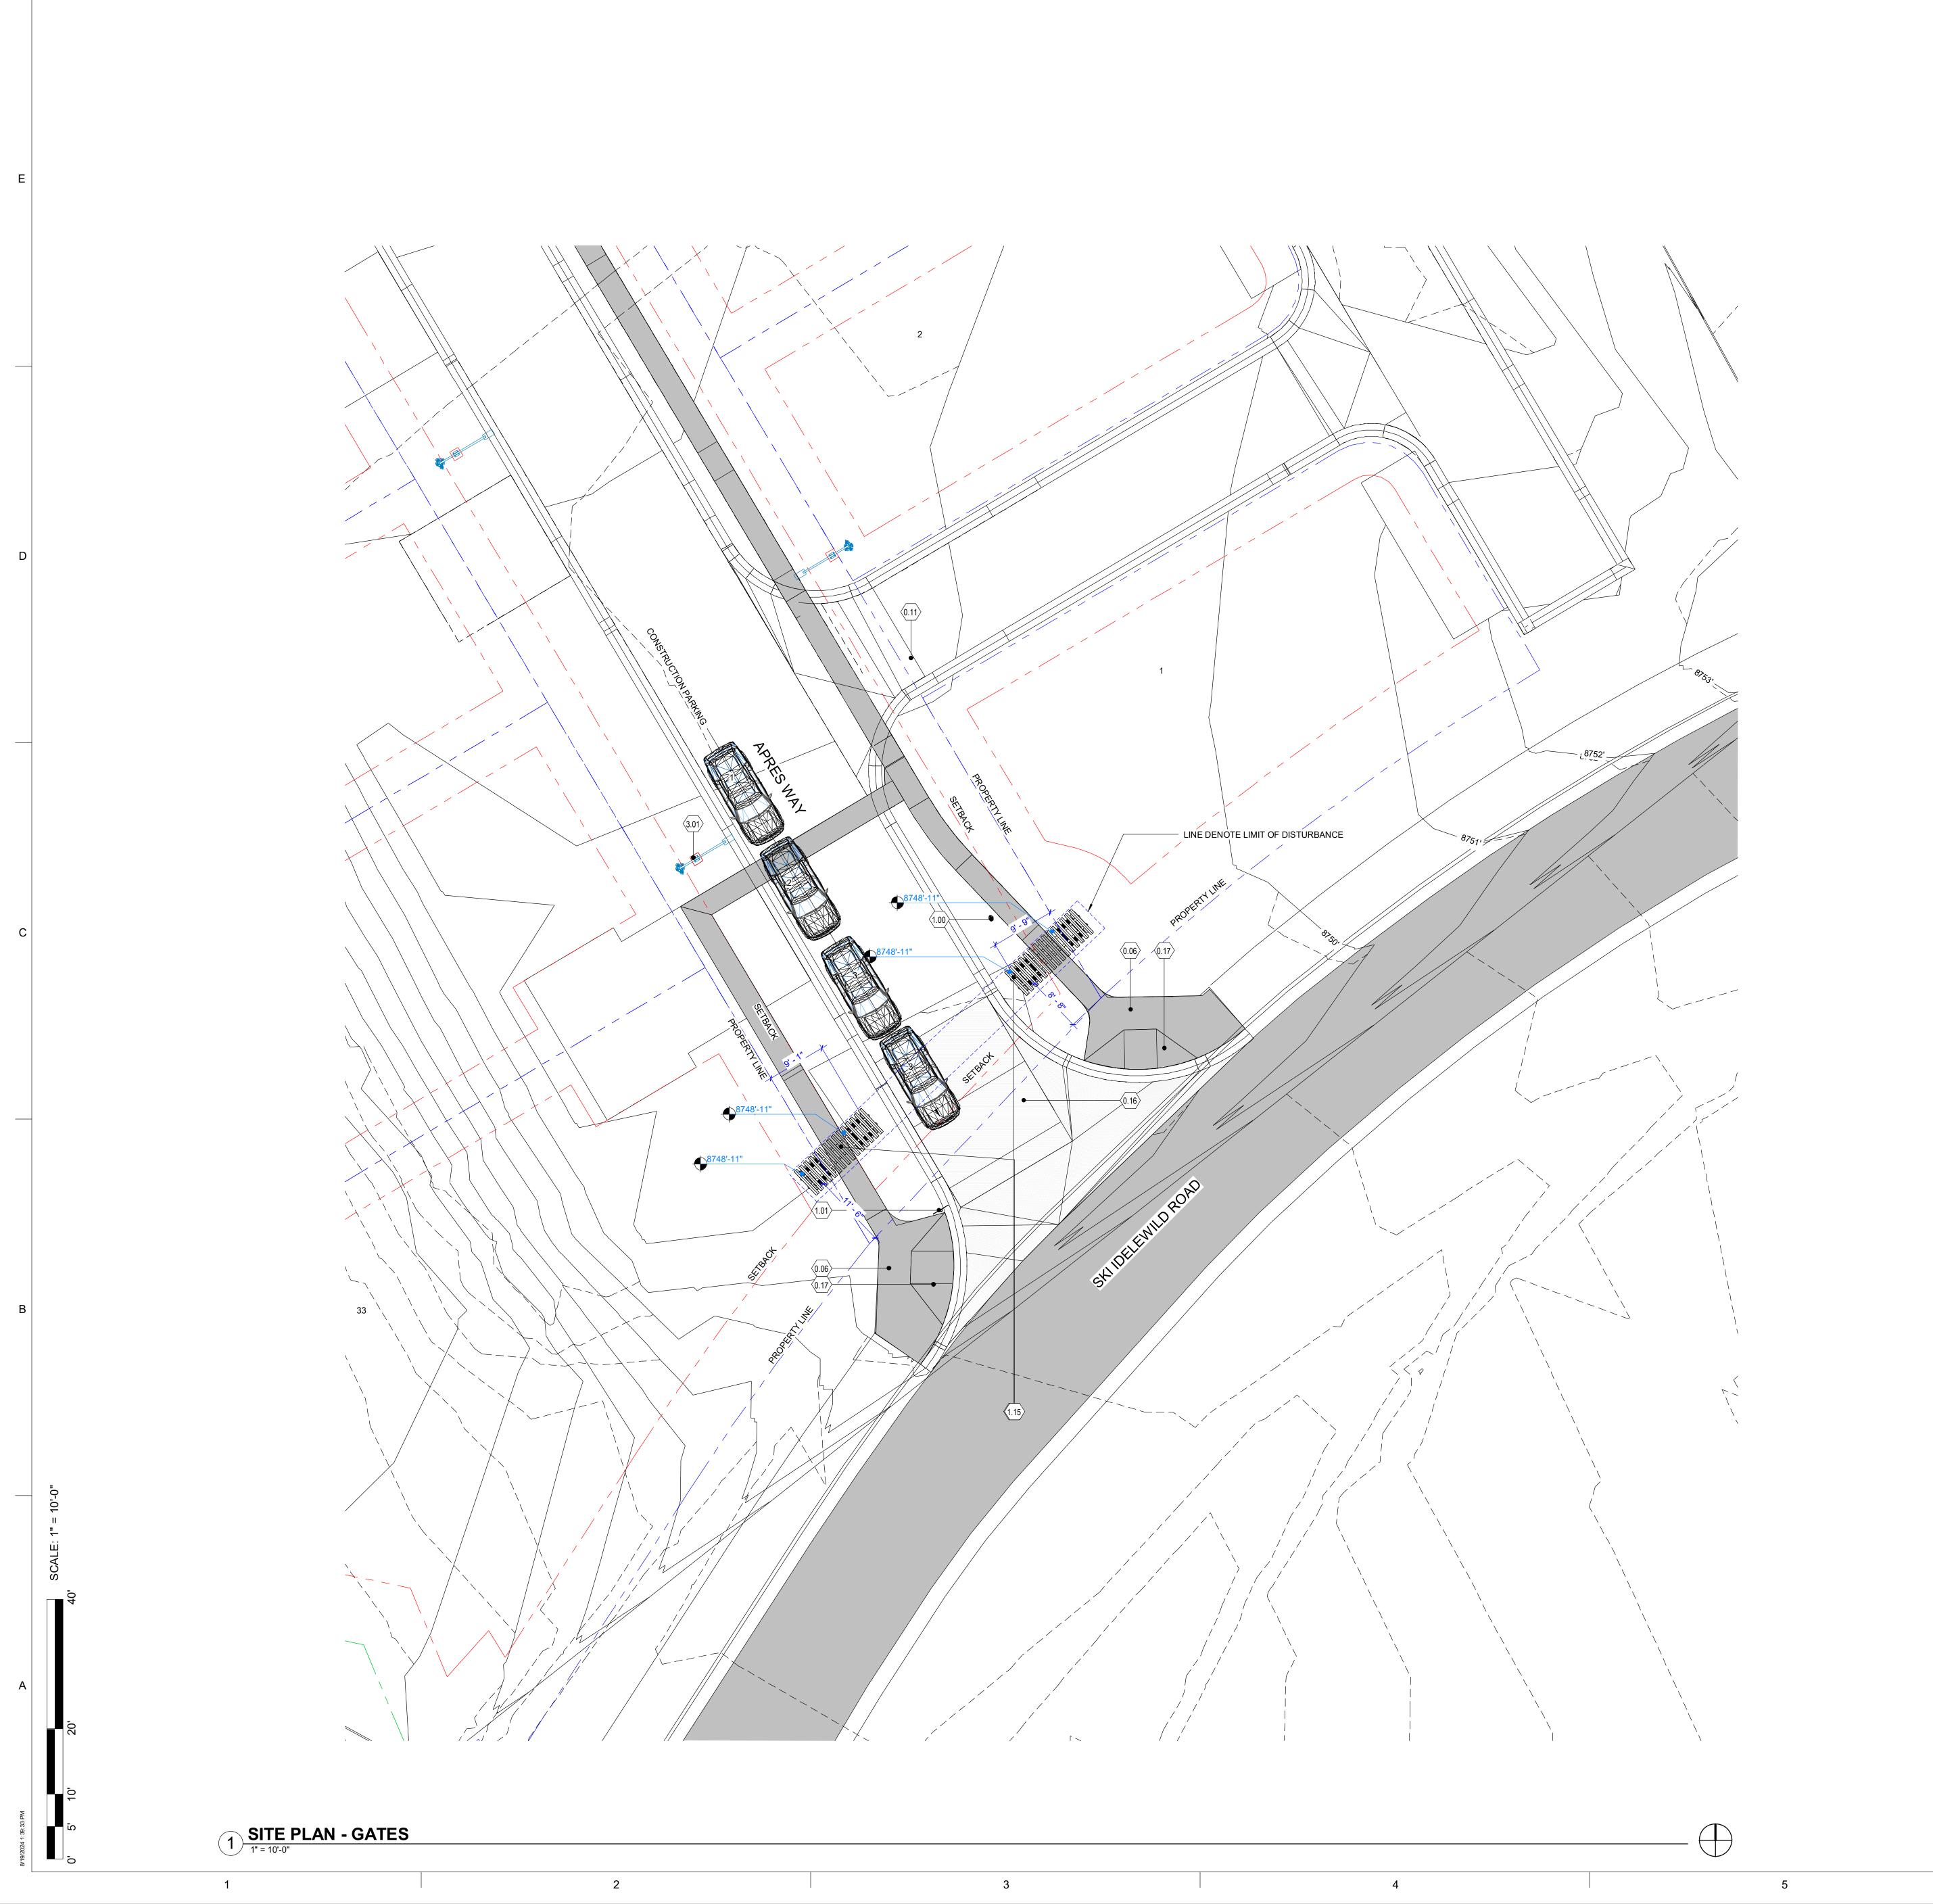



NASSAR

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Consultant

**ERIE** wes@nassardevelopment.com 303.775.5523

**GENERAL SITE PLAN NOTES:** 

 ALL DIMENSIONS TO FACE OF FOUNDATION WALL OR STRUCTURAL STRATA, UNLESS NOTED OTHERWISE. 2. VERIFY ALL SITE PARAMETERS (PROPERTY BOUNDARIES, EASEMENTS AND SETBACKS) PRIOR TO STAKING TO DEMOLITION AND

CONSTRUCTION. 3. CONTRACTOR TO VERIFY LOCATION OF ALL UNDERGROUND UTILITIES AND TO ARRANGE PROPER DISCONTINUANCE AND/OR RELOCATION

PRIOR TO DEMOLITION.

4. PROVIDE TREE AND SHRUB PROTECTION FOR EXISTING LANDSCAPING, ESPECIALLY FOR MATURE TREES MARKED TO BE

PROVIDE POSITIVE DRAINAGE AWAY FROM BUILDING PERIMETER; 10%
MINIMUM SLOPE FOR FIRST 10'. IT IS ESSENTIAL THAT SITE GRADING
BE PROVIDED TO PREVENT INFILTRATION OF SURFACE WATER INTO
THE FOUNDATION SYSTEM. REFER TO CIVIL DRAWINGS FOR GRADING

AND DRAINAGE.

6. REFER TO LANDSCAPE DRAWINGS FOR LANDSCAPE, EXTERIOR LANDSCAPE LIGHTING AND IRRIGATION PLANS.

MECHANICALLY COMPACT ALL FILL AROUND THE BUILDING,
INCLUDING THE BACKFILL. IMPROPER BACKFILL COMPACTION CAN

CAUSE SETTLEMENT OF EXTERIOR SLABS SUCH AS WALKS, PATIOS AND DRIVEWAYS.

DISCHARGE ROOF DOWN SPOUTS AND ALL OTHER WATER COLLECTION SYSTEMS MINIMUM 5' BEYOND PERIMETER OF STRUCTURE. RE: CIVIL DRAWINGS FOR HARD-PIPED DRAINS.

NO IRRIGATION WITHIN 5' OF THE FOUNDATION. AVOID HEAVY WATERING OF ANY FOUNDATION PLANTINGS.

10. PHOTOVOLTAIC SOLAR PANELS TO BE REVIEWED AND APPROVED

UNDER SEPERATE PERMIT

11. SITE WALLS UNDER SEPERATE PERMIT

Issue/Revisions Date

**Project Information** 

2 SITE COVERAGE - GATES

LOT COVERAGE **BUILDING COVERAGE** TOTAL LOT AREA 32239 SF TOTAL LOT COVERAGE 2754 / 32239 = 08%

**LEGEND** 

**PROTECTION SITE PLAN NOTES:** A. NO DISTURBANCE, GRADING, OR REMOVAL OF SIGNIFICANT NATURAL FEATURES AND VEGETATION WILL OCCUR BEYOND THE LIMIT OF DISTURBANCE LINE, AS SHOWN ON THIS

B. THE LIMIT OF DISTURBANCE LINE SHALL BE DELINEATED PRIOR TO CONSTRUCTION WITH FLAGS, ROPING, FOUR FOOT (4') TALL ORANGE CONSTRUCTION FENCING, OR OTHER ACCEPTABLE MEANS.


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MINOR SITE

PLAN APPLICATION 2024.08.19 Sheet Number:

Nassar Project:



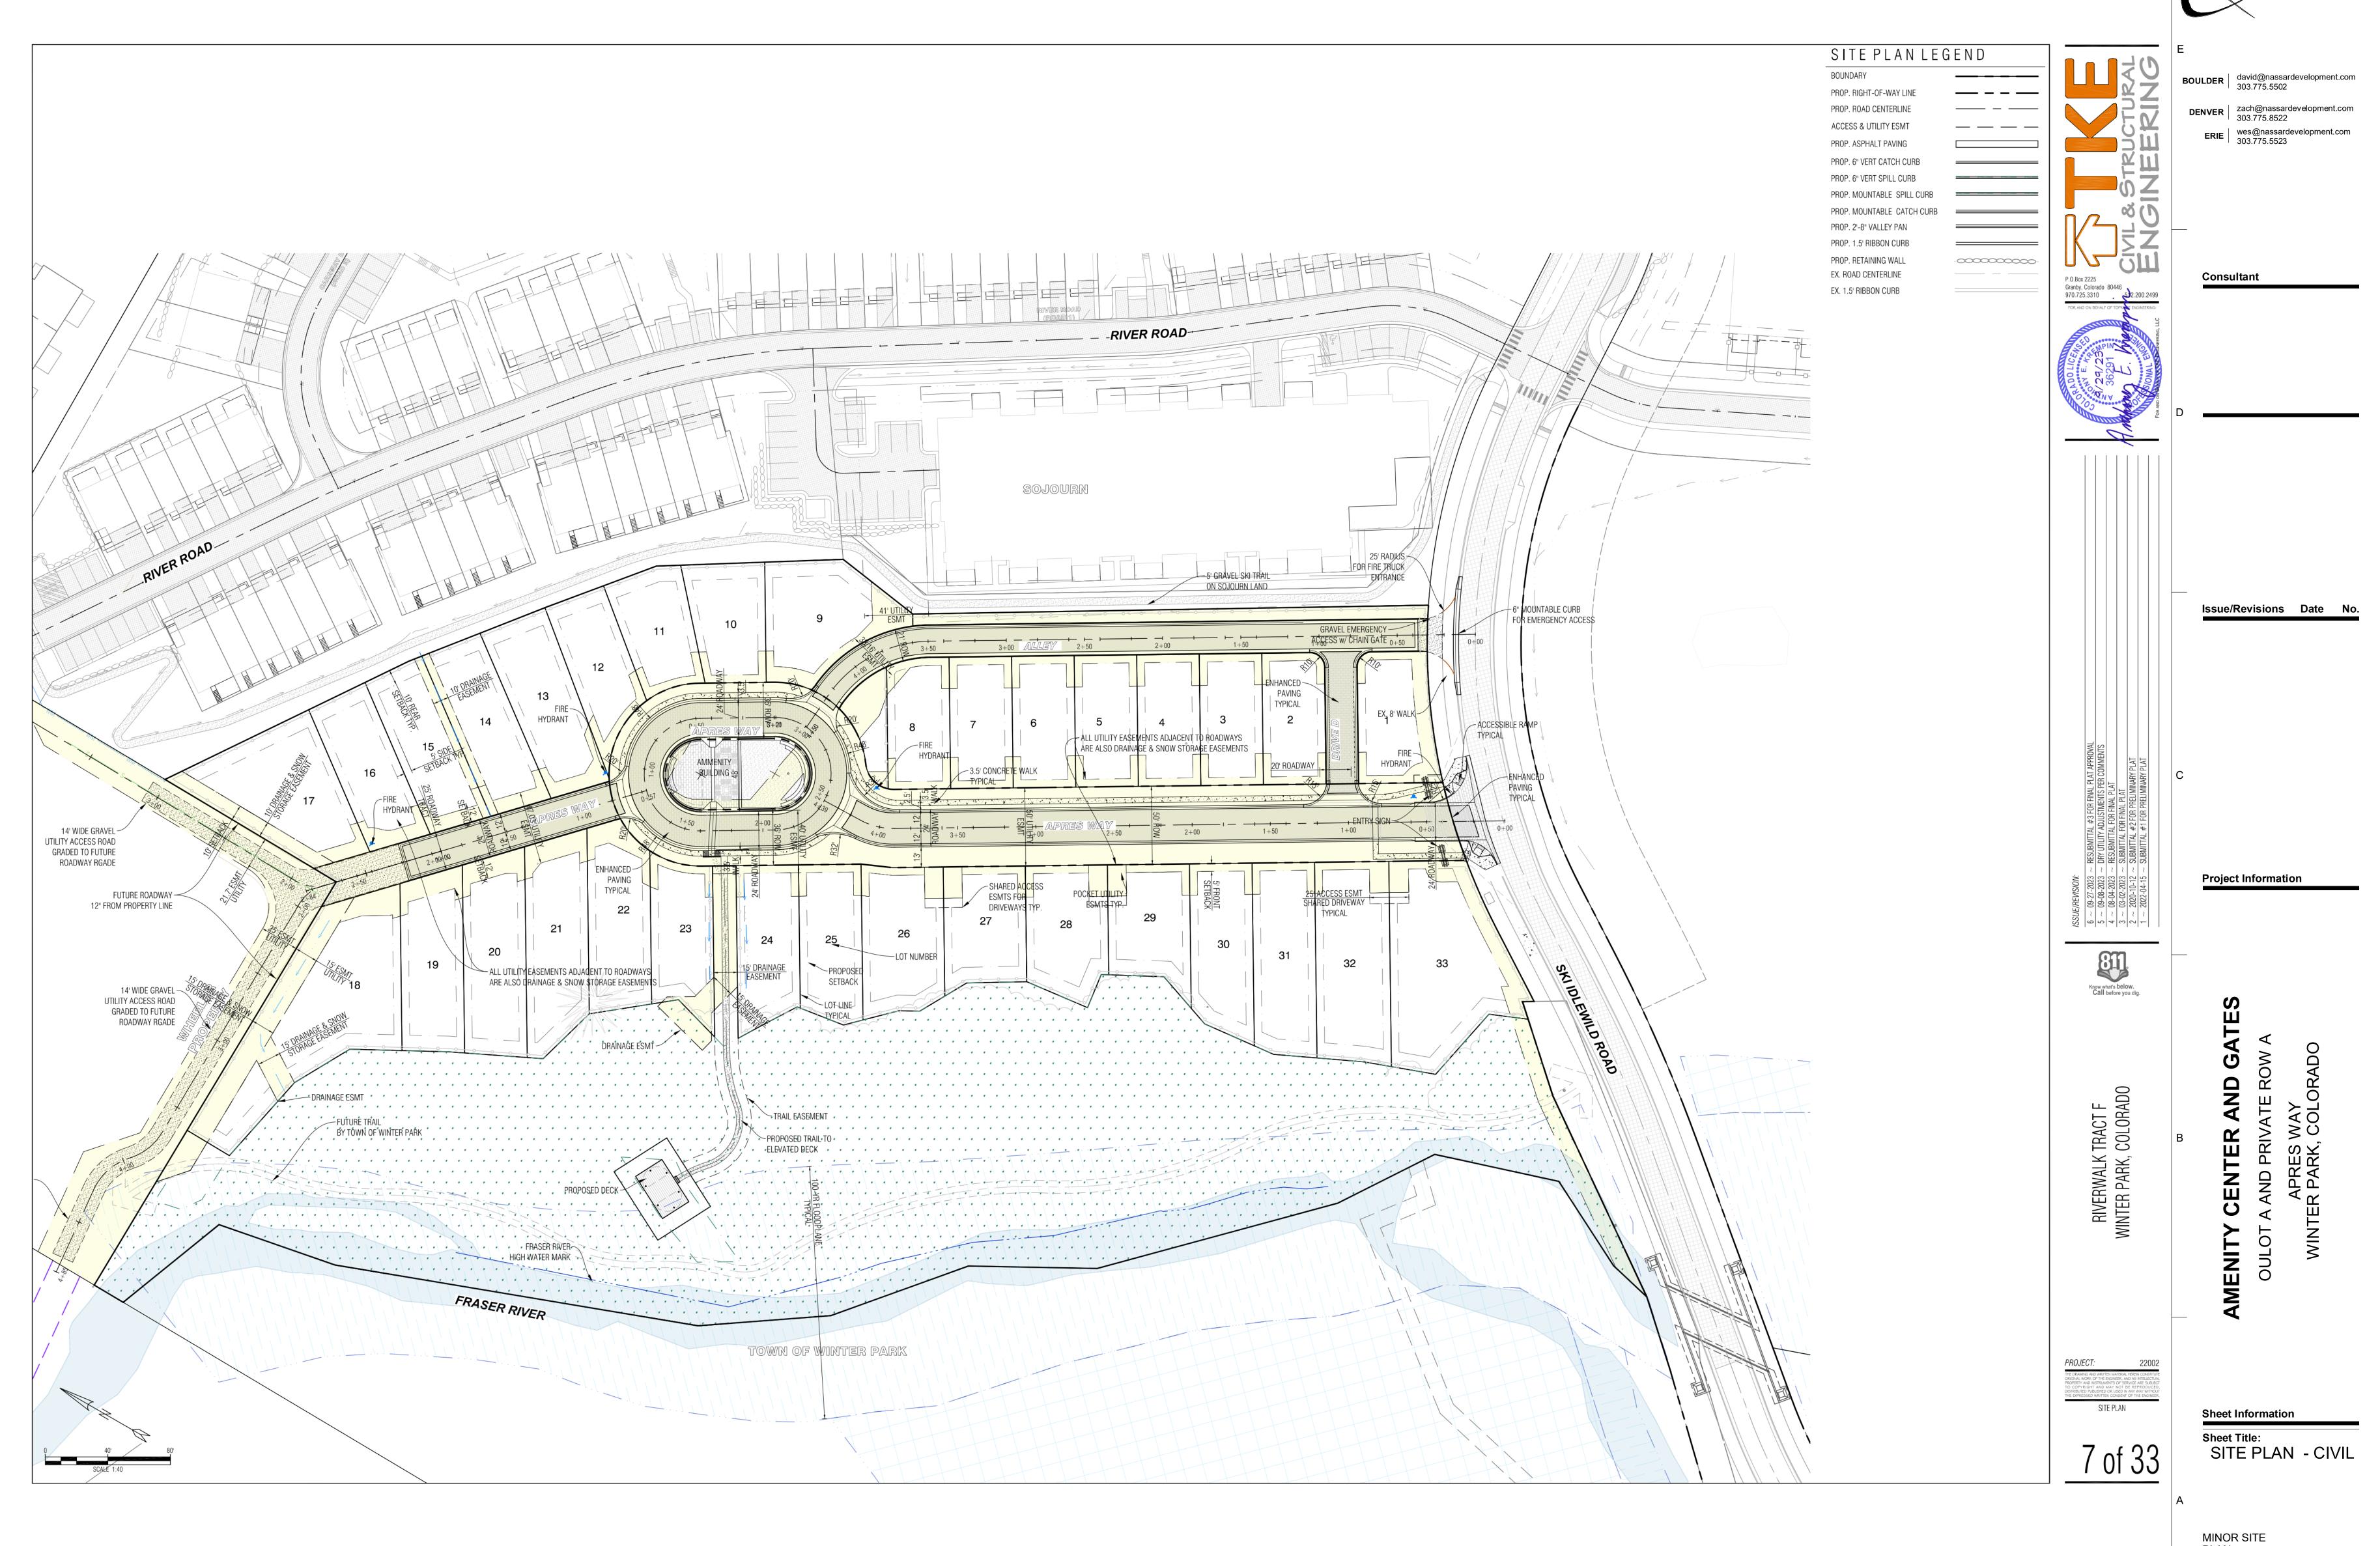



1 SITE PLAN - CIVIL
1" = 20'-0"

MINOR SITE
PLAN
APPLICATION 2024.08.19
Sheet Number:

C-3

Nassar Project: 2024.037

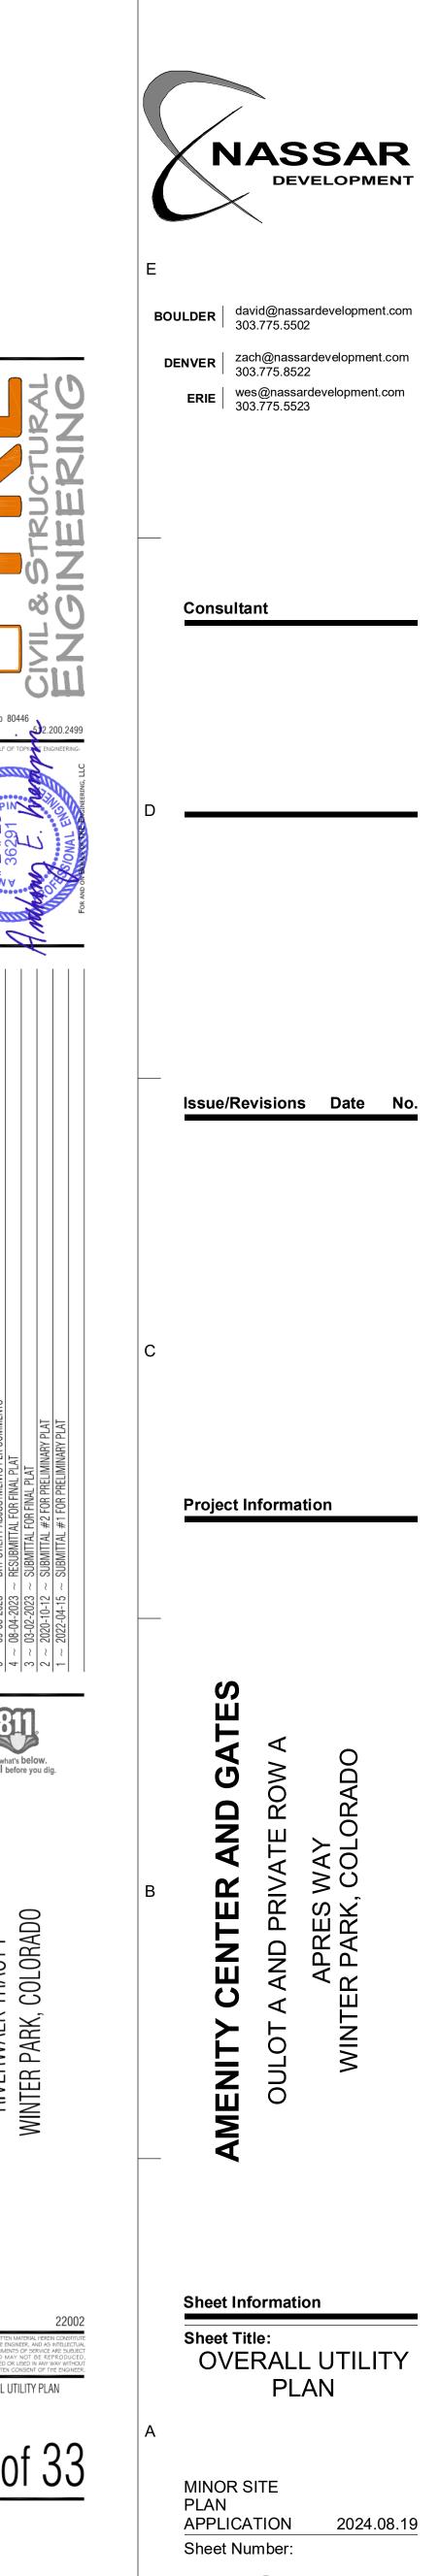

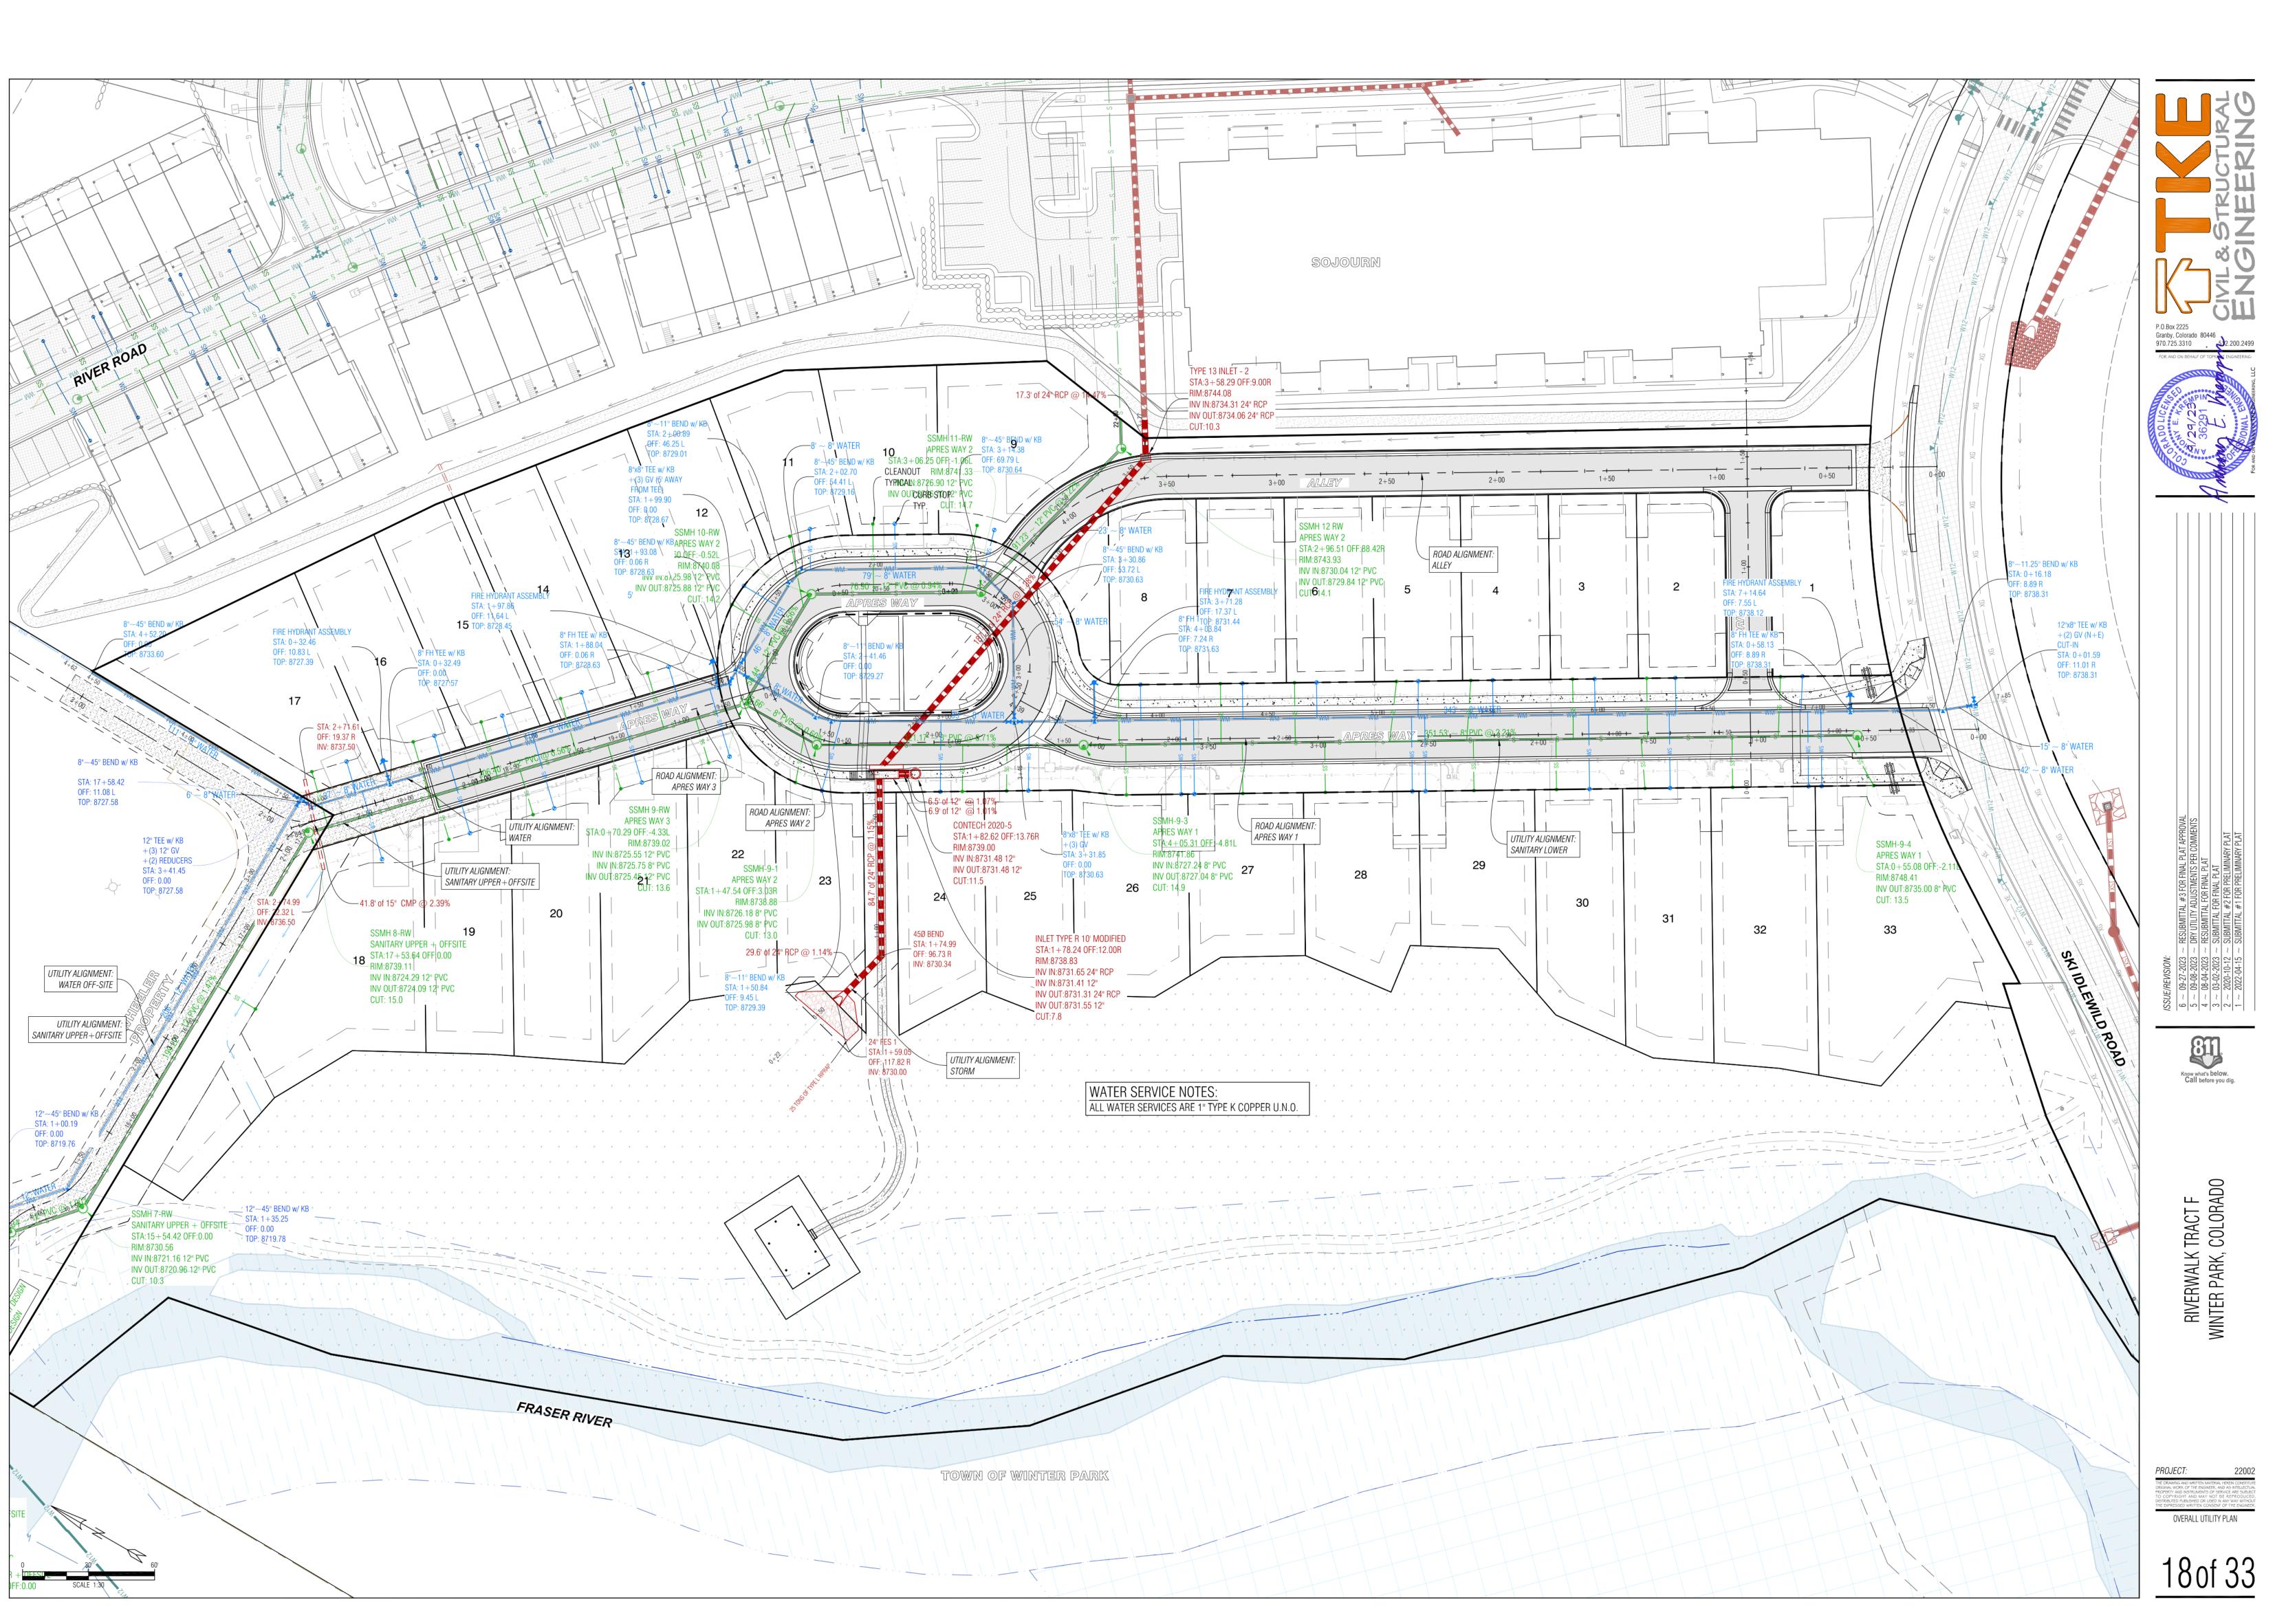

1 SITE PLAN - OVERALL UTILITY PLAN
1" = 20'-0"

# GENERAL ROOF PLAN NOTES:

SEE BUILDING SECTIONS FOR TYPICAL ROOF CONSTRUCTION.
 ROOFING CONTRACTOR TO FOLLOW MANUFACTURER'S
INSTALLATION SPECIFICATIONS FOR LOW SLOPE ROOFS WHERE
APPLICABLE.
 ROOFING CONTRACTOR TO FOLLOW MANUFACTURER'S FLASHING
RECOMMENDATIONS AT ALL EAVES, VALLEYS, ABUTTING WALLS,
INTERSECTING WALLS, CHIMNEY VENTS AND STACKS.
 PROVIDE 5' EXTENSIONS AT ALL DOWNSPOUT LOCATIONS PER CIVIL
DRAWINGS, U.N.O., EXCEPT WHERE CONNECTED TO A TIGHTLINE
DRAINAGE SYSTEM.
 LOCATIONS OF ALL TERMINATIONS FOR VENT STACKS, EXHAUST
FANS, DRYER VENTS, ETC. MUST BE APPROVED BY ARCHITECT.

6. ALL GUTTERS/DOWNSPOUTS ARE REQUIRED PER SUMMIT COUNTY.

	KEYNOTE LEGEND
KEY VALUE	KEYNOTE TEXT
0.04	EXTERIOR LIGHT FIXTURE - DARK SKY COMPLIANT
0.09	AFFIXED BARBEQUE GRILL
0.12	CONCRETE FOUNDATION PIER - CAST IN PLACE CONCRETE
0.14	COLUMN BASE WITH CUSTOM STEEL STANDOFF - BLACK PATI
1.09	COMPOSITE FLOOR DECK - CONCRETE
1.10	ROOF GUTTER - PATINA COPPER
2.01	STANDING SEAM METAL ROOFING - PATINA COPPER - TEE-PA CLASS A ROOF ASSEMBLY
2.07	S4S WOOD HEAVY TIMBER - SEMI TRANSPARENT STAIN - LIGI CHARCOAL GREYTONE
2.08	SHEET METAL FLASHING DRIP EDGE - PATINA COPPER
2.12	CEDAR WOOD FASCIA - SEMI TRANSPARENT STAIN - LIGHT CHARCOAL GREYTONE
2.14	ARCHITECTURAL STEEL RAILING - PAINTED BLACK
2.15	HEAVY TIMBER - SNOW GUARDS



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Consultant

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ERIE wes@nassardevelopment.com 303.775.5523

Issue/Revisions Date No


Project Information



MATERIAL LEGEND - PAVILION

1.10 - ROOF GUTTER - PATINA COPPER

0.12 - CONCRETE FOUNDATION PIER - CAST IN PLACE CONCRETE

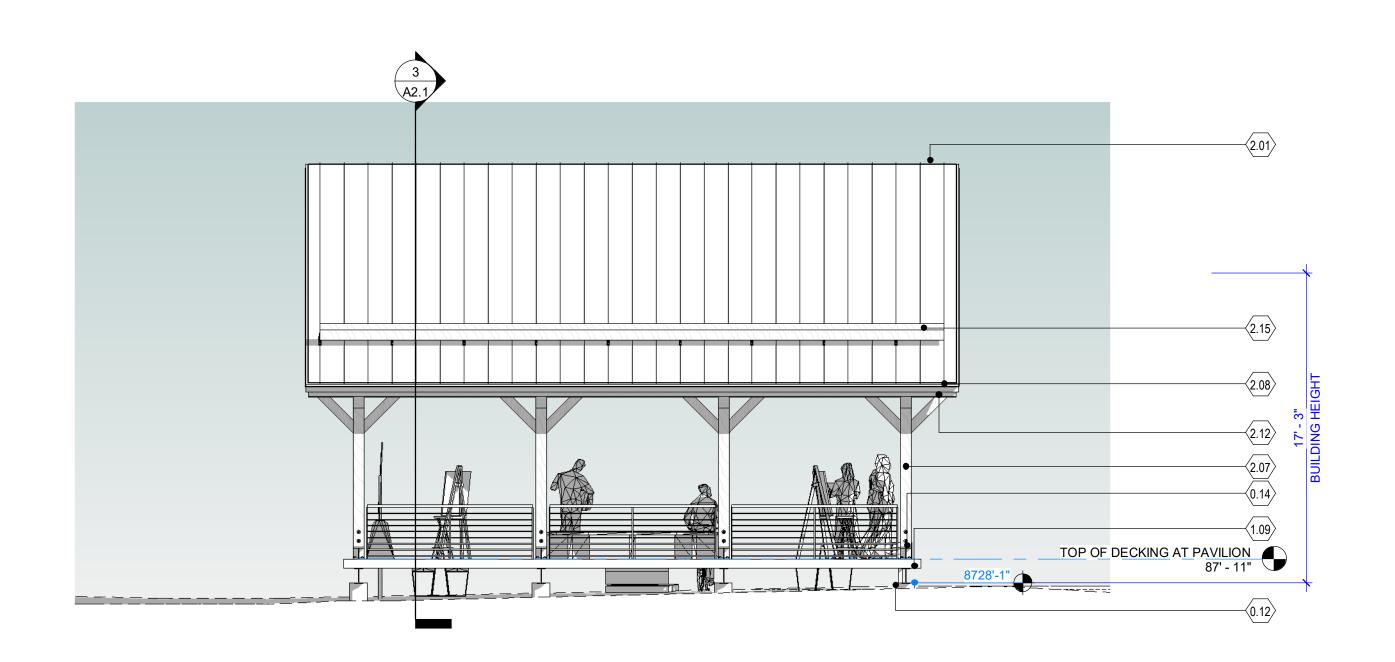

2.15 - HEAVY TIMBER - SNOW GUARDS

2.01 - STANDING SEAM METAL ROOFING - PATINA COPPER


WEST ELEVATION - PAVILION

3/16" = 1'-0"

3 SOUTH ELEVATION - PAVILION
3/16" = 1'-0"


1.09 - CONCRETE PAN DECKING - CONCRETE

2.07 - S4S HEAVY TIMBER - GREY SEMI-TRANSPARENT STAIN

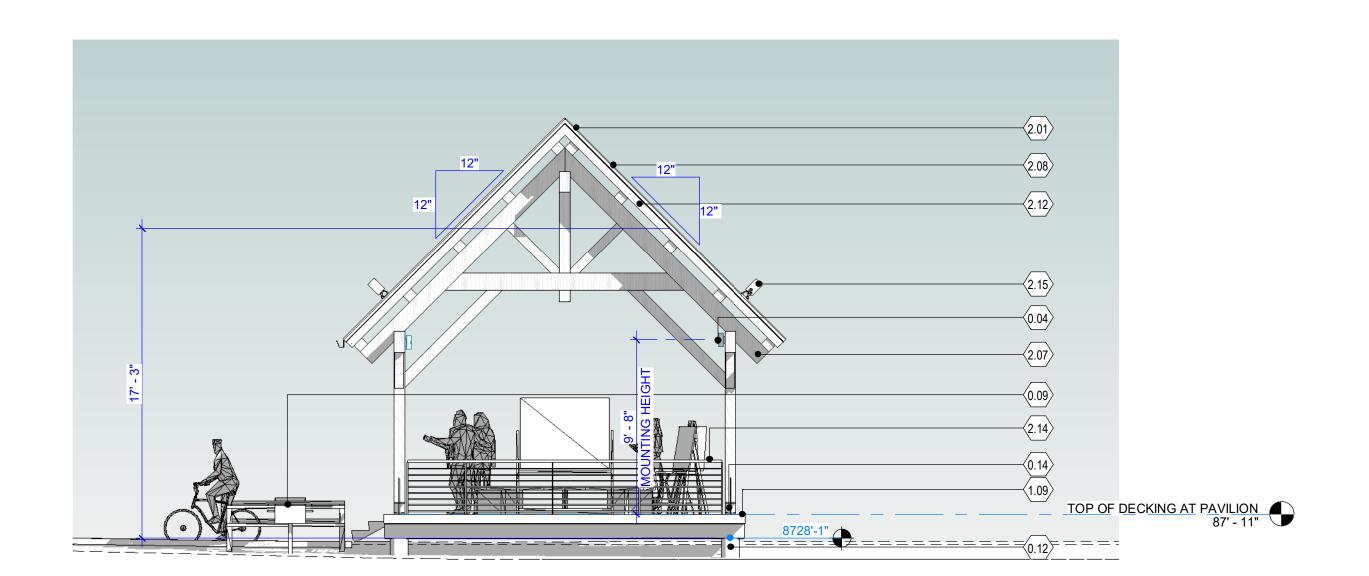

NORTH ELEVATION - PAVILION

3/16" = 1'-0"

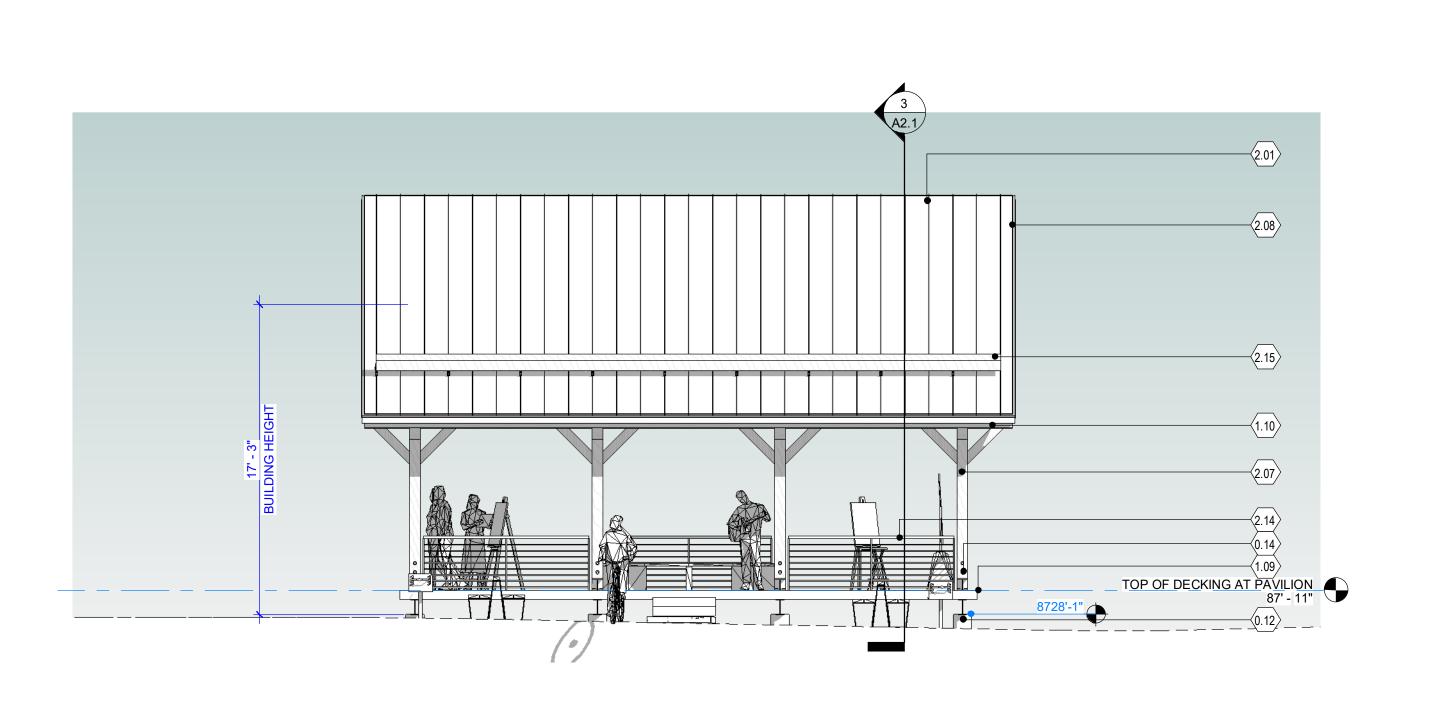

1 EAST ELEVATION - PAVILION
3/16" = 1'-0"

MINOR SITE
PLAN
APPLICATION 2024.08.19

Sheet Number:

**Sheet Information** 

EXTERIOR ELEVATIONS -

**PAVILION** 

Sheet Title:

A2.2

Nassar Project: 2024.037
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	KEYNOTE LEGEND
KEY VALUE	KEYNOTE TEXT
0.05	AMPHITHEATER BOULDER SEATING
0.14	COLUMN BASE WITH CUSTOM STEEL STANDOFF - BLACK PA
1.16	NATURAL STONE CAP
2.01	STANDING SEAM METAL ROOFING - PATINA COPPER - TEE-F CLASS A ROOF ASSEMBLY
2.04	THIN DEPTH NATURAL STONE VENEER - TELLURIDE GOLD B
2.07	S4S WOOD HEAVY TIMBER - SEMI TRANSPARENT STAIN - LICHARCOAL GREYTONE
2.12	CEDAR WOOD FASCIA - SEMI TRANSPARENT STAIN - LIGHT CHARCOAL GREYTONE
2.15	HEAVY TIMBER - SNOW GUARDS



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Project Information


**Sheet Information** 

Sheet Title: EXTERIOR ELEVATIONS -AMENITY CENTER

MINOR SITE
PLAN
APPLICATION 2024.08.19

Sheet Number:

Nassar Project:
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WEST ELEVATION - AMENTITY CENTER

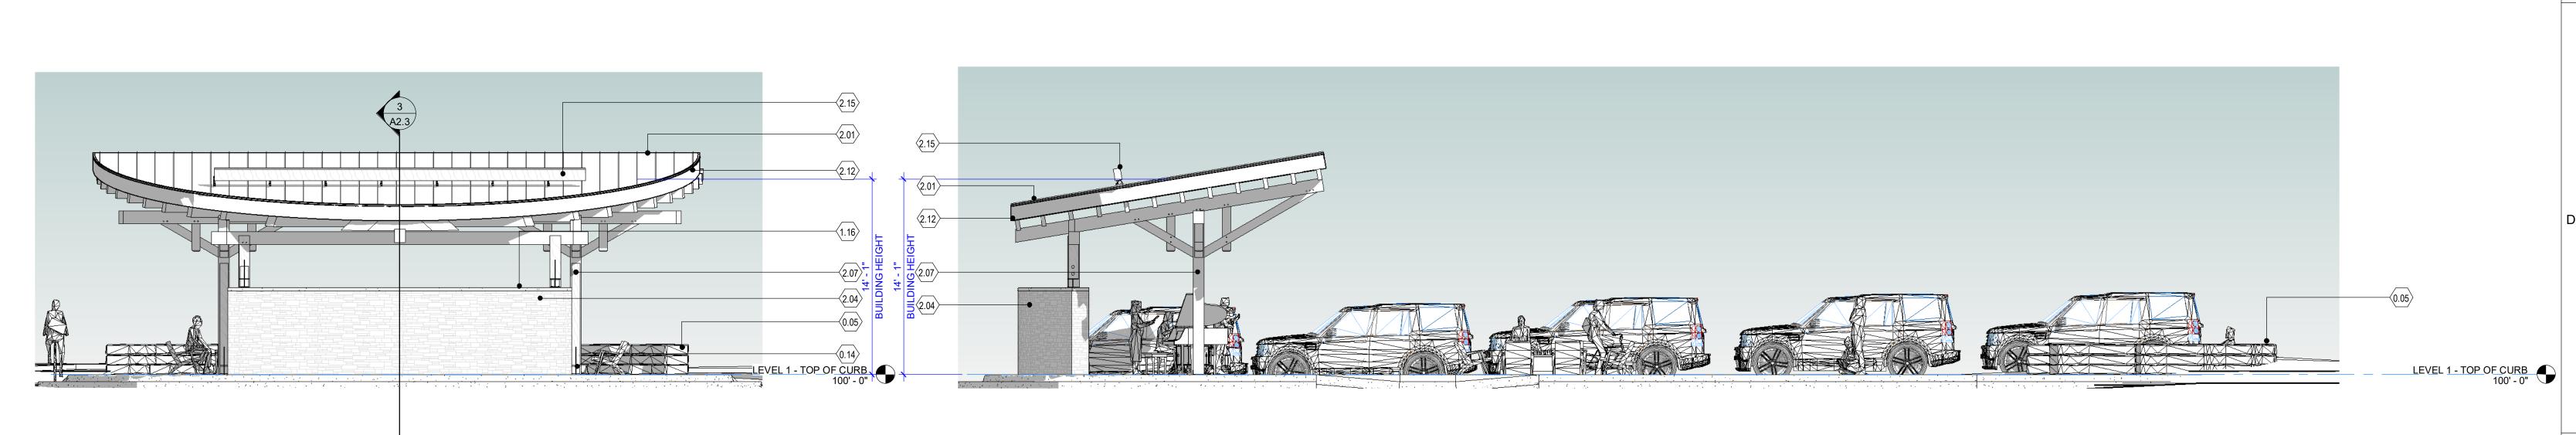3/16" = 1'-0"

3 SOUTH ELEVATION - AMENITY CENTER


1.11 - MC CHANNEL AND TIMBER TRELLIS

**MATERIAL LEGEND - AMENITY AND GATES** 

2.01 - STANDING SEAM METAL ROOFING - PATINA COPPER

2.04 - THIN DEPTH NATURAL STONE VENEER -TELLURIDE GOLD BLEND



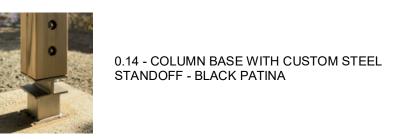





0.05 - AMPHITHEATER BOULDER SEATING

2.07 - S4S HEAVY TIMBER - GREY SEMI-TRANSPARENT STAIN

1.14 - PERFORATED METAL PANEL - HEXAGON


2.15 - HEAVY TIMBER - SNOW GUARDS


1.16 - NATURAL STONE CAP


0.05

1 EAST ELEVATION - AMENITY CENTER
3/16" = 1'-0"

2 NORTH ELEVATION - AMENITY CENTER
3/16" = 1'-0"

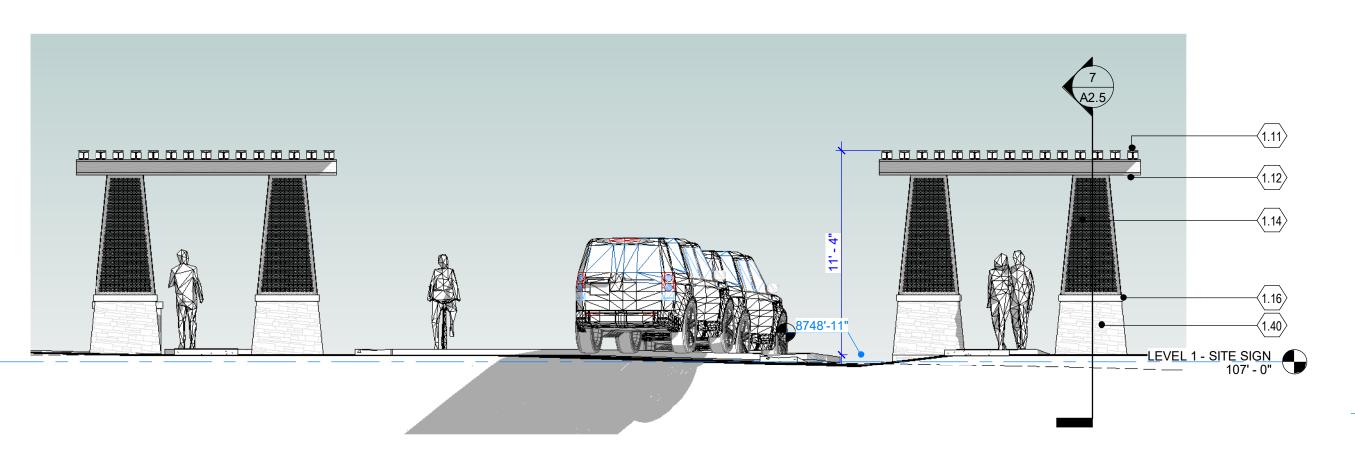

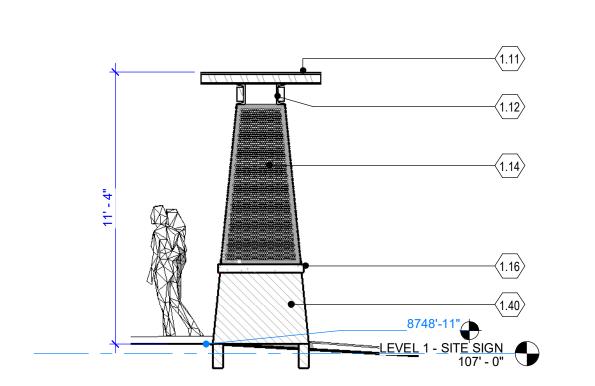

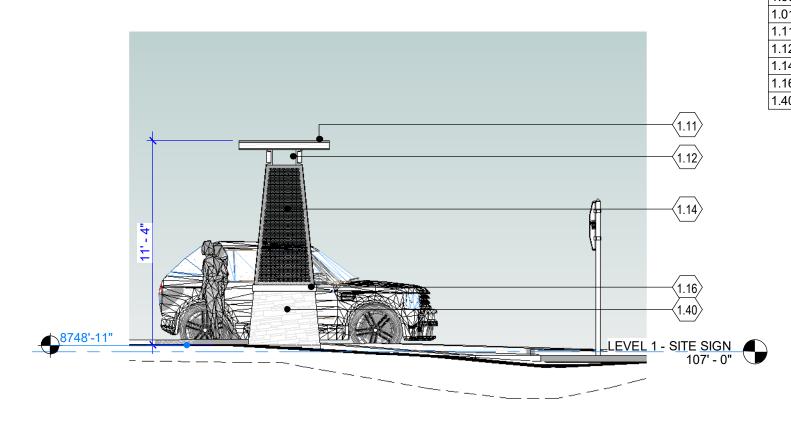



KEYNOTE LEGEND

CONCRETE SIDE WALK ENHANCED PAVING ACCESSIBLE RAMP

W-BEAM AND TIMBER TRELLIS

MC CHANNEL AND TIMBER CROSS BEAMS
PERFORATED METAL PANEL - HEXAGON

NATURAL STONE CAP
NATURAL STONE VENEER - TAPERED BASE

FIRE HYDRANT STOP SIGN

KEY VALUE

KEYNOTE TEXT

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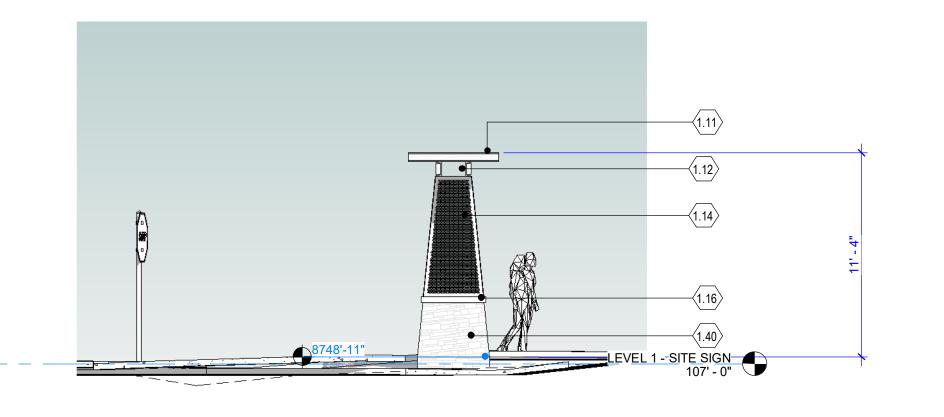
Consultant

Issue/Revisions Date

**Project Information** 

7 SECTION DETAIL AT PEDESTRIAN GATE 5 SOUTH ELEVATION - PEDESTRIAN GATE


3/16" = 1'-0"




NORTH ELEVATION - PEDESTRIAN GATE


3/16" = 1'-0"

6 WEST ELEVATION - PEDESTRIAN GATE

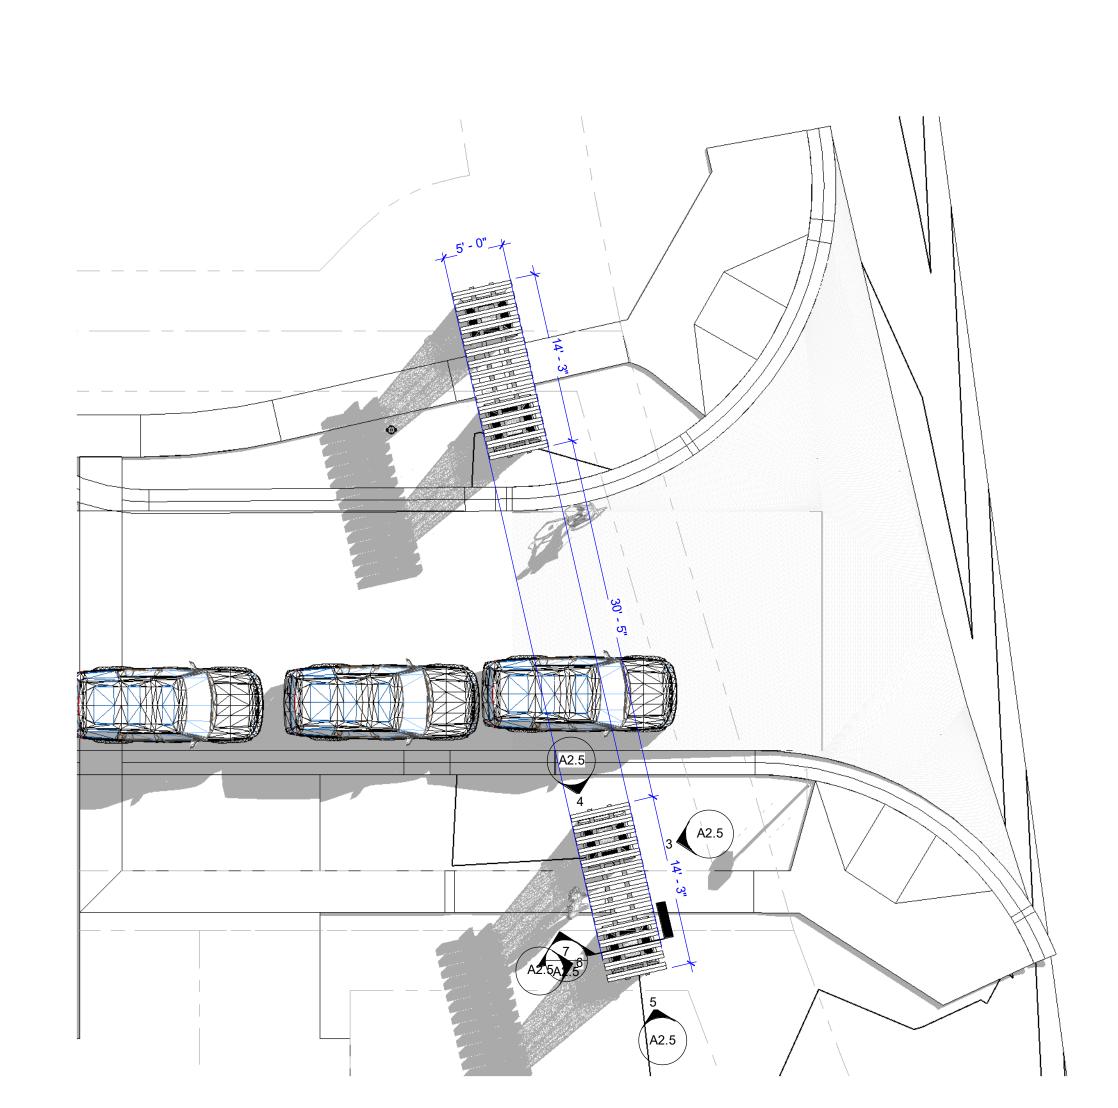


3 EAST ELEVATION - PEDESTRIAN GATE

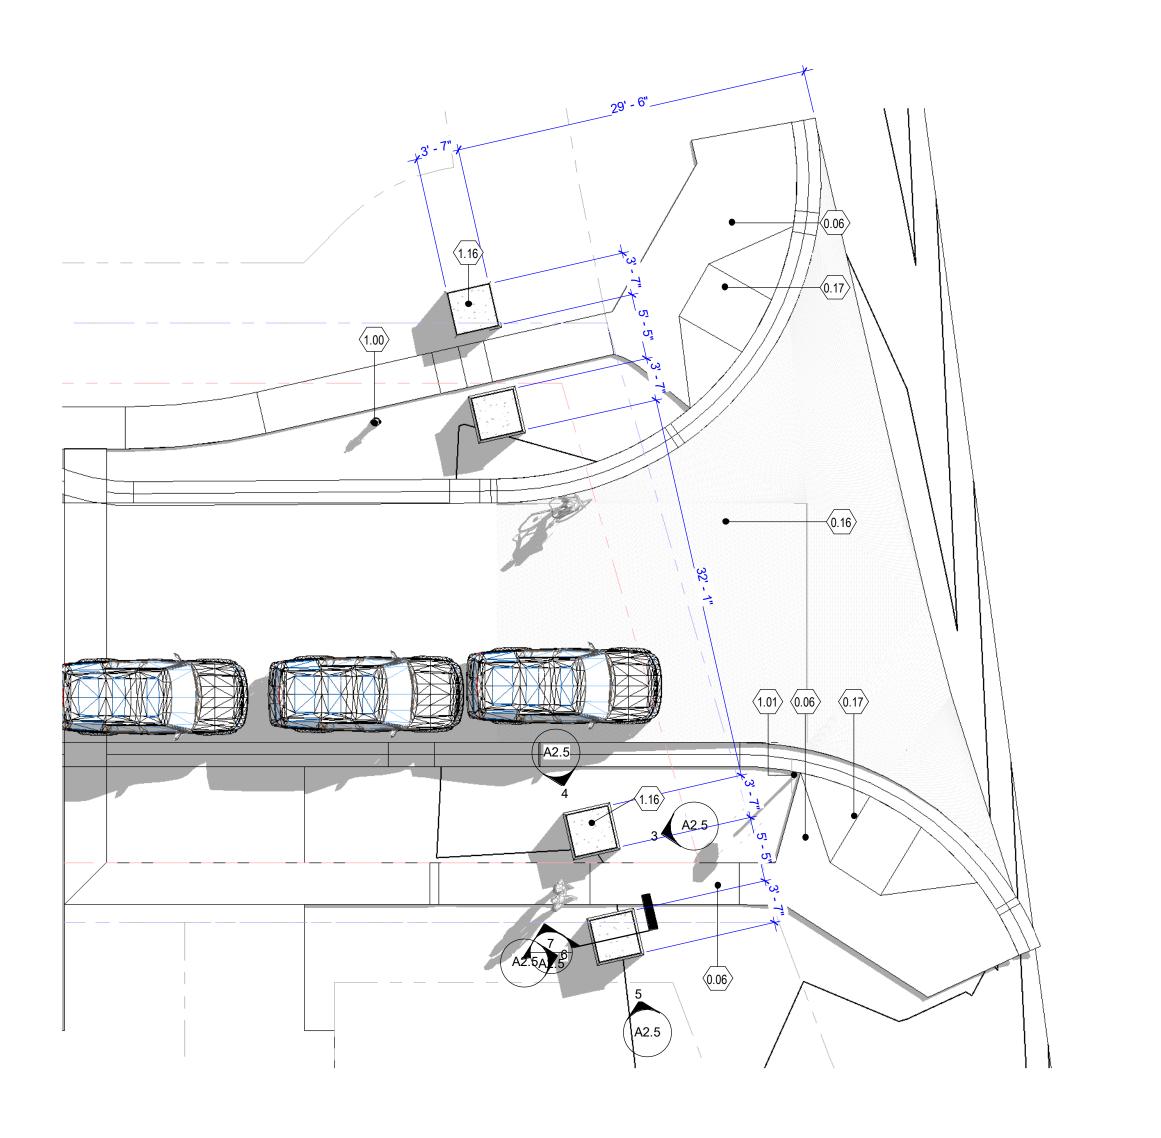

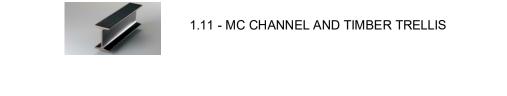






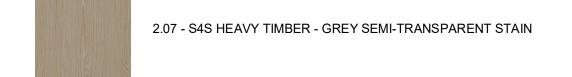




1.16 - NATURAL STONE CAP

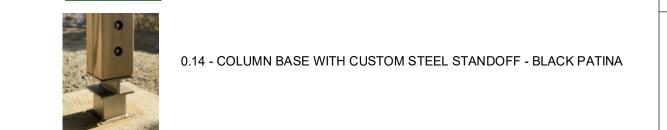



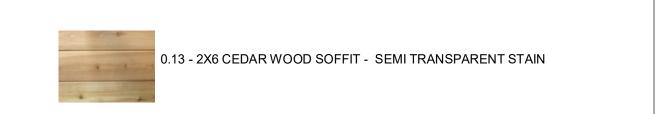

***********
<del>}</del>
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1.14 - PERFORATED METAL PANEL - HEXAGON
<del></del>

**MATERIAL LEGEND - AMENITY AND GATES** 

**Sheet Information** PLANS ELEVATIONS AND DETAIL AT ENTRY

GATE MINOR SITE PLAN APPLICATION 2024.08.19

Sheet Number:

Nassar Project: 2024.037

2 TRELLIS PLAN AT PEDESTRIAN GATES


1 PLAN AT PEDESTRIAN GATES
1/8" = 1'-0"










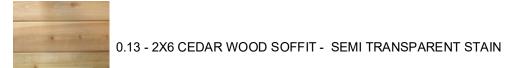




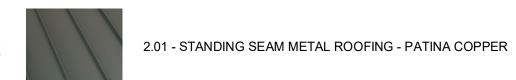



2.07 - S4S HEAVY TIMBER - GREY SEMI-TRANSPARENT STAIN

2.14 - ARCHITECTURAL STEEL RAILING-PAINTED BLACK

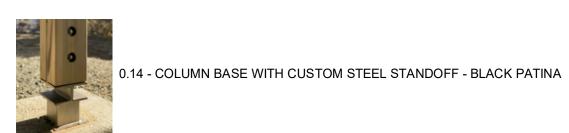

# **MATERIAL LEGEND - PAVILION**



1 MATERIAL VIEW



Project title: PAVILION - OUTLOT D

**KEYNOTE LEGEND** 

KEYNOTE TEXT






1.11 - MC CHANNEL AND TIMBER TRELLIS



2.04 - THIN DEPTH NATURAL STONE VENEER -TELLURIDE GOLD BLEND



2.12 - CEDAR WOOD FASCIA - SEMI TRANSPARENT STAIN

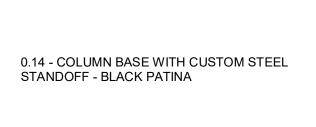

0.13 - 2X6 CEDAR WOOD SOFFIT - SEMI TRANSPARENT STAIN



1.40 - NATURAL STONE VENEER - LIMESTONE




2.01 - STANDING SEAM METAL ROOFING - PATINA COPPER



2.07 - S4S HEAVY TIMBER - GREY SEMI-TRANSPARENT STAIN



1.16 - NATURAL STONE CAP

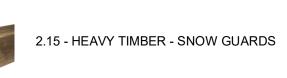

1.14 - PERFORATED METAL PANEL - HEXAGON



0.05 - AMPHITHEATER BOULDER SEATING

# **MATERIAL LEGEND - AMENITY AND GATES**



MATERIAL VIEW - AMENITY CENTER

3/16" = 1'-0"

PAVILION - OUTLOT D


APRES WAY
WINTER PARK, COLORADO
Project Issue: MINOR SITE PLAN APPLICATION Project Number: 2024.037










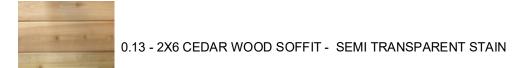




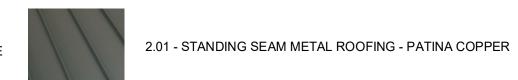



2.07 - S4S HEAVY TIMBER - GREY SEMI-TRANSPARENT STAIN

2.14 - ARCHITECTURAL STEEL RAILING-PAINTED BLACK

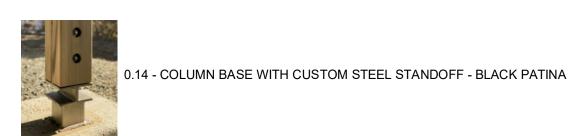

# **MATERIAL LEGEND - PAVILION**



1 MATERIAL VIEW



Project title: PAVILION - OUTLOT D

APRES WAY
WINTER PARK, COLORADO
Project Issue: MINOR SITE PLAN APPLICATION

**KEYNOTE LEGEND** 

KEYNOTE TEXT





1.11 - MC CHANNEL AND TIMBER TRELLIS



2.04 - THIN DEPTH NATURAL STONE VENEER -TELLURIDE GOLD BLEND



2.12 - CEDAR WOOD FASCIA - SEMI TRANSPARENT STAIN



0.13 - 2X6 CEDAR WOOD SOFFIT - SEMI TRANSPARENT STAIN



1.40 - NATURAL STONE VENEER - LIMESTONE



2.01 - STANDING SEAM METAL ROOFING - PATINA COPPER




2.07 - S4S HEAVY TIMBER - GREY SEMI-TRANSPARENT STAIN



1.16 - NATURAL STONE CAP



2.15 - HEAVY TIMBER - SNOW GUARDS

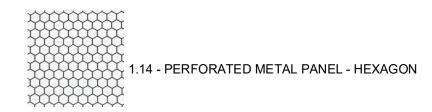



0.05 - AMPHITHEATER BOULDER SEATING

**MATERIAL LEGEND - AMENITY AND GATES** 




MATERIAL VIEW - AMENITY CENTER

3/16" = 1'-0"

PAVILION - OUTLOT D

APRES WAY
WINTER PARK, COLORADO
Project Issue: MINOR SITE PLAN APPLICATION

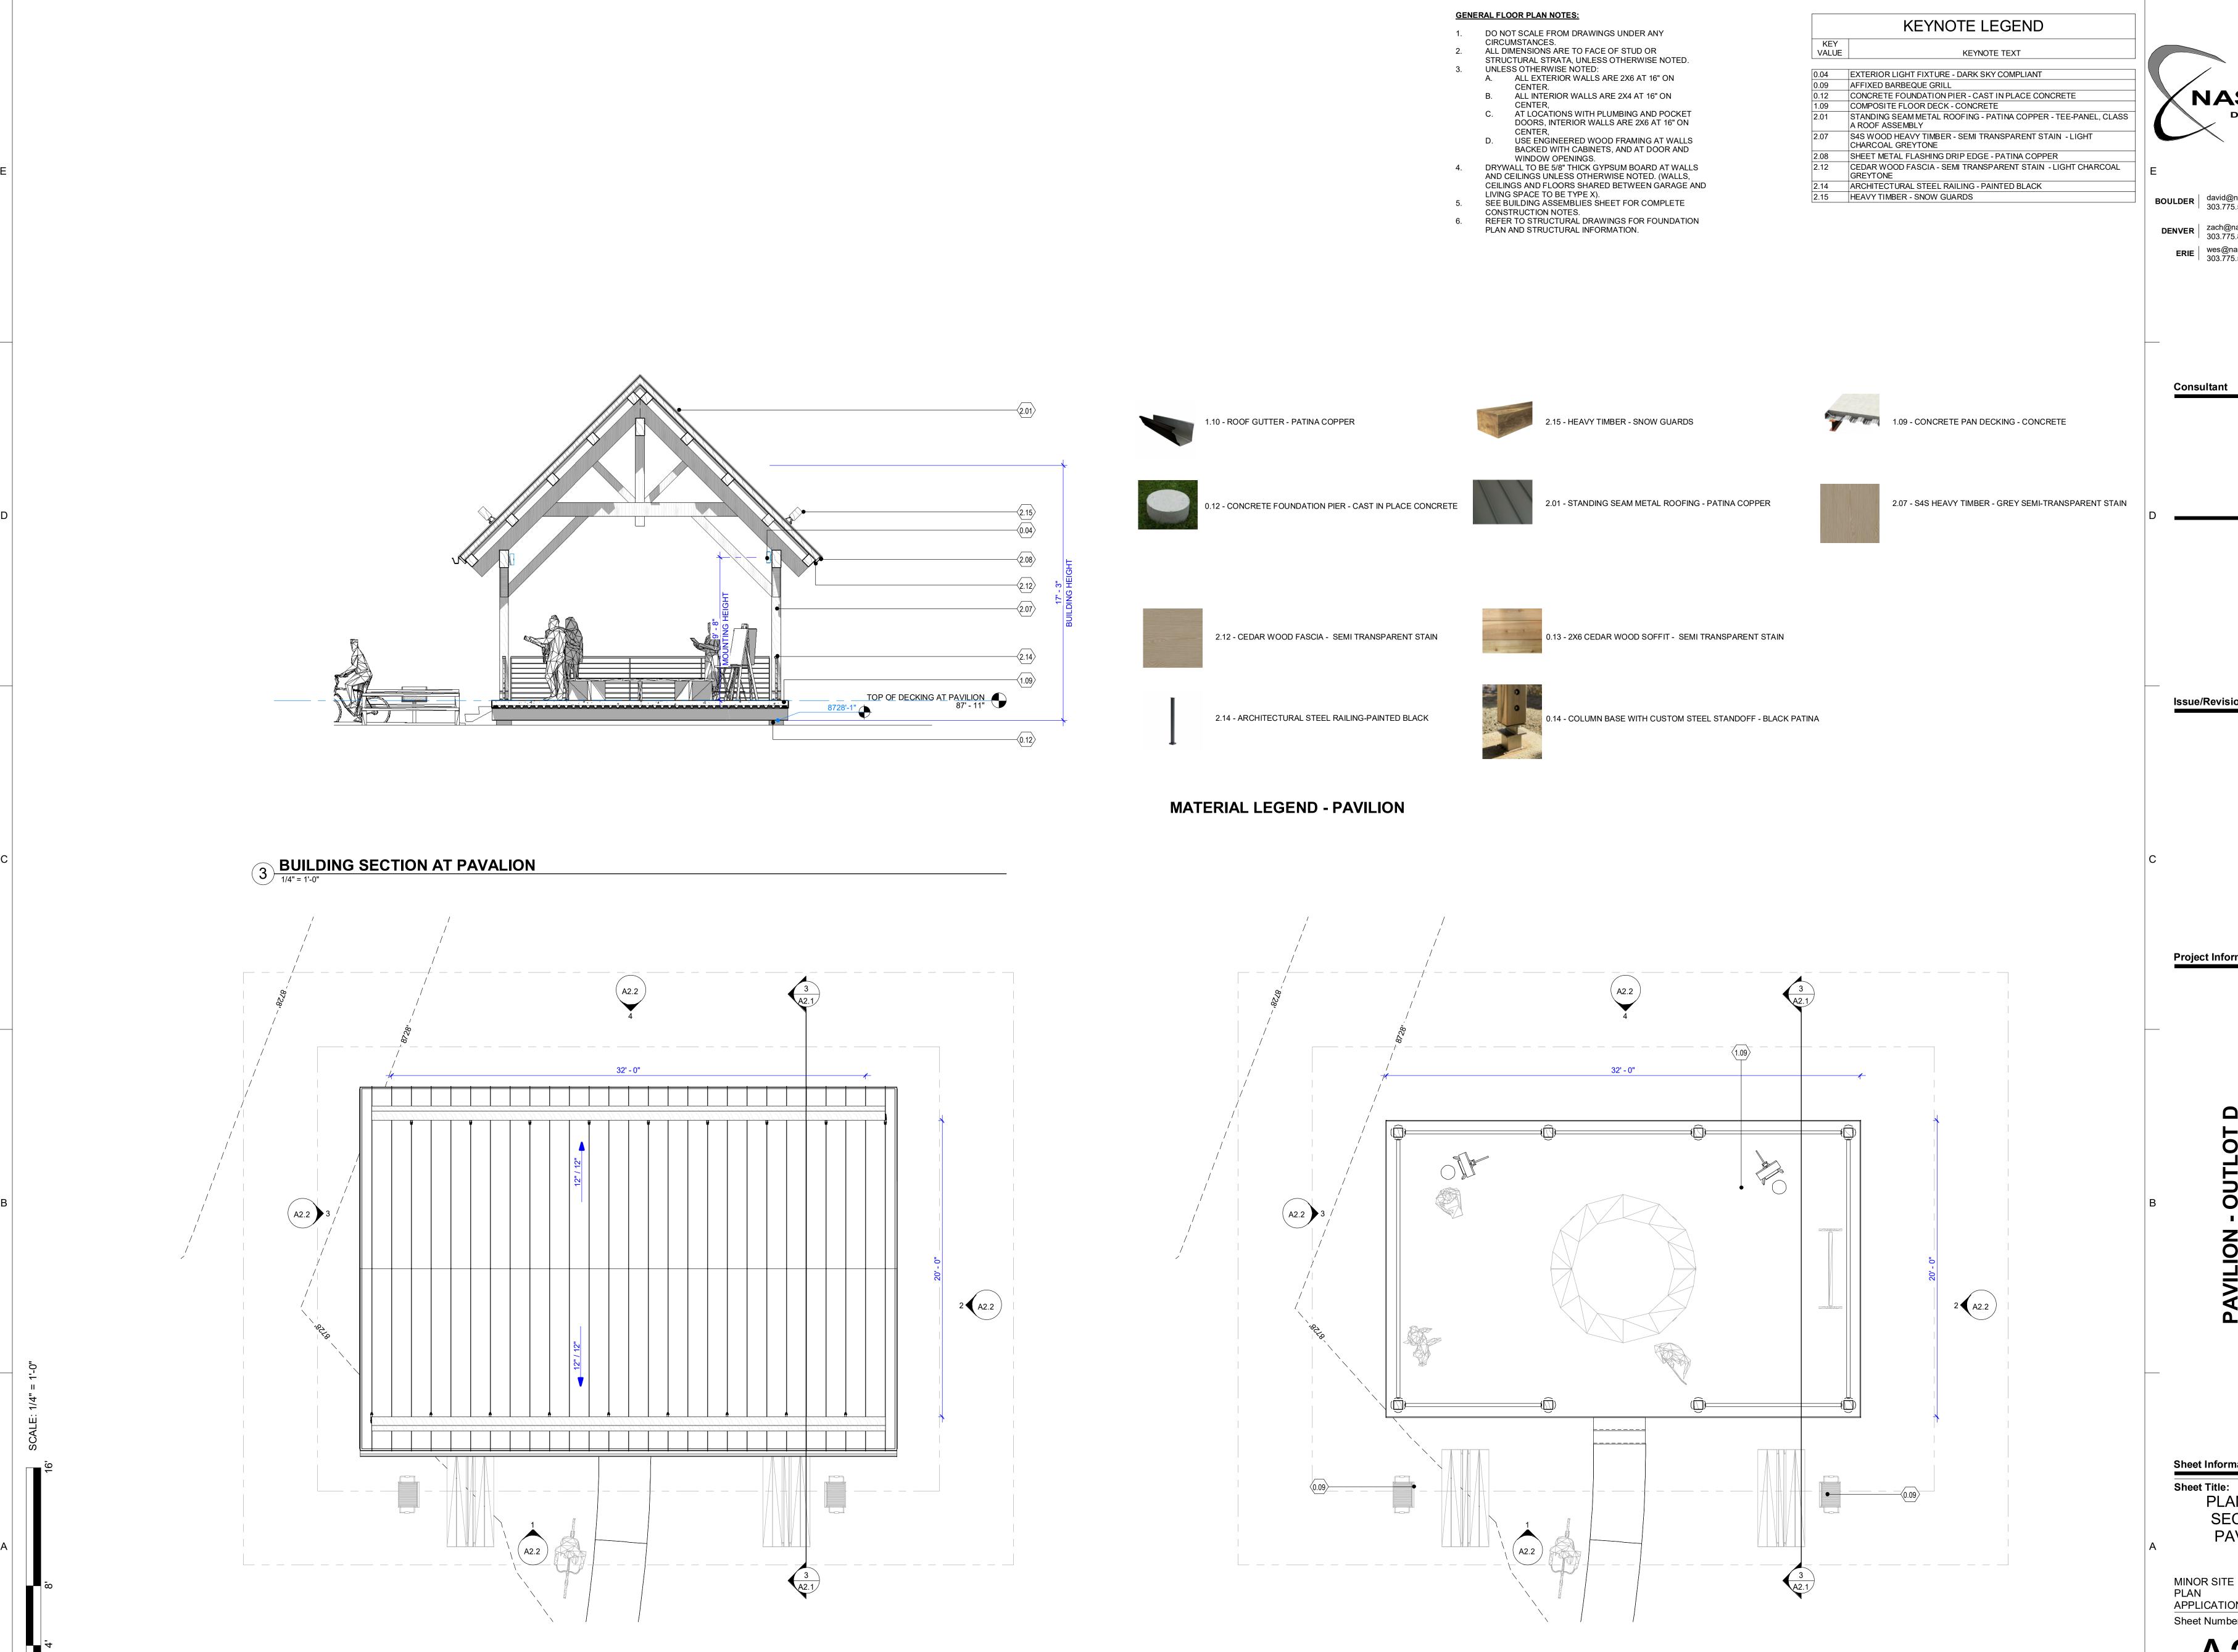

2 ROOF PLAN AT PAVILION

1/4" = 1'-0"

1 FLOOR PLAN AT PAVILION

1/4" = 1'-0"

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ERIE wes@nassardevelopment.com 303.775.5523

Issue/Revisions Date No

**Project Information** 

**Sheet Information** 

PLANS AND SECTION -**PAVILION** 

MINOR SITE PLAN APPLICATION Sheet Number:

Nassar Project:

# **GENERAL ROOF PLAN NOTES:**

 SEE BUILDING SECTIONS FOR TYPICAL ROOF CONSTRUCTION.
 ROOFING CONTRACTOR TO FOLLOW MANUFACTURER'S INSTALLATION SPECIFICATIONS FOR LOW SLOPE ROOFS WHERE APPLICABLE. 3. ROOFING CONTRACTOR TO FOLLOW MANUFACTURER'S FLASHING RECOMMENDATIONS AT ALL EAVES, VALLEYS, ABUTTING WALLS, INTERSECTING WALLS, CHIMNEY VENTS AND STACKS. 4. PROVIDE 5' EXTENSIONS AT ALL DOWNSPOUT LOCATIONS PER CIVIL DRAWINGS, U.N.O., EXCEPT WHERE CONNECTED TO A TIGHTLINE DRAINAGE SYSTEM. 5. LOCATIONS OF ALL TERMINATIONS FOR VENT STACKS, EXHAUST FANS, DRYER VENTS, ETC. MUST BE APPROVED BY ARCHITECT.

6. ALL GUTTERS/DOWNSPOUTS ARE REQUIRED PER SUMMIT COUNTY.

0.13 - 2X6 CEDAR WOOD SOFFIT - SEMI TRANSPARENT STAIN

1.14 - PERFORATED METAL PANEL - HEXAGON

	KEYNOTE LEGEND
KEY VALUE	KEYNOTE TEXT
0.04	EXTERIOR LIGHT FIXTURE - DARK SKY COMPLIANT
0.05	AMPHITHEATER BOULDER SEATING
0.15	FIREPIT
1.16	NATURAL STONE CAP
1.44	BRICK PAVERS
2.01	STANDING SEAM METAL ROOFING - PATINA COPPER - TEE-PANEL, CLASS A ROOF ASSEMBLY
2.04	THIN DEPTH NATURAL STONE VENEER - TELLURIDE GOLD BLEND
2.07	S4S WOOD HEAVY TIMBER - SEMI TRANSPARENT STAIN - LIGHT CHARCOAL GREYTONE
2.15	HEAVY TIMBER - SNOW GUARDS



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1.40 - NATURAL STONE VENEER - LIMESTONE

0.05 - AMPHITHEATER BOULDER SEATING

Consultant

2.12 - CEDAR WOOD FASCIA - SEMI

TRANSPARENT STAIN

1.16 - NATURAL STONE CAP

0.14 - COLUMN BASE WITH CUSTOM STEEL

2.15 - HEAVY TIMBER - SNOW GUARDS

STANDOFF - BLACK PATINA

3 BUILDING SECTION AT AMENITY CENTER

2.04 - THIN DEPTH NATURAL STONE VENEER -

2.07 - S4S HEAVY TIMBER - GREY SEMI-TRANSPARENT STAIN

TELLURIDE GOLD BLEND

1.11 - MC CHANNEL AND TIMBER TRELLIS

2.01 - STANDING SEAM METAL ROOFING - PATINA COPPER

**MATERIAL LEGEND - AMENITY AND GATES** 


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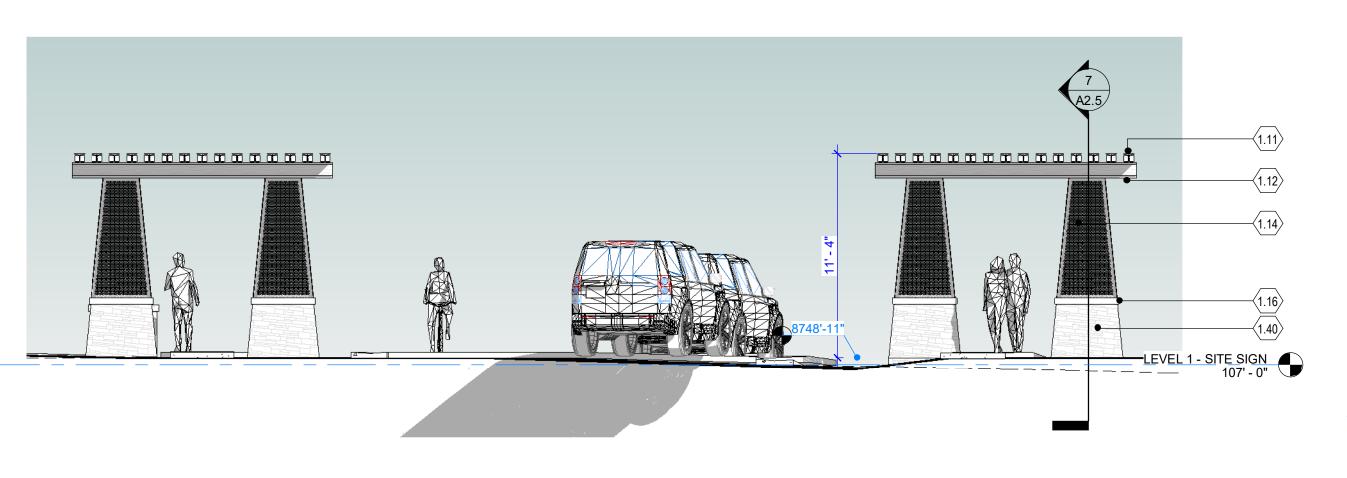
Issue/Revisions Date


**Sheet Information** Sheet Title:
PLANS AND
SECTION AMENITY CENTER

MINOR SITE
PLAN
APPLICATION 2024.08.19 Sheet Number:


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7 SECTION DETAIL AT PEDESTRIAN GATE
1/4" = 1'-0"



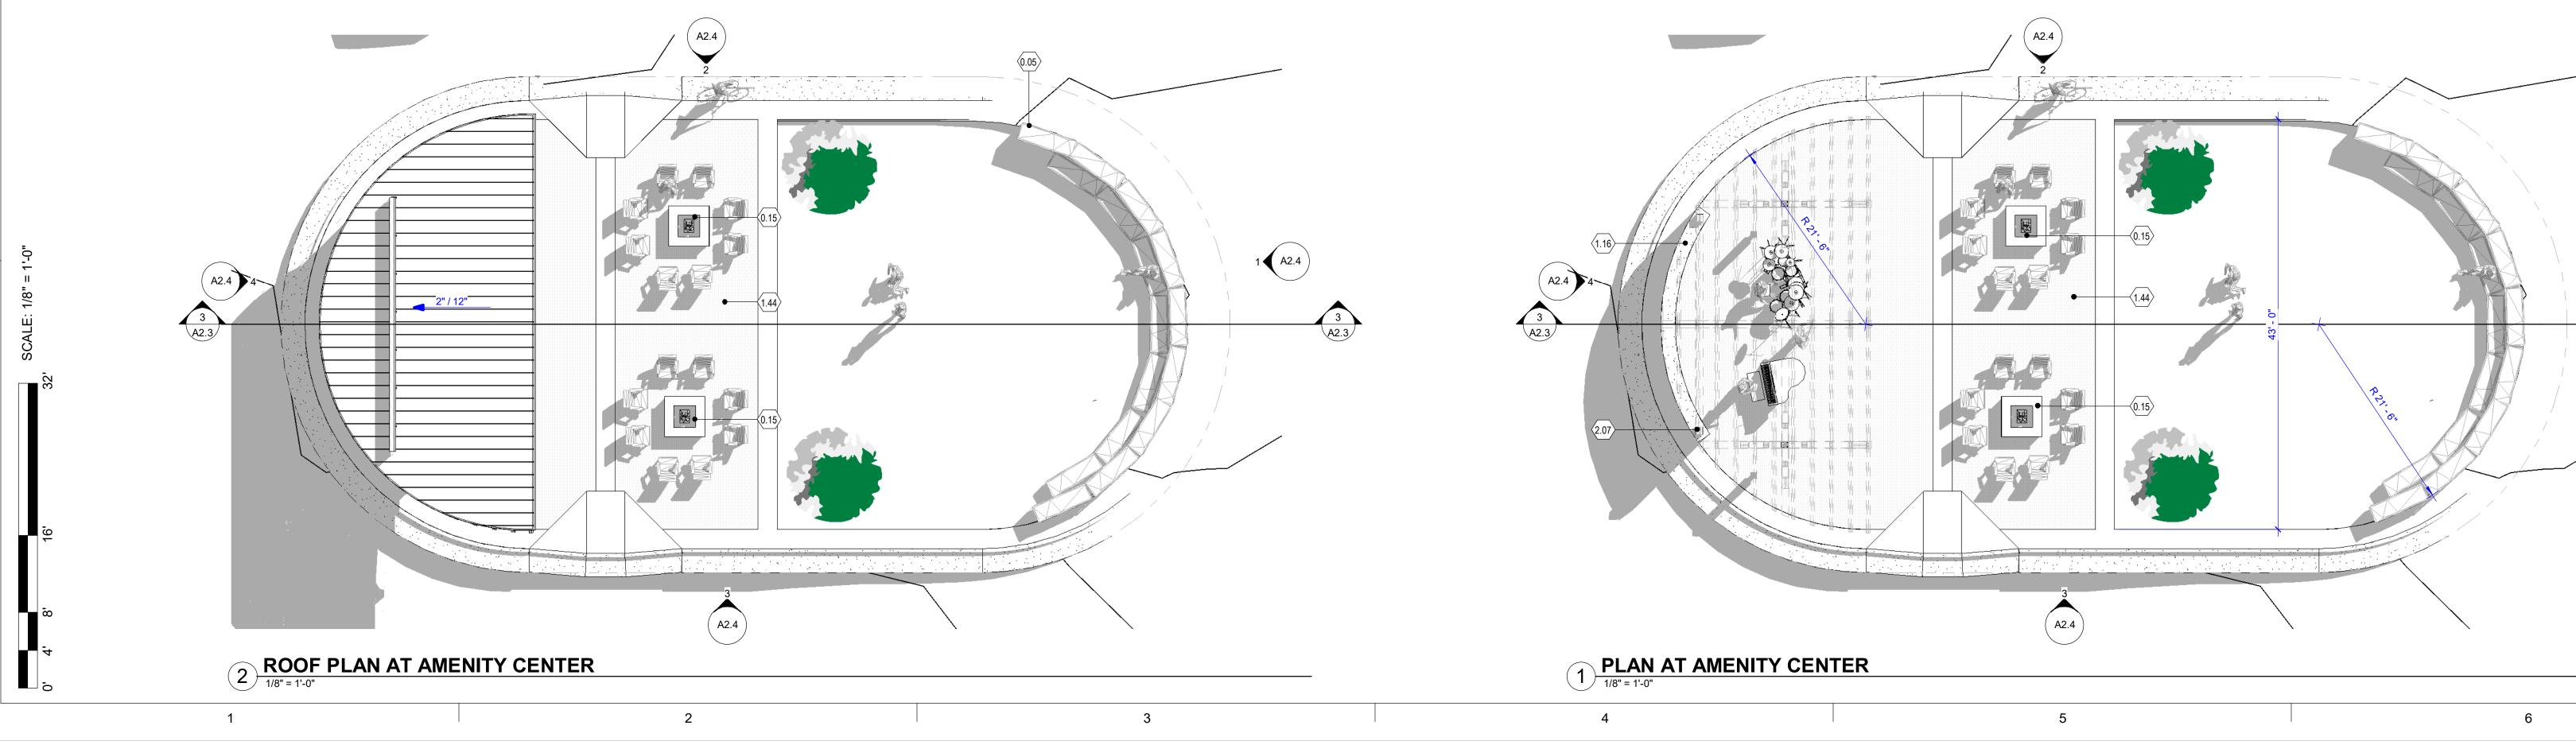
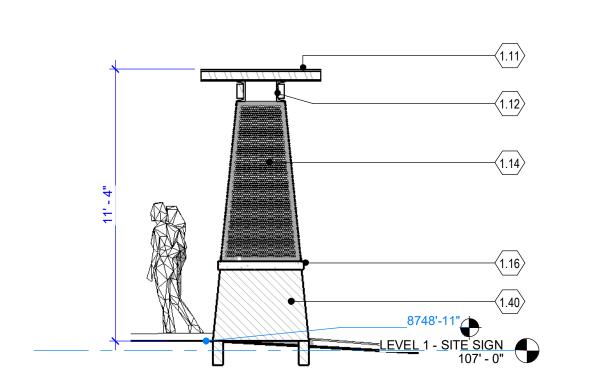
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Issue/Revisions Date

**Project Information** 

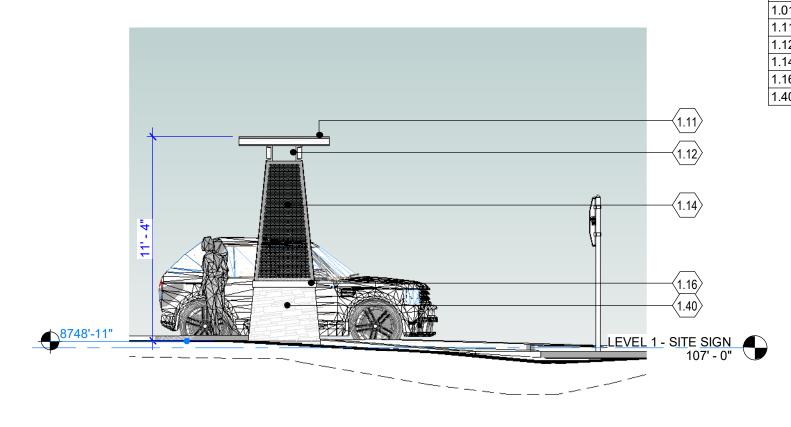
5 SOUTH ELEVATION - PEDESTRIAN GATE


3/16" = 1'-0"

NORTH ELEVATION - PEDESTRIAN GATE


3/16" = 1'-0"

6 WEST ELEVATION - PEDESTRIAN GATE

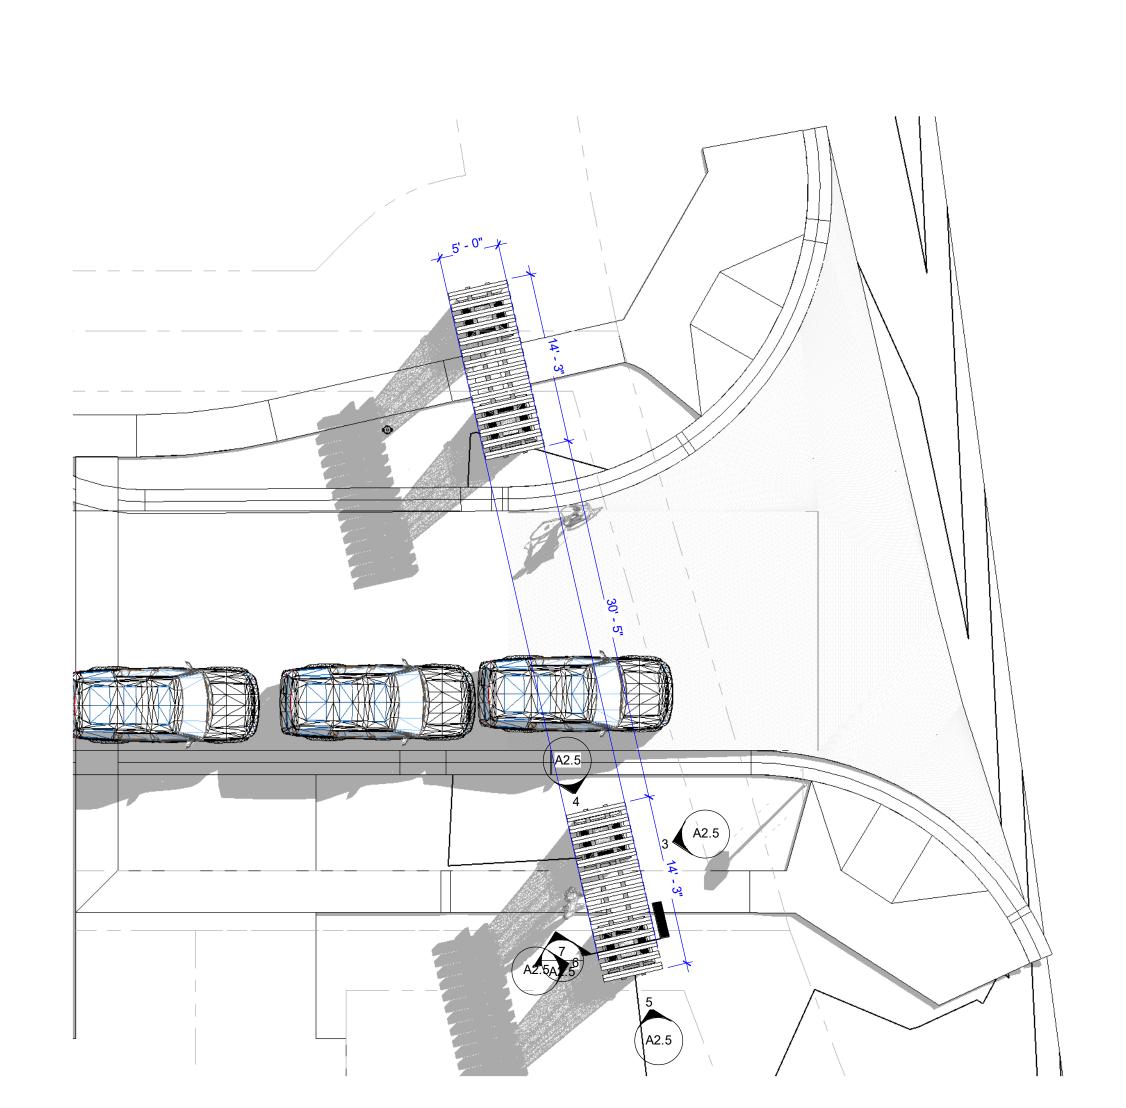

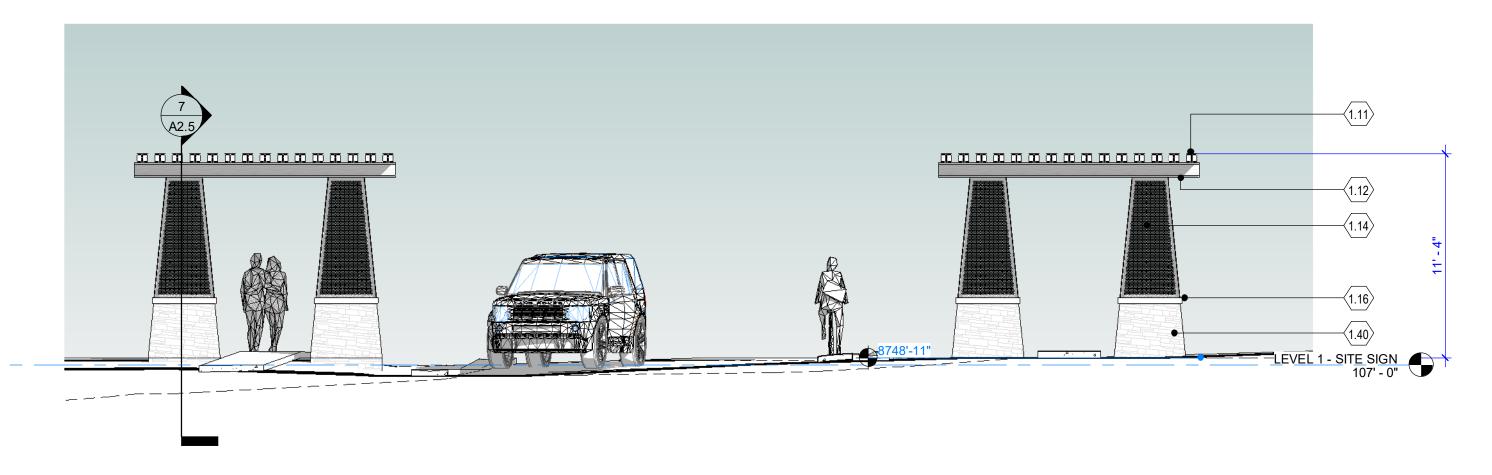

3 EAST ELEVATION - PEDESTRIAN GATE

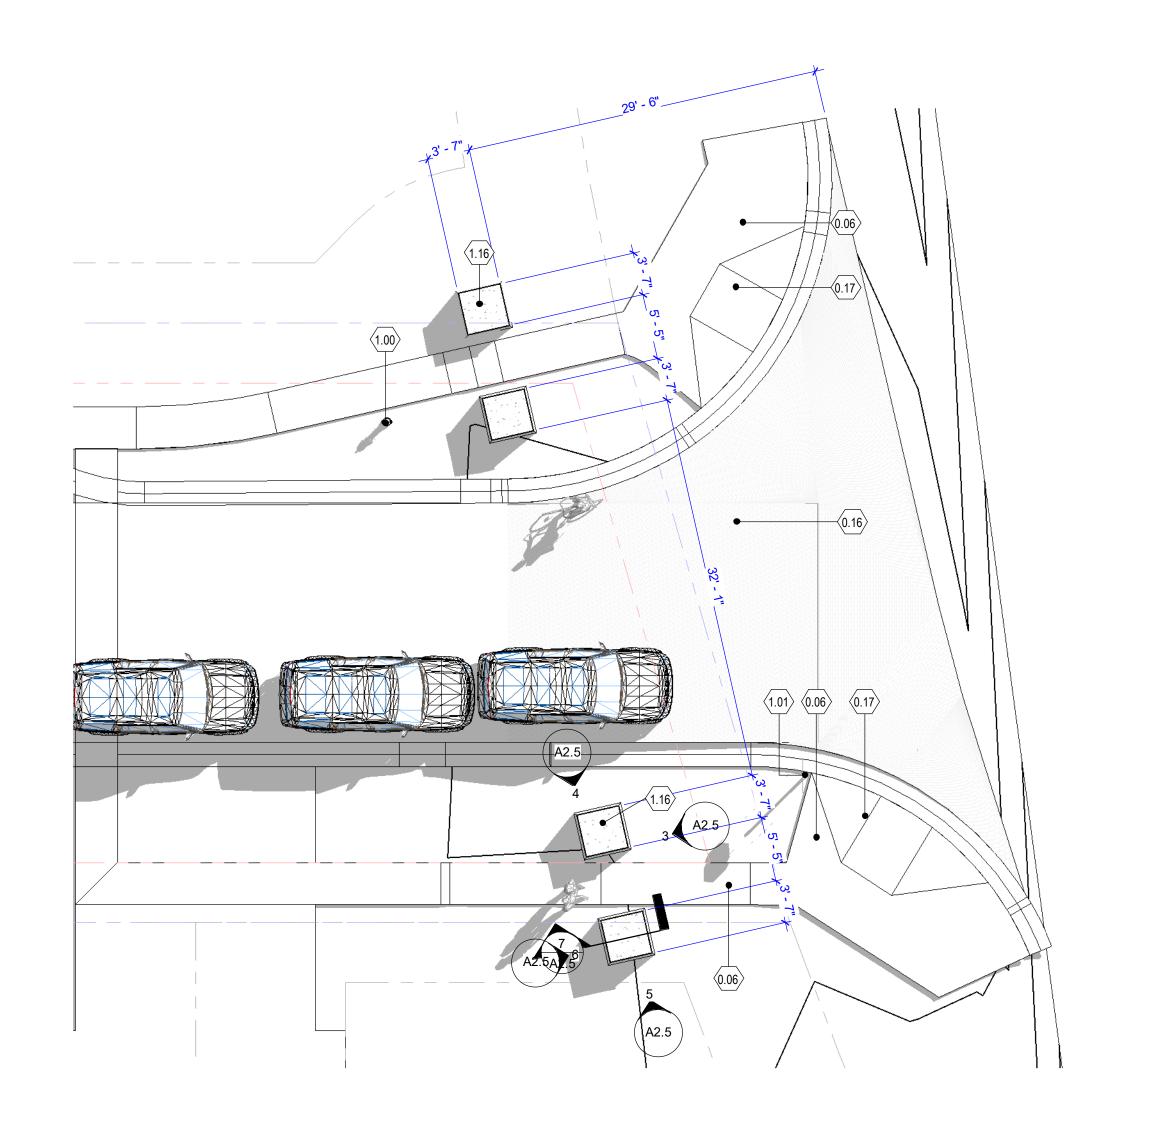

1 PLAN AT PEDESTRIAN GATES
1/8" = 1'-0"





**KEYNOTE LEGEND** 

CONCRETE SIDE WALK ENHANCED PAVING ACCESSIBLE RAMP

W-BEAM AND TIMBER TRELLIS

MC CHANNEL AND TIMBER CROSS BEAMS
PERFORATED METAL PANEL - HEXAGON

NATURAL STONE CAP
NATURAL STONE VENEER - TAPERED BASE

FIRE HYDRANT STOP SIGN

KEY VALUE

KEYNOTE TEXT




2.07 - S4S HEAVY TIMBER - GREY SEMI-TRANSPARENT STAIN


2.04 - STONE VENEER - LIMESTONE BLEND

10	2.12 - CEDAR WOOD FASCIA - SEMI TRANSPARENT STAIN

1.16 - NATURAL STONE CAP

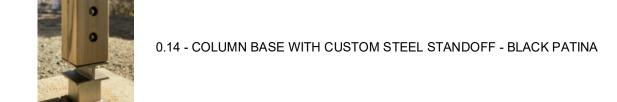



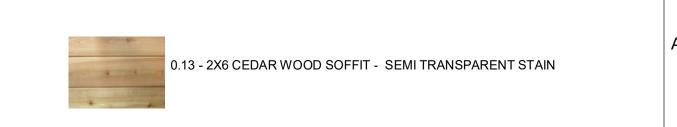

1.1	4 - PERFORATED METAL PANEL - HEXAGON	

**MATERIAL LEGEND - AMENITY AND GATES** 

Sheet Number:

MINOR SITE PLAN

**Sheet Information** 


PLANS ELEVATIONS AND DETAIL AT ENTRY GATE

APPLICATION 2024.08.19

Nassar Project: 2024.037

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2 TRELLIS PLAN AT PEDESTRIAN GATES

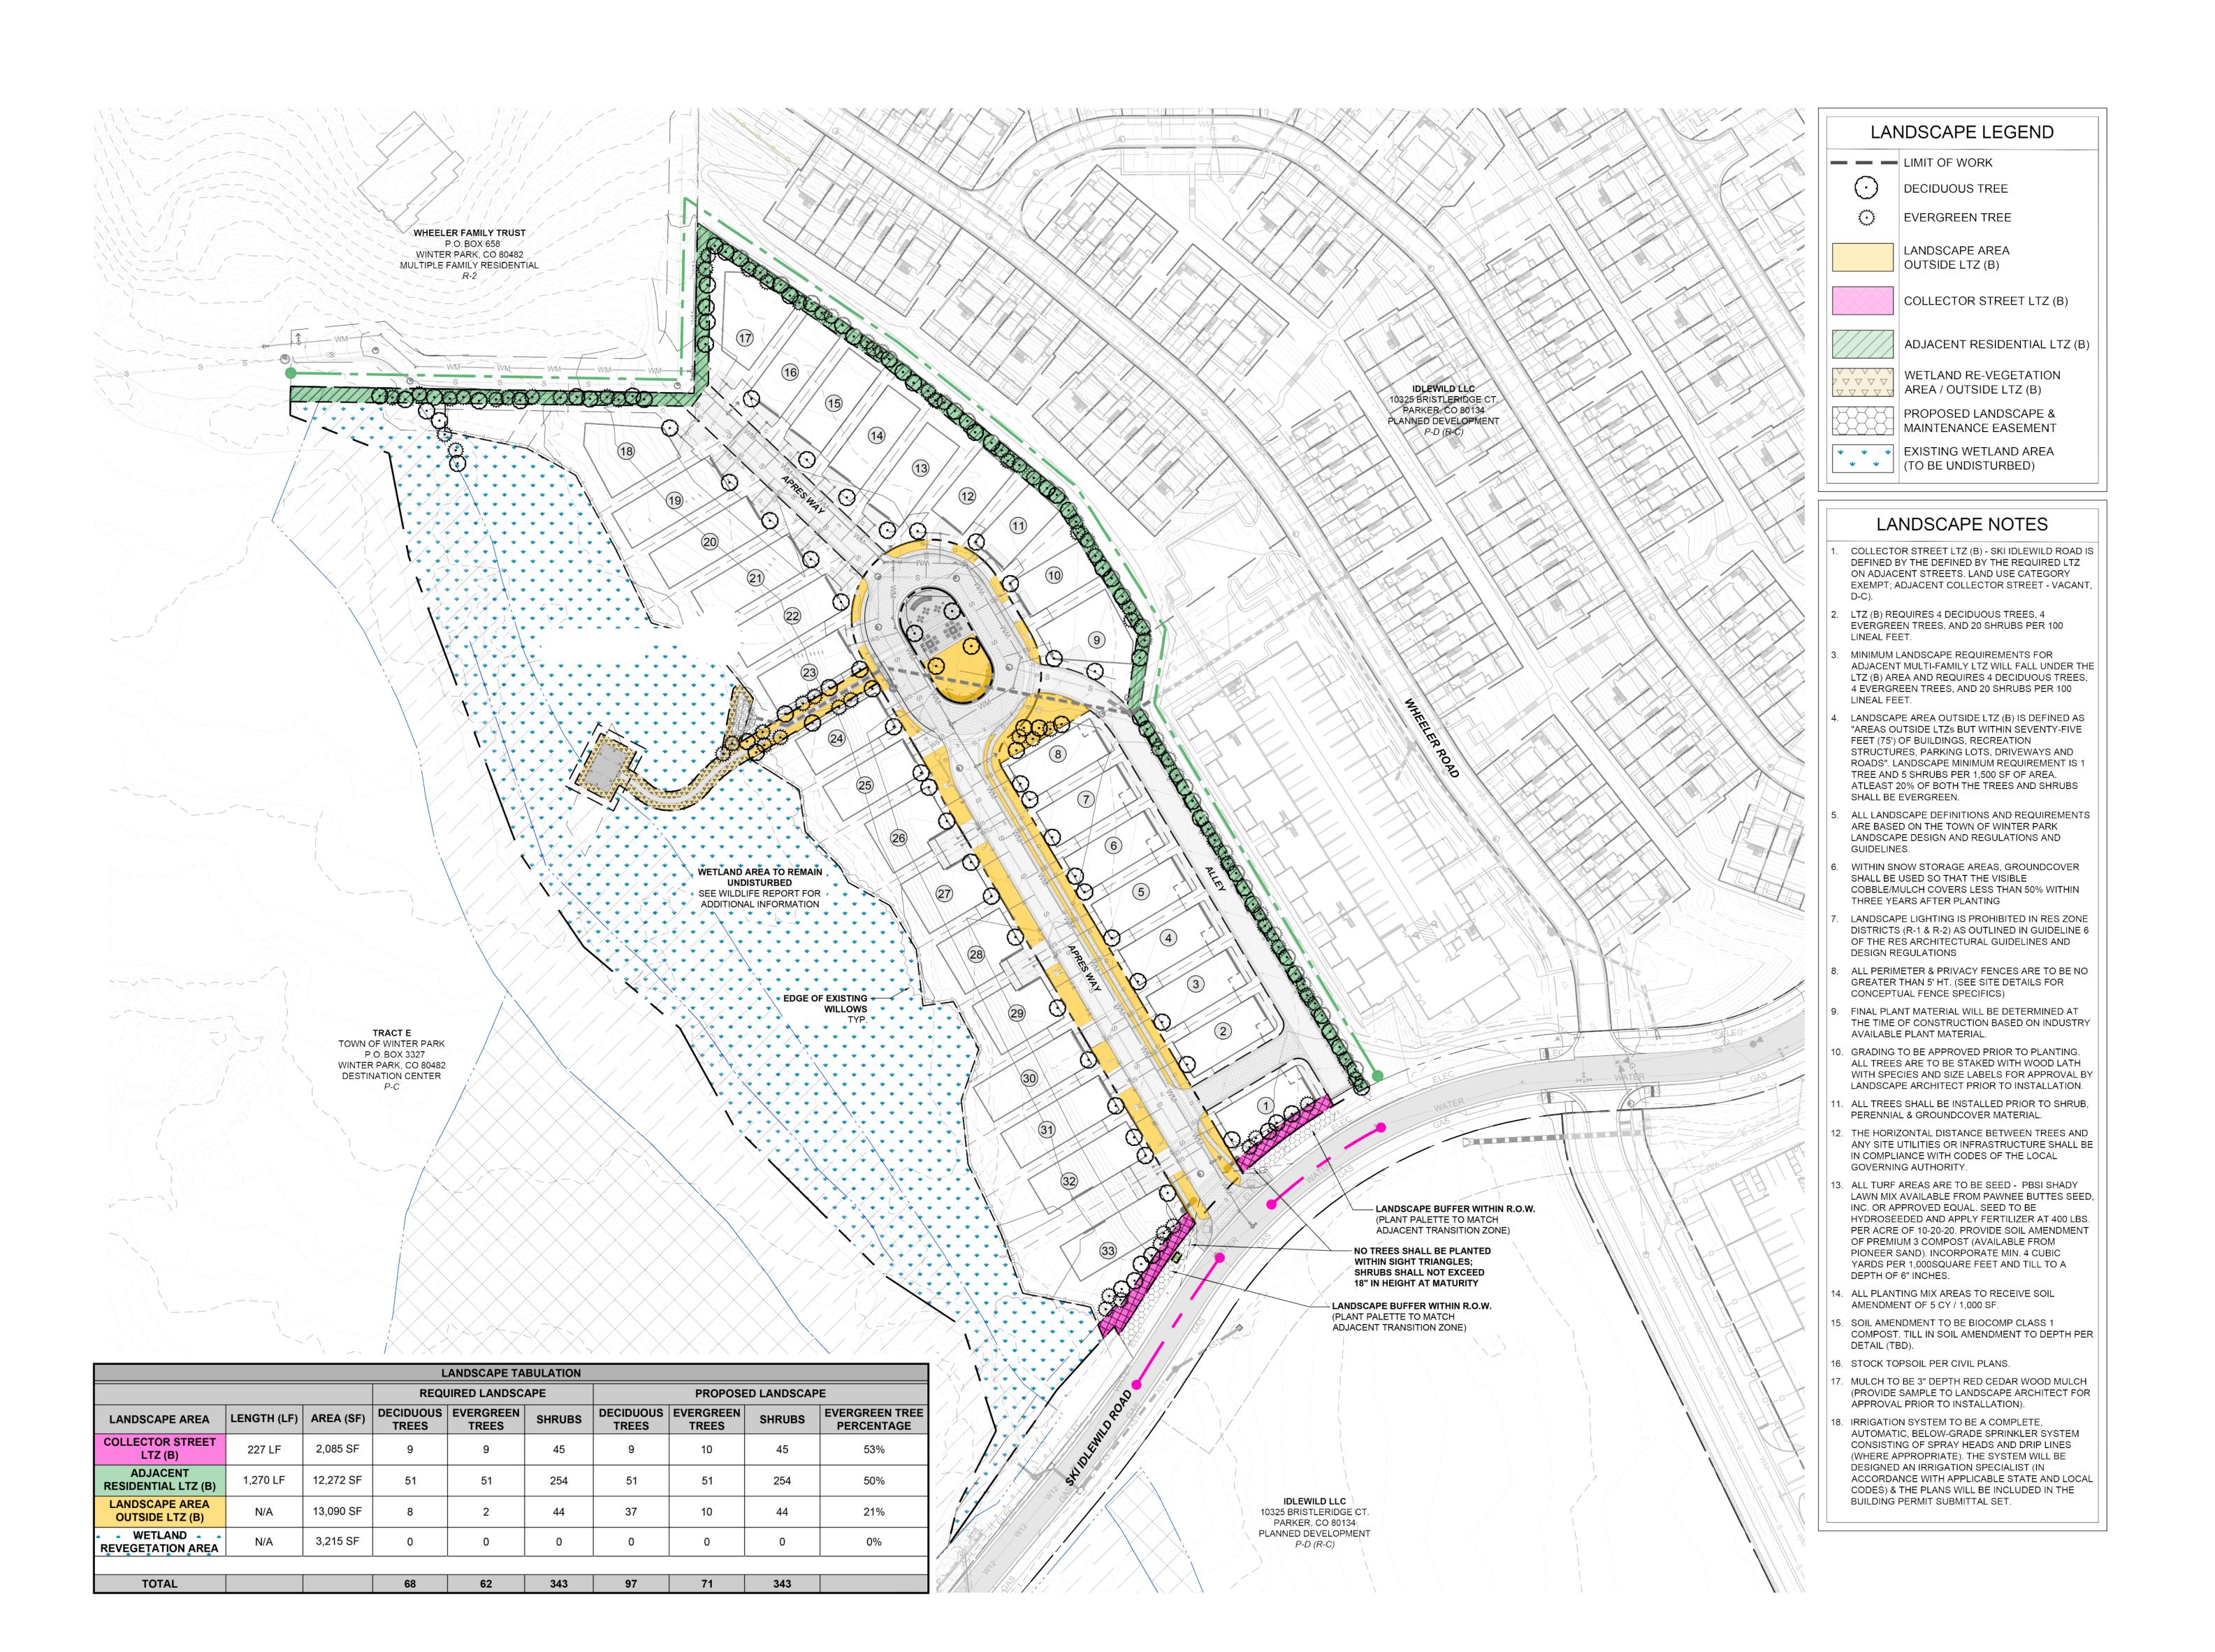

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Consultant

Issue/Revisions Date N

Project Information

ON - OUTLOT D
APRES WAY
R PARK, COLORADO

Sheet Information

LANDSCAPE PLAN


MINOR SITE
PLAN
APPLICATION 2024.08.19
Sheet Number:

1 LANDSCAPE PLAN

1" = 20'-0"

Snee

Nassar Project: 202

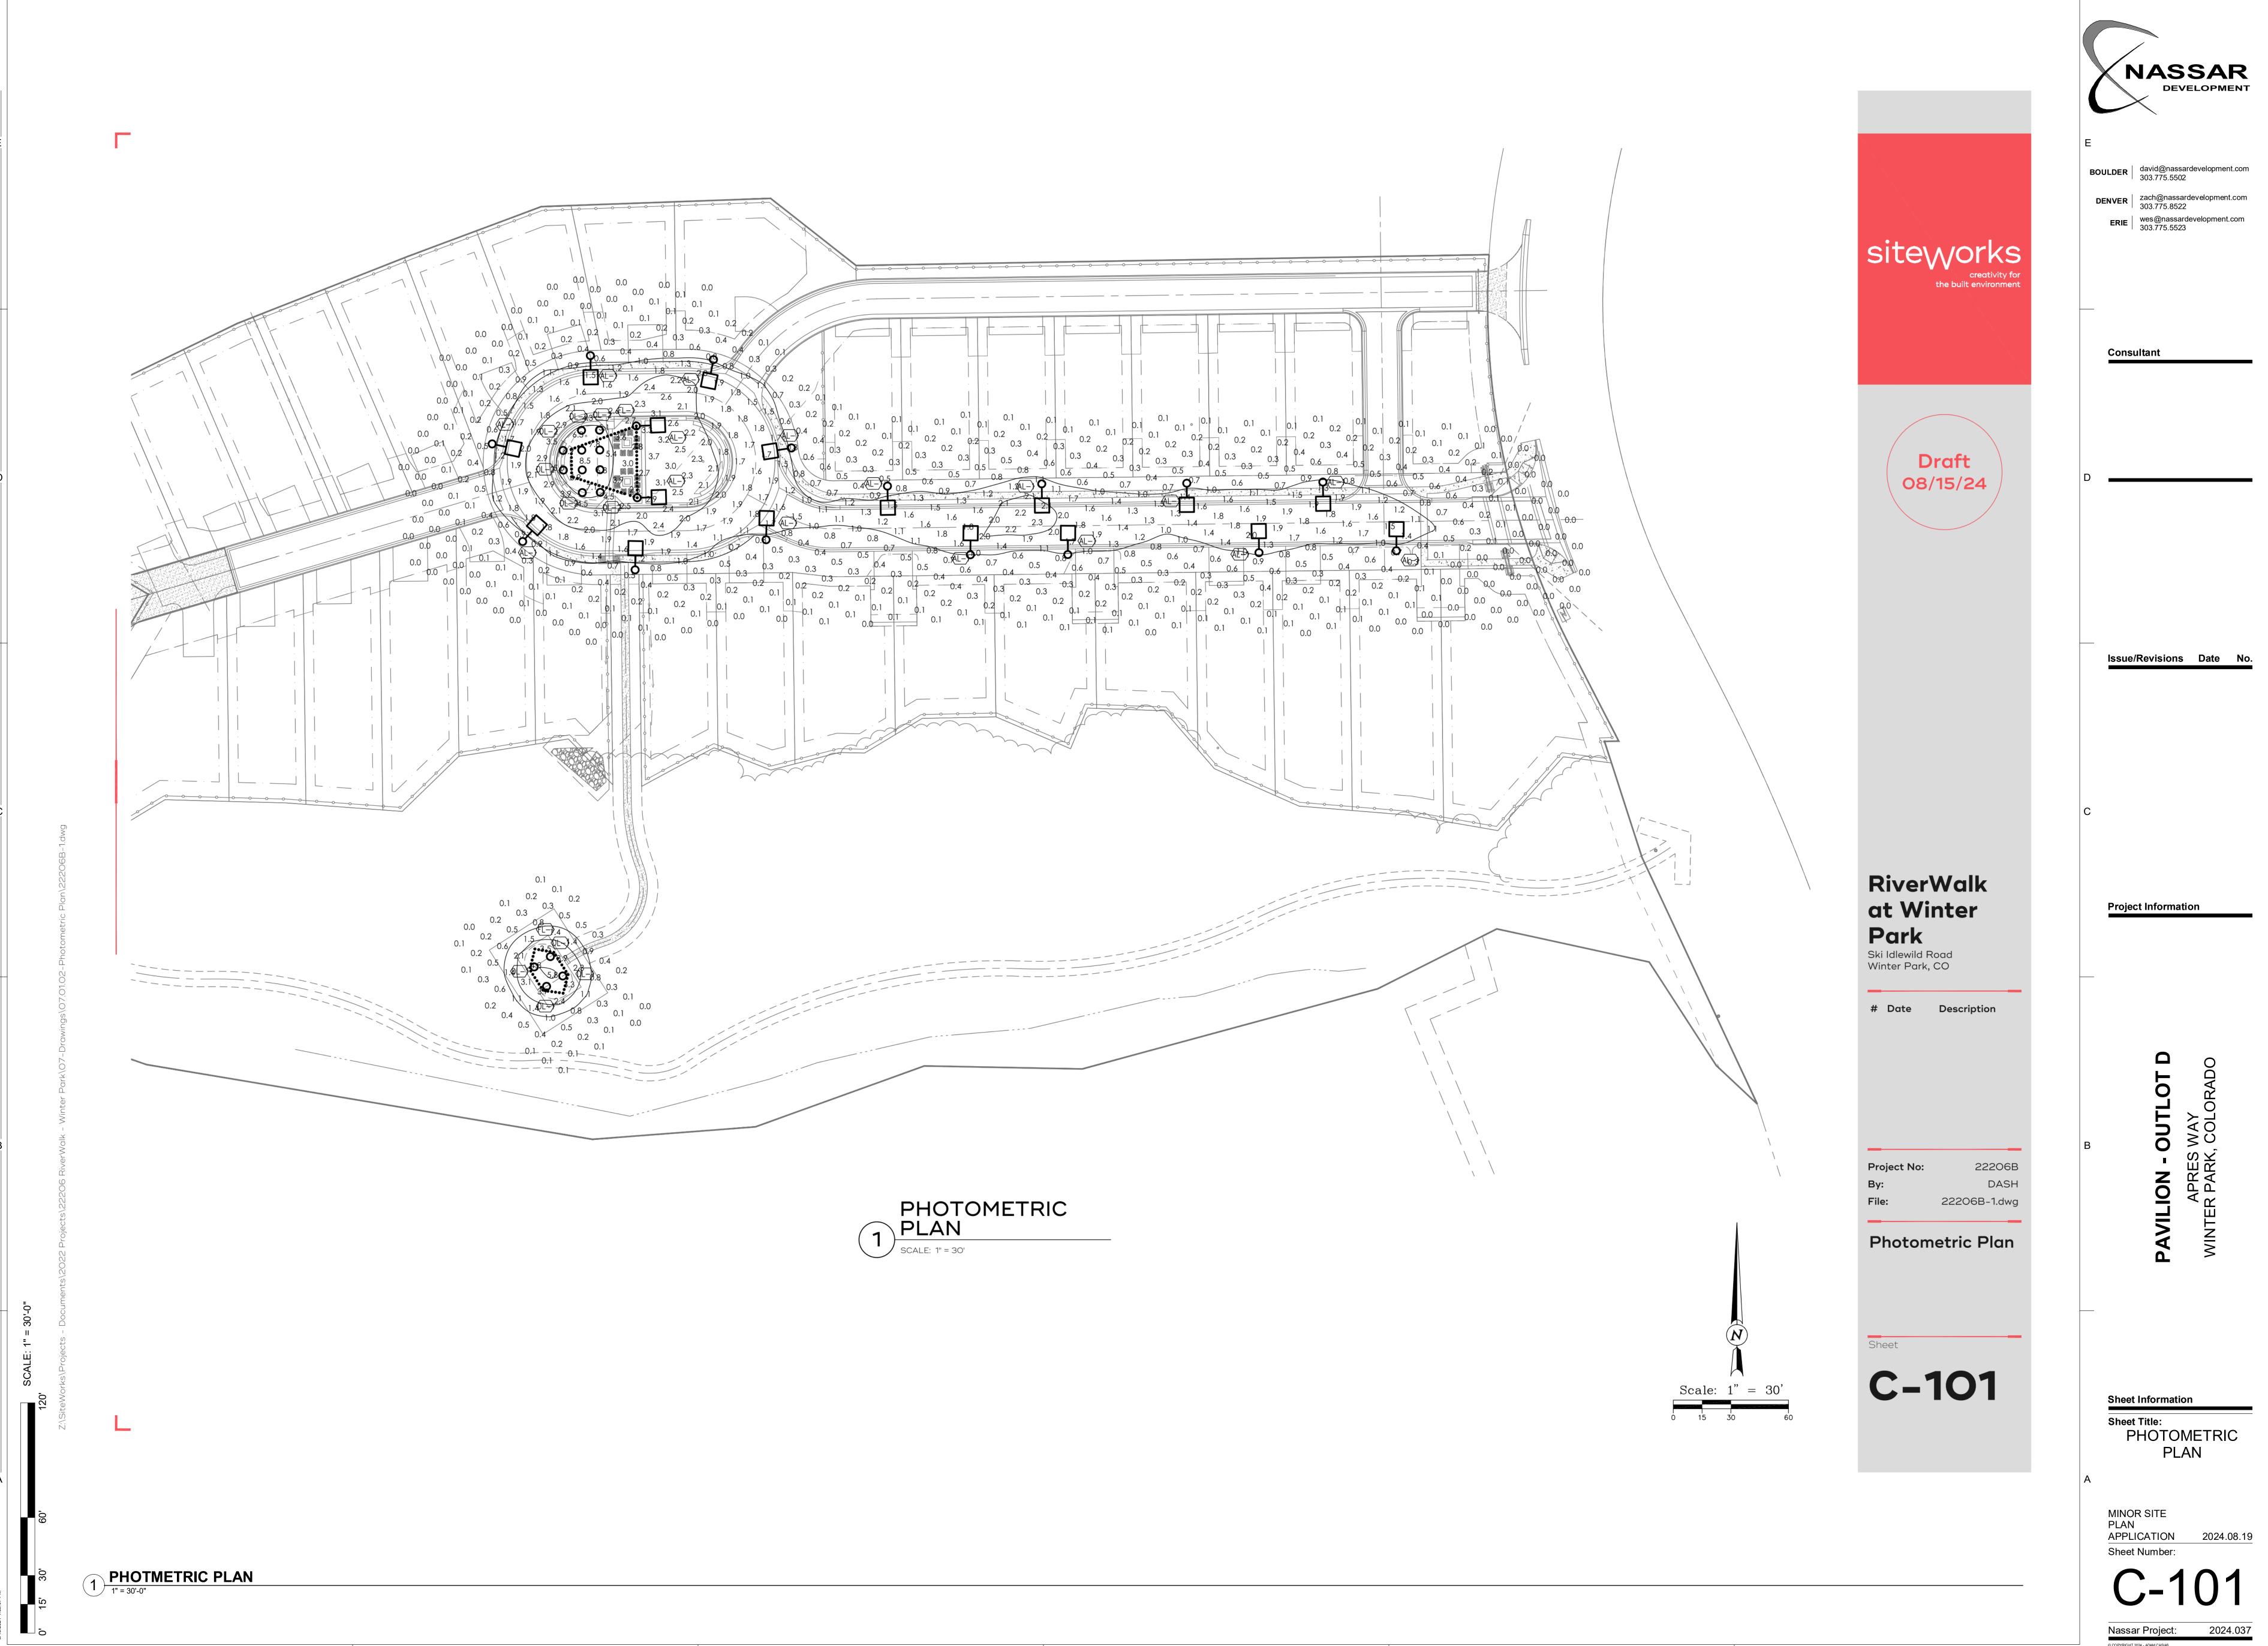



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**Sheet Information** 


MINOR SITE
PLAN
APPLICATION 2024.08.19
Sheet Number:

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LUMINAIRE SCHEDULE									
CALLOUT	SYMBOL	DESCRIPTION	MODEL	VOLTS	MOUNTING	HEIGHT	ARM LENGTH	QUANTITY	NOTE 1
AL-1	<b>←</b> □	AREA LIGHT	BEACON, URBAN SERIES URB-CAP-26-18L-25-3K7-4W	120V 1P 2W	POLE	17'	5'	17	IDA DARK SKY COMPLIANT. 17' CUSTOM STEEL POLE
DL-1	0	6" ROUND CEILING MOUNT CYLINDER. RIDGID PENDANT MOUNT.	SPECTRUM LIGHTING, 6" ROUND DIRECT, CEILING MOUNT, CW606TD-10L-30K-EX-SO-MW	120V 1P 2W	CEILING	15'	0'	4	IDA DARK SKY COMPLIANT. WILDLIFE FRIENDLY. RIDGID PENDANT MOUNT.
DL-2	0	4" ROUND DEEP RECESSED DOWNLIGHT	SPECTRUM LIGHTING, 4" ROUND DEEP DOWNLIGHT, SR4MOTD-10LE1-RDD4x-30K-MWxGL	120V 1P 2W	CEILING	15'	0'	10	IDA DARK SKY COMPLIANT. WILDLIFE FRIENDLY
FL-1	•	FESTOON LIGHT	ALUZ, A5-ZOZO-BLL-27K-GSFL-3W	120V 1P 2W	CEILING	15'	0'	97	IDA DARK SKY COMPLIANT. 24" O.C. SPACING

GENERAL PHO SCHEDULE	TOMETRIC
AVERAGE FOOT-CANDLES	0.79
MAXIMUM FOOT-CANDLES	8.5
MINIMUM FOOT-CANDLES	0.0
MINIMUM TO MAXIMUM FC RATIO	0.00
MAXIMUM TO MINIMUM FC RATIO	8.45 / 0.00
AVERAGE TO MINIMUM FC RATIO	0.79 / 0.00



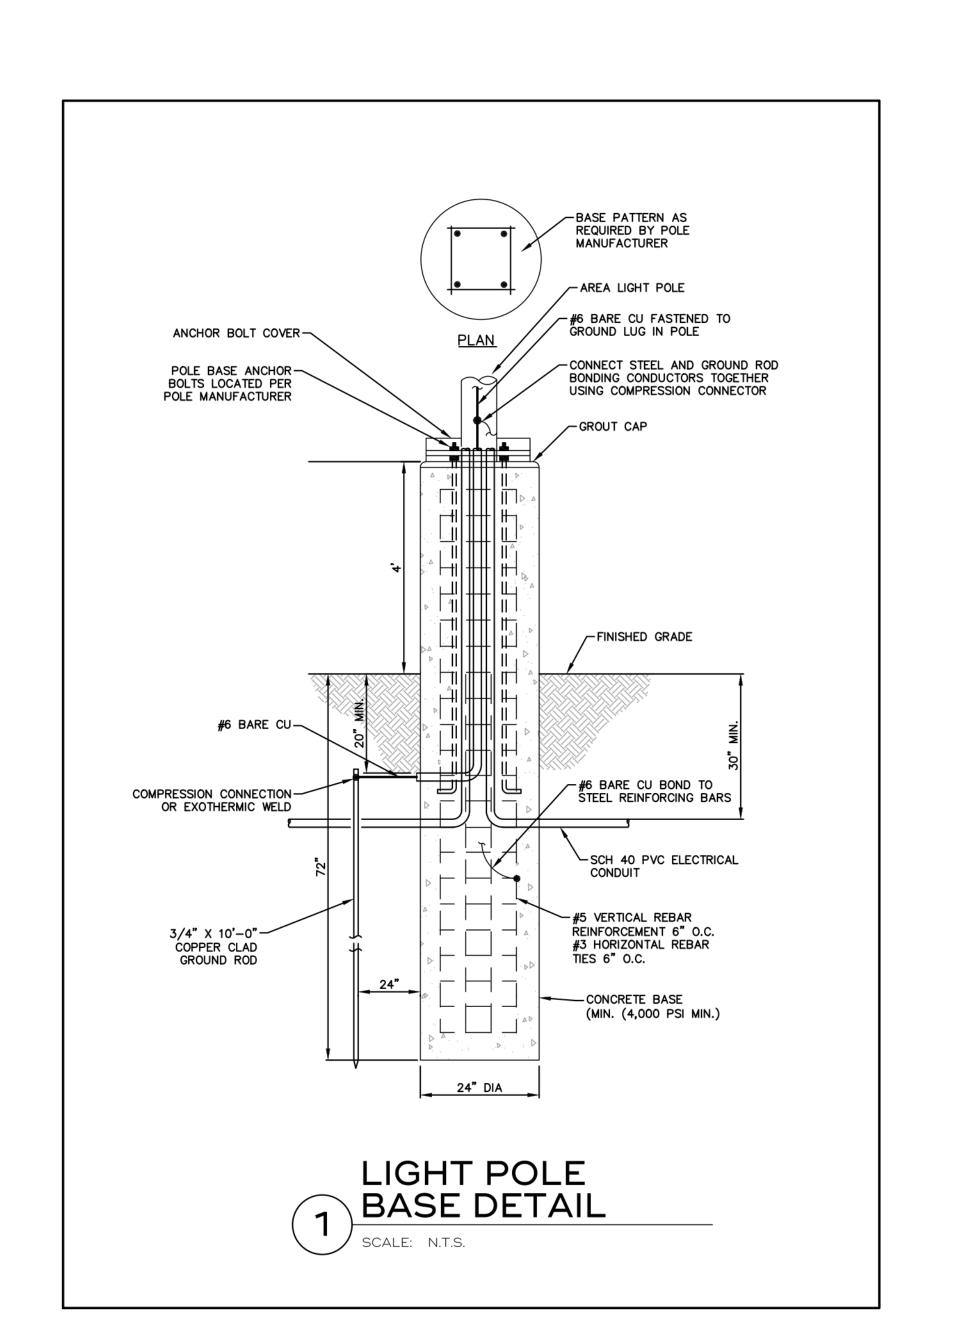

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Consultant

Draft 08/15/24

Issue/Revisions Date No

Project Information

Park
Ski Idlewild Road
Winter Park, CO

RiverWalk

at Winter

# Date Description

oject No: 22206B v: DASH le: 22206B-1.dwg

Lighting Details

C-201

Sheet Information

Sheet Title: LIGHTING DETAILS

MINOR SITE
PLAN
APPLICATION 2024.08.19
Sheet Number:


C-201

Nassar Project: 2024.037

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1 LIGHTING DETAILS

Not To Scale



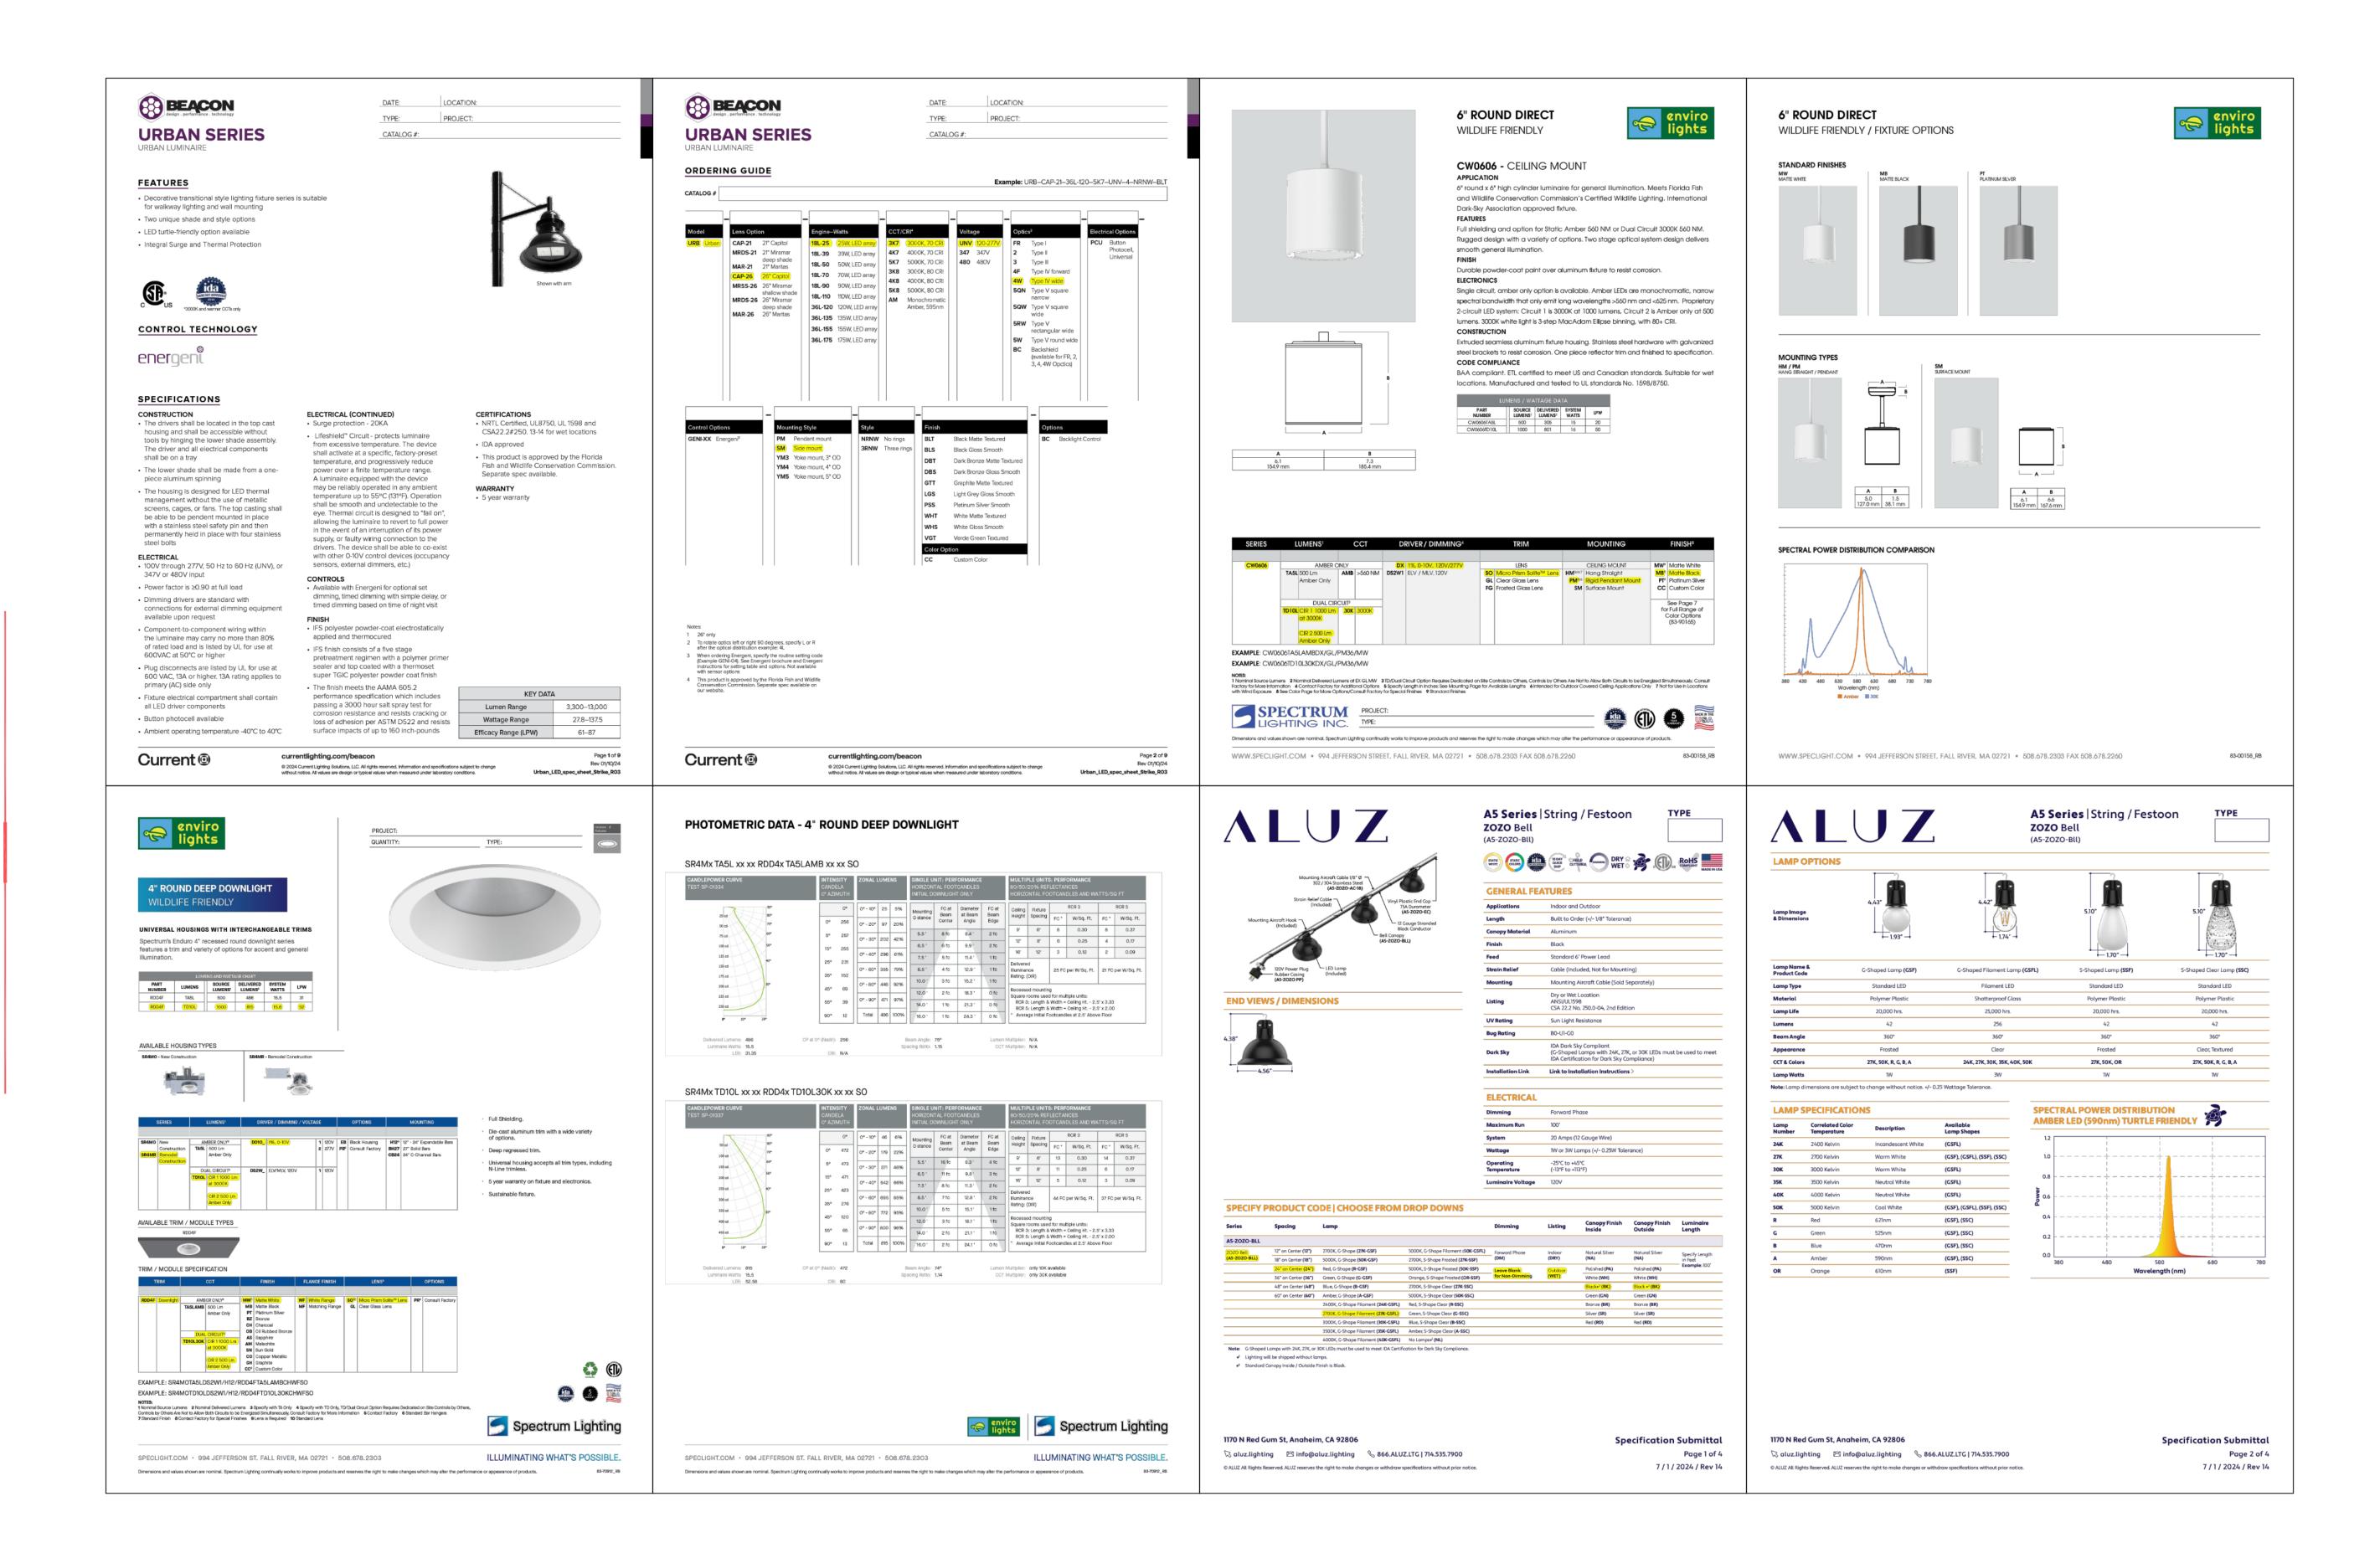

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Consultant

Draft 08/15/24

RiverWalk

at Winter

# Date Description

**Lighting Details** 

C-202

22206B

22206B-1.dwg

DASH

Park

Ski Idlewild Road

Winter Park, CO

the built environment

Issue/Revisions Date No

**Project Information** 

**DETAILS** 

**Sheet Information** LIGHTING

MINOR SITE PLAN APPLICATION 2024.08.19 Sheet Number:

Nassar Project:
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TO Planning Commission

FROM Shelia Booth, AICP, CPS Contracted Planner

THROUGH James Shockey, AICP, Community Development Director

DATE September 10, 2024

PUBLIC HEARING: Major Site Plan (MSP) – 1097 Winter Park Drive

(PLN23-098)

Property Owner: LXXTWO, LLC

Applicant: Devin Visciano, White Development, LLC

Architect: Adam Harding, AIA, Roth Sheppard Architect, LLC

**Location:** 1097 Winter Park Drive

<u>Legal Description:</u> Lot A, Block 3, Winter Park Village, Town of Winter Park, County of Grand, State of Colorado.

Zoning: Limited Commercial, C-1

#### **Authority:**

Pursuant to § 5-B-3 of the Winter Park Unified Development Code (the "UDC"), the Planning Commission shall review and recommend or approve applications as shown in Table 5-B-3, Development Review Procedures Summary Table.

#### Major Site Plan Procedure & Approval Criteria:

UDC § 5-E-1 G. 2. e.: *Planning Commission Action*. After agency and DRC comments have been resolved and proper public notice posted, the Planning Commission shall:

- 1. By majority vote, approve, approve with conditions, or deny the site plan as outlined in Sec 5-A-3(C), *Procedures*.
- 2. Hold a public hearing prior to taking action on the proposed site plan; and
- 3. Receive a written recommendation from the Director regarding the proposed site plan.

UDC § 5-E-1(H). Approval Criteria. The site plan shall be evaluated and may be approved in accordance with the following criteria:

- 1. Comprehensive Plan. Conformance with the Comprehensive Plan;
- 2. This UDC. Conformance with the standards of this UDC; and
- 3. Design Guidelines. Conformance with the Design Guidelines in Appendix A.

This report includes comments from Town staff that should be considered as a part of the application decision.

#### § 5-B-8 Public Notice Requirements:

This application has had proper public notification pursuant to § 5-B-8 of the UDC. A Newspaper Publication (PUB) was published in the Middle Park Times on August 30, 2024, providing notification



of the hearing and requesting comments. A Surrounding Property Owners Mailing (ML) was sent to property owners within 300' of the property on August 27, 2024. A Property Posting (PO) was posted on August 27, 2024.

As of September 5, 2024, staff has received one letter expressing specific concerns with the development. A copy of the letter is included in the packet.

#### **Project Overview:**

The proposed project is a three-story "Mixed Use" building and land use which comprises a combination of (2) main level commercial spaces (1,362 SF Retail and 1,419 SF Restaurant w/ 1,000 SF Outdoor Patio), and (9) multifamily apartment units above within the second and third floors, marketed as for-sale condominium units. One commercial space will be built out for a restaurant ready tenant, and the other space will be for retail, (the Alpine Sun Ski Shop has committed to relocating back as the original business on this site, upon final construction).

The condominium units within the singular building are further defined as: six (6) split level 2 bed/2.25 bath with end units being 1,304 SF and 1,468 SF, and interior units being 1,288 SF. Additionally, there are three (3) single level 1 bed/1 bath units being 628 SF and 680 SF which will be added to the town's long-term workforce housing program. On-site residential amenities will include secured bike and ski storage lockers at the main level lobby and a 3rd-floor common recreation area with pool table, fireplace, and lounge seating.

As the residential units are anticipated to be for-sale condominiums, a condition of this Site Plan approval will be for the following future application steps:

- Applicant shall submit for administrative review and approval a Condominium Plat (per the UDC § 5-D-2(D) and 5-D-9) once construction is complete and prior to the transfer or sale of property to establish airspace rights of ownership per unit and define maintenance obligations and fees for condominium common elements, infrastructure and landscaping.
- Applicant shall submit a Homeowners' Association (HOA) Declaration of Covenants for administrative review defining maintenance obligations and fees for condominium common elements, infrastructure, and landscaping.

The mixed-use building is located within the Old Town area of Winter Park and will have a half mile/8-10-minute walk to the Winter Park Ski Area Base and Winter Park Express Amtrack Station, and will be adjacent to residential, lodging and commercial uses along Winter Park Drive. Many of the project's services, amenities and residential density support the guiding principles and strategies outlined in the town's 2019 Imagine Winter Park Town Plan.

#### Variances:

The Board of Adjustment (BOA) at their July 9, 2024, meeting held a public hearing and considered and granted a parking variance (PLN24-051), as presented by the applicant. The variance justifications were based on site condition hardships which affect the "residential" mixed-use nature of the project and prevent direct compliance to the UDC Table 3-H-3-1 and Table 3-H-3-2 for residential and non-residential parking requirements. The project's "non-residential/commercial" mixed-use parking will comply with the UDC and are marked as on-street parallel parking. Thus, the BOA approved the variance reducing the off-street multifamily parking requirement from 13 spaces to 9 spaces, which is reflected in the project's (PLN23-098) Site Plan/ Sheet AS.01 Parking Calculations chart. The BOA stated the following condition of approval,



"The Declaration of Covenants and as-built shall include language indicating only one parking space is provided per unit and on-street overnight parking is not permitted for residential use."

CPS planning and town planning have worked with the applicant during the project's development review to approve an administrative variance, per UDC 3-I-2-C-3 for deficiencies of perimeter landscape bufferyard plantings based on available planting area. The site's geometry, which is bounded by ROW and access drives on three sides, in addition to the proposed 8ft wide Fraser River Trail parallel to Winter Park Drive, limits adequate planting width for required Type A bufferyard trees and shrubs. The Site Plan/ Sheet A9.00 and the Landscape Plan indicate how ornamental grasses and perennial flowers will be used within the thin planting area framed by the trail sidewalk and retail sidewalk, in addition to planter boxes located against the building's main linear walls to activate the street-side public realm. The Landscape Plan is approved to use a Modified Type A bufferyard/plantings along Winter Park Drive and a Modified Type B bufferyard/plantings along the other 3 property sides.

#### Density:

N/A. Satisfactory. Per Table 3-A-5 Nonresidential and Mixed-Use Building Standards, there is no max density requirement established.

#### Construction Plans: (View Construction Plans here.)

Not Satisfactory. The applicant resubmitted the Construction Plans with the 2<sup>nd</sup> project submittal (date 2024-04-03) including demolition plan, horizontal control plan, utility plan, grading plan, ADA route, erosion control plan, construction details, dry well drainage detail, and storm water management plan details. With the completion of the town's 3<sup>rd</sup> development review on 9/3/2024, there are minor comments requiring an updated resubmittal to coincide with this agenda item. Additionally, other review agencies have not had the opportunity to review the plans.

- Applicant shall address all outstanding comments from review agencies for the construction plans dated April 3, 2024, prior to final approval of construction documents by the Town.
- Applicant shall revise sheets per CPS Planning's 3<sup>rd</sup> Comments regarding complete labeling of the split 10.00' Utility Easement Rec. 90263 along the southwest property line as indicated and adding "no overnight parking" signage details for on street parking.

#### Access:

Satisfactory. Retail access to the site is provided by Winter Park Drive, an existing 45' ROW, and residential access is provided by Cedar Drive, an existing 30' ROW, which is a paved access drive at the true southwest project corner. There is no paved vehicular access to Balsam Drive at the project's true southeast corner, however there is pedestrian and bike access with use of the proposed 8 foot concrete hike and bike trail between the parallel parking area and retail sidewalk.

#### Transit:

Satisfactory. There is an off-site transit bus shelter located immediately adjacent to the site on the opposite corner of Cedar Drive and Winter Park Drive, operated by The Lift public transportation system. Additionally, patrons and residents of this site will have a short walking distance southward to the Winter Park Express Amtrack Station at the Winter Park ski area base village. No additional transit infrastructure is required for this project.



#### **Pedestrian Access:**

Satisfactory. As stated previously throughout this report, the applicant has designed and will construct the proposed integrated 8 foot wide concrete trail as an extension of the Fraser River trail along Winter Park Drive, between Cedar Drive and Balsam Drive. Pedestrian circulation will mainly be focused southward connecting to the Winter Park ski village.

#### Parks, Trails, and Open Space

Satisfactory. No additional parks, trails and open space are planned with this development. The project's 8 foot wide concrete trail as an extension of the Fraser River trail along Winter Park Drive meets the intent of the Old Town South existing trail plan within the town's 2014 Winter Park and Fraser Community Trails Plan. The applicant will be required to comply with Section 4-B-3, Land Dedication.

#### Parking:

Satisfactory. Per the UDC § 3-H-3(E)/Table 3-H-3-1 and Table 3-H-4, the below parking calculations apply. As stated above in the Variance section of this report, on 7/9/24 the BOA granted a parking variance amending the parking for 2-bedroom units for this project to accommodate the maximum potential for residential parking within the site's property boundary.

Requirement	Required	Provided	
Multifamily Apt 1-BR	(1 space/ 1Bed) = 3 x (1 sp.) = 3	3	
Multifamily Apt 2-BR * BOA reduced the required parking for 2-Bedroom based on site conditions.	(1 space/ 2 Bed) = 6 x (1 sp.) = 6	6	
Guest Parking	(1 space / 10 units) = 1 (per 9 units)	1	
Subtotal	btotal 10 spaces		
Future Restaurant	(1 space/ ea. 250 SF of customer access area) = 980 SF / 250 = 4	8 total On-Street parking spaces available	
Tenant Retail	(1 space/ every 800 SF of GFA, excluding storage and maintenance) = 773 SF / 800 = 1		
Subtotal	5 spaces	8 spaces	
ADA Parking	1	1	
a. Permits on-street parking to count toward non-residential parking in the C-1 zoning district, b. For non-residential uses in C-1 zoning and located within 600ft. of a transit stop, the Director may authorize the reduction of (1) off-site parking or up to a 10% reduction, whichever is greater.			
Total	19 (-1) = 18	18	

#### Setbacks:

Satisfactory. Per the UDC § 3-A-5/Table 3-A-5, Non-Residential and Mixed-Use Building Standards, the applicable setbacks for mixed uses in C-1 zoning are:

• 5' Front Setback, 5' Side Setback, 7.5' Corner Setback, and 5' Rear Setback.



On the Site Plan, the 7.5' Corner Setbacks are correctly applied to both the Cedar Drive and Balsam Drive property sides. The remaining required setbacks comply with the above standards.

#### **Building Coverage:**

N/A. Per the UDC § 3-A-5/Table 3-A-5, Non-Residential and Mixed-Use Building Standards, there is no maximum building coverage for mixed uses in C-1 zoning.

#### **Material and Color:**

Satisfactory. Per the UDC § 3-B-3 - Exterior Building Material Standards, 3-B-4 — Exterior Roofing Materials, and 3-B-5 — Window, Entry and Garage Door Material Standards; the proposed project's Material Board and Elevations depict the following materials. The materials' UDC compliance is indicated below:

•	River Rock Masonry Wood Plank (WD-1) / Shou Sugi Ban Wood Plank (WD-2) / Lunawood	Permitted as Natural Stone (River Rock) Permitted as Vertical Lap Siding Permitted as Vertical Lap Siding					
•	Steel Corrugated Metal Panel (MTL-1) Reflective Metal			•	•	&	Non-
•	Steel Flat Metal Panel (MTL-2) Reflective Metal	Permitted	as	Oxidized,	Weathering,	&	Non-
•	Aluminum Window and Door Trim	Permitted					

The project's color palette is compatible with the proposed exterior materials. The applicant's project narrative provides further insight into the proposed exterior composition and its relationship to local natural features and materials.

#### **Outdoor Lighting:**

Partially Satisfactory. The Photometric Plan indicates three (3) fixture types with two (2) Type E2 fixtures located at the building entrances and two (2) Type EP light poles located at the rear property line to light the back parking area. However, the main building lighting source will come from the proposed Type E1 lights which are Vienna LED Tapelights placed in high quality anodized aluminum channels and mounted to the underside the 1st floor building overhangs which will directly light the River Rock exterior façade wall for ambient lighting.

The specifications of fixture Type EP contain the International Dark Sky Association (IDA) approval stamp. However, fixture Types E1 and E2 are not shown to have IDA certification, per (UDC, § 3-K-3(A)(1)).

Fixture Name	Proposed # of Fixtures	Proposed Lumens per Fixture	Total Proposed Lumens	Proposed CCT
<b>E1</b> Beulux, LED Tape Light, recessed aluminum channel with lenses, wall wash, IP66, mounted at ceiling/overhang of level 1.	Linear Strands	.65 / FT	70 / FT	3000K
<b>E2</b> Prescolite, 4" square downlight, LED, wet listed, mounted in ceiling overhang of Level 1	2	600	1,200	2700K



<b>EP</b> Kim Lighting, UR20 Post Top Pole, 14' height, type 2	2	862	1,724	2700K
optics				
RL Relocated LED	1	800	7,500	4000K
sidewalk/pedestrian light pole				
previously place to light the				
Winter Park ROW and				
existing trail demarcation.				

Applicant shall revise the Photometric Plan and Major Site Plan Application Form (re: Outdoor Lighting Tabulation) and resubmit providing verification of IDA compliance for fixtures E1 and E2 with an updated product specification, and a revision to the chart on the Application Form to match the Photometric Plan.

#### Floorplans:

Satisfactory. The proposed Floor Plans depict individual 1- and 2-bedroom units with private entrances from the  $2^{nd}$  floor corridor and separated by a demising party wall which meets the UDC § 7.C. "Definitions" for "Apartment".

#### **Building Height:**

Satisfactory. Per the UDC § 3-A-5/Table 3-A-5, Non-Residential and Mixed-Use Building Standards, the maximum height for mixed use building in C-1 zoning is 35 feet. The proposed project's Elevations depict compliance of 35 feet at the mid-slope of the "saw tooth/shed" roof forms, following the UDC § 3-A-7-E/Figure 3-A-7-5 for Measuring Building Heights at Roof Types.

#### **Building Elevations:**

Satisfactory. The proposed project complies with the 2021 Update to the Design Guidelines. Additionally, the building's modern architecture provides a high-quality visual interest with the play of symmetric and asymmetric building forms.

#### Signage:

Satisfactory. The elevations depict an overall building sign on the main elevation and two (2) retail tenant wall signs for context to the proposed commercial uses at the building's main level. Any site or building signage will be reviewed administratively via a separate Sign Permit Application.

#### **Bufferyards and Revegetation:**

Satisfactory. The project is subject to the requirements in the UDC § 3-I-5(C)/Table 3-I-5-1, Bufferyard Classifications, § 3-I-5(D)/Table 3-I-5-2, District Buffer Yard Standards, and Table 3-I-5-3, Bufferyard Requirements for Streets.

Property Zoning	Adjacent Property Zoning	Bufferyard Type Required	Bufferyard Type Provided	Bufferyard Complies/Deficient
C-1	N / C-1 & Non- Res. Collector S / R-20 E / C-1 W / C-1	B, modified to A B A B	NA B Modified NA B Modified	Deficient, due to site conditions



Town staff confirmed on 12/11/2023, the applicant could apply Section 3-I-5-H to provide a Type A Bufferyard at Winter Park Drive.

As stated above under "Variance", the applicant requested and received staff approval for a Landscape Variance to provide a Modified Type A bufferyard/plantings along Winter Park Drive and a Modified Type B bufferyard/plantings to compensate for minimal compliance to Type A and B along the other 3 property setbacks. The site is constrained by its geometry which is bounded by ROW and access drives on three sides, in addition to the proposed 8ft wide Fraser River Trail parallel to Winter Park Drive which limits adequate planting. The use of ornamental grasses and flowers within street side planting areas and planter boxes are an agreed solution to meet the Type A bufferyard intent. The Modified Type B Bufferyard is approved as proposed as it concentrates plantings within available open space areas at the north and southeast property sides due to direct paving on the south and west sides.

#### **Erosion Control / Drainage Plan / Drainage Report:**

Partially satisfactory. The Erosion Control Plan, Grading Plan and Drainage Report have been reviewed by the Town Engineer per UDC § 3-F-3. The Town Engineer might have a few outstanding/unresolved comments per the issued 4/26/2024 JVA review letter regarding dry well capacity for historic storm events and the down-stream discharging of the trench drain located next the retail sidewalk and street-side planting area. Refer to the Construction Plans/ Sheet OU1.

Applicant shall coordinate and resolve all outstanding comments made on the 4/26/2024 JVA review letter regarding the dry well and trench drains as indicated on the Construction Plans/ Sheet OU1, prior to final approval of the Site Plan and Construction Plans.

#### **Snow Storage:**

Partially Satisfactory. The Site Plan and Snow Storage Table have been reviewed for compliance with the UDC § 3-H-5(A), Snow Storage, and is found to be compliant. Based on impervious surface data, a minimum area of 25% (1,581 SF) is required. The proposed snow storage provided is 25% (1,581SF), made up of 607 SF of on-site snow storage as indicated on the Site Plan/ Sheet C1.01 and a remainder of 974 SF to be hauled off or snow melted to meet full compliance. Per discussions with town staff on 8/16/2024, the below agreement was made,

The applicant shall finalize and submit a plan and agreement regarding snow removal and off-site storage to town planning staff as a condition of approval to the Major Site Plan application.

#### 5% Land Dedication:

Satisfactory: Section 4-B-3 of the UDC requires either the dedication, reservation or conveyance of areas suitable for public purposes such as parks, flood channels, scenic areas and greenbelts of five percent (5%) of the total area of the subdivision, or a payment in lieu of such dedication. Since there is no land that the Town desires for parks and open space, a fee in lieu shall be paid to the Town in accordance with § 4-B-6, Fee-in-Lieu.

#### School Impact Fee:

Satisfactory: Dedication of a school site was not deemed reasonably necessary for this project; therefore, it is subject to a fee-in-lieu of dedication. Section 4-B-6 of the UDC states the payment of cash by the applicant is subject to the land calculations rates of Table 4-B-3, School Land Dedication Calculations. Resolution 2050, Series 2023 set the price per unit. The school impact fees shall be payable prior to as-built plat recordation.



#### **Development Improvements Agreement (DIA):**

Partially Satisfactory: A <u>Development Improvement Agreement</u> and IA are not required with this project. Per the Town Engineer's 4/26/2024 JVA review letter, the applicant shall update the <u>Engineer's Estimate of Probable Costs (EEOPC)</u> to include all improvements both onsite and offsite, and to include costs to relocate the existing power pole and light pole. A revised EEOPC was submitted with the 8/22/2024 resubmittal, yet it has not gained final signoff/acceptance from the Town Engineer.

The Town Engineer shall review and either coordinate additional revisions to the 8/22/2024 EEOPC or indicate acceptance to the applicant.

#### **Review Agency Comments:** (View agency comment letters here.)

#### • U.S. Army Corps of Engineers

An initial development packet was submitted to Benjamin Wilson with USACE on 11/08/2023. No referral comments were received during the project's review period.

#### CDOT

On 4/09/2024, Brian Killian, Region 3 Access Program Manager and Kandis Aggen stated CDOT has no comments regarding this application.

#### Comcast

An initial development packet was submitted to Comcast on 11/08/2023. No referral comments were received during the project's review period.

#### Colorado Parks and Wildlife

An initial development packet was submitted to Jeromy Huntington with CPW on 11/08/2023. No referral comments were received during the project's review period.

#### East Grand Fire Protection District No. 4

On 11/27/2023, Assistant Fire Chief/Fire Marshal, Dennis Soles, provided a letter stating suggestions for compliance.

Applicant shall address to EGFPD's satisfaction, all comments in the 11/27/2023, letter.

#### JVA

On 4/26/2024, Cooper Karsh, Senior Engineer at JVA identified the following issues: 1) dry well capacity for historic storm events and the down-stream discharging of the trench drain located next the retail sidewalk and street-side planting area, 2) to include all improvements both onsite and offsite, and to include costs to relocate the existing power pole and light pole and 3) coordinate with town staff for a detailed plan regarding hauled snow removal.

Applicant shall address to JVA's satisfaction, all comments in the 4/26/2024, letter.

#### Mountain Parks Electric, Inc.

On 4/25/2024, Jessica Tain, Right of Way Specialist, stated 11 review comments for coordination and has yet to sign off on the review. On 8/14/2024 the applicant outreached to MPEI and Xcel for a combined meeting to address outstanding comments and finalize utility designs since the applicant was successful in gaining the requested parking variance



through BOA. CPS planning staff is not aware of a resolution to this meeting and is conditioning this Site Plan approval upon further coordination with MPEI and Xcel regarding utility planning.

Applicant shall address to MPEI's satisfaction, all comments in the 4/25/2024 email.

#### Winter Park Water and Sanitation District (WPWSD)

On 4/16/2024, Bill Wemmert at AECOM representing the District indicated the reviewed 4/04/2024 Construction Plans were not corrected based on the District's last comment letter.

Applicant shall address to WPWSD's satisfaction, all comments in the 4/14/2024 comment letter.

#### Xcel Energy

On 4/10/2024, Julie Gittins, Design Planner, stated Xcel has not received applicant responses to their prior 11/28/23 comment letter.

➤ Applicant shall address to Xcel's satisfaction, all comments in the 4/10/2024 email and 11/28/23 comment letter.

As previously stated, there are outstanding comments from review agencies. Updated documents were distributed for referral agency review on 4/4/2024 and 8/22/2024. With the 8/22 submittal, agency comments are due 9/9/2024 and will be made part of the public record when presenting before PC on 9/10/2024.

#### **Inspection:**

Building Division staff have not performed a Pre-Disturbance inspection of the property.

#### **Staff Recommendation:**

Staff finds the applicant has submitted all required materials within the timeframe required and all other materials comply with the conditions of § 5-E-1 of the UDC and conform to all applicable policies and regulations of the UDC. Staff therefore recommends approval of the Major Site Plan subject to the following conditions:

- Applicant shall submit for administrative review and approval a Condominium Plat (per the UDC § 5-D-2(D) and 5-D-9) once construction is complete and prior to the transfer or sale of property to establish airspace rights of ownership per unit and define maintenance obligations and fees for condominium common elements, infrastructure and landscaping.
- 2. Applicant shall submit a Homeowners' Association (HOA) Declaration of Covenants for administrative review defining maintenance obligations and fees for condominium common elements, infrastructure, and landscaping.
- 3. The applicant shall prepare and submit the required "The Declaration of Covenants and asbuilt shall include language indicating only one parking space is provided per unit and onstreet overnight parking is not permitted for residential use." as a condition of the BOA variance approval.
- 4. Applicant shall address all outstanding comments from review agencies for the construction plans dated April 3, 2024, prior to final approval of construction documents by the Town.
- 5. Applicant shall revise sheets per CPS Planning's 3rd Comments regarding complete labeling of the split 10.00' Utility Easement Rec. 90263 along the southwest property line as



indicated.

- Applicant shall revise the Photometric Plan and Major Site Plan Application Form (re: Outdoor Lighting Tabulation) and resubmit providing verification of IDA compliance for fixtures E1 and E2 with an updated product specification, and a revision to the chart on the Application Form to match the Photometric Plan.
- 7. Applicant shall coordinate and resolve all outstanding comments made on the 4/26/2024 JVA review letter regarding the dry well and trench drains as indicated on the Construction Plans/ Sheet OU1, prior to final approval of the Site Plan and Construction Plans.
- 8. The applicant shall finalize and submit a plan and agreement regarding snow removal and off-site storage to town planning staff as a condition of approval to the Major Site Plan application.
- 9. The Town Engineer shall review and either coordinate additional revisions to the 8/22/2024 EEOPC or indicate acceptance to the applicant.
- 10. Applicant shall address to EGFPD's satisfaction, all comments in the 11/27/2023, letter.
- 11. Applicant shall address to JVA's satisfaction, all comments in the 4/26/2024, letter.
- 12. Applicant shall address to MPEI's satisfaction, all comments in the 4/25/2024 email.
- 13. Applicant shall address to WPWSD's satisfaction, all comments in the 4/14/2024 comment letter.
- 14. Applicant shall address to Xcel's satisfaction, all comments in the 4/10/2024 email and 11/28/23 comment letter.
- 15. Applicant shall submit an easement to the Town for the portion of the bike lane that does not lie within the public right-of-way.

#### Sample Motion for Approval:

I move to approve the Major Site Plan (PLN23-098) for 1097 Winter Park Drive as it was determined the applications are in conformance with § 5-E-1 of the UDC with the staff conditions to be met and/or provided prior to any final approval.

#### **Sample Motion for Denial:**

I move to deny the Major Site Plan (PLN23-098) for 1097 Winter Park Drive as it was determined the applications are NOT conformance with § 5-E-1 of the UDC *[insert explanation supported by the evidence here].* 





## **Land Use Review Application Form**

#### **Contact Information**

Property Owner Representative (i.e., the point of contact) LXXTWO, LLC **DEVIN VISCIANO** Company Company N/A WHITE DEVELOPMENT, LLC Phone # Email Address Phone # Email Address 303.506.5995 DVISCIANO@WHITE-DEV.COM TWHITE@WHITE-DEV.COM 303.591.5735

Billing Contact (where invoices should be directed)

SUZI BACH			
Company	Phone #	Email A	ddress
RAMSGATE MANAGEMENT	719.339.3133	SUZIBAC	CH@COMCAST.NET
Mailing Address	City	State	Zip
9524 CARRIAGE CREEK POINT	COLORADO SPRINGS	СО	80920

### Site Description

Site Address	Parcel Identification Number(s) (PIN)
1097 WINTER PARK DRIVE	170510105015
Existing Zone Classification	Site Area (acres and sq. ft.)
C1/LIMITED COMMERCIAL	0.405 ACRES; 17641.80 SQ.FT.

### **Project Description**

Project Name

**RAILWATER** 

Brief description of the proposed project

A three-story mixed-use building with two main-level commercial units (one restaurant ready, and one retail) and nine residential units above.

#### **Required Documents**

For an application to be considered complete and for Planning Division staff to begin review and schedule any applicable public hearings, this Land Use Review Application Form must be fully completed and all required attachments included. Staff will review the application for completeness and notify the representative and/or owner whether the application has been deemed complete.

#### Certifications

#### REPRESENTATIVE CERTIFICATION

By signing this application, I attest that I am acting with the knowledge and consent of all owners of the property that is the subject of this application, and that I have been designated to act as the representative for the project described in this land use application. I further certify that all information submitted with this application is true and accurate to the best of my knowledge.

Representative	Date	
Devin N. Visciano	9/19/2023	

#### OWNER CERTIFICATION

I hereby certify that I am the legal owner of record of the property that is the subject of this application. I authorize the representative listed on this application, if any, to communicate directly with Town officials and to submit documentation and information regarding this application on my behalf.

Owner Date

Timothy L. White 9/19/2023

In addition to the base fees the applicant is required to pay the cost of any referral agency reviews, public notices, hearings, and record keeping as outlined within § 5-B-6, Application Fees, in the UDC.

Development Improvements Dedications, Agreements, and Guarantees (Article 4.B)	Site Development and Permit Decisions (Article 5.E)
☐ Development Improvements Agreements (DIA)	☑ Major Site Plan*
☐ Public Improvement Cost-Recovery Agreement	☐ Minor Site Plan
Standardized Development Review Procedures (Article 5.B)	Administrative Site Plan
☐ Pre-Application Conference	Special Use Permit (Including High-Impact Short-Term Rentals)*
Renewal of Approvals	Limited Use Authorization
☐ Vested Rights	☐ Temporary Use Permit
Ordinance and Zoning Amendment Decisions (Article 5.C)	☐ Floodplain Development Permit
☐ Text Amendment	☐ Lighting by Special Permit
Rezoning	☐ Parking Reductions and Alternative Parking Plan Permit
Rezoning to Planned Development:  Preliminary Development Plan*	☐ Street Renaming
☐ Final Development Plan* ☐ Amended Final Development Plan*	
	Appeal, Variance, and Interpretation Decisions (Article 5.F)
Amended Final Development Plan*	Appeal, Variance, and Interpretation Decisions
☐ Amended Final Development Plan* ☐ Annexation*	Appeal, Variance, and Interpretation Decisions (Article 5.F)
☐ Amended Final Development Plan* ☐ Annexation*  Subdivision and Platting Decisions (Article 5.D)	Appeal, Variance, and Interpretation Decisions (Article 5.F)  Appeal
<ul> <li>☐ Amended Final Development Plan*</li> <li>☐ Annexation*</li> <li>Subdivision and Platting Decisions (Article 5.D)</li> <li>☐ Exemption Plat</li> </ul>	Appeal, Variance, and Interpretation Decisions (Article 5.F)  Appeal  Appeal  Appeal of Administrative Decisions
<ul> <li>☐ Amended Final Development Plan*</li> <li>☐ Annexation*</li> <li>Subdivision and Platting Decisions (Article 5.D)</li> <li>☐ Exemption Plat</li> <li>☐ Minor Plat*</li> </ul>	Appeal, Variance, and Interpretation Decisions (Article 5.F)  Appeal  Appeal of Administrative Decisions  Variance*
☐ Amended Final Development Plan*   ☐ Annexation*   Subdivision and Platting Decisions (Article 5.D)   ☐ Exemption Plat   ☐ Minor Plat*   ☐ Preliminary Plat*	Appeal, Variance, and Interpretation Decisions (Article 5.F)  Appeal  Appeal of Administrative Decisions  Variance*
☐ Amended Final Development Plan*   ☐ Annexation*   Subdivision and Platting Decisions (Article 5.D)   ☐ Exemption Plat   ☐ Minor Plat*   ☐ Preliminary Plat*   ☐ Final Plat*	Appeal, Variance, and Interpretation Decisions (Article 5.F)  Appeal  Appeal of Administrative Decisions  Variance*
☐ Amended Final Development Plan*   ☐ Annexation*   Subdivision and Platting Decisions (Article 5.D)   ☐ Exemption Plat   ☐ Minor Plat*   ☐ Preliminary Plat*   ☐ Final Plat*   ☐ Resubdivision*	Appeal, Variance, and Interpretation Decisions (Article 5.F)  Appeal  Appeal of Administrative Decisions  Variance*
☐ Amended Final Development Plan*   ☐ Annexation*   Subdivision and Platting Decisions (Article 5.D)   ☐ Exemption Plat   ☐ Minor Plat*   ☐ Preliminary Plat*   ☐ Final Plat*   ☐ Resubdivision*   ☐ Waiver*   ☐ Vacation of Plat, Street, Right of Way, and	Appeal, Variance, and Interpretation Decisions (Article 5.F)  Appeal  Appeal of Administrative Decisions  Variance*

#### Instructions for Submitting the Land Use Review Application Form

#### **Definitions**

- Words in the singular include the plural and words in the plural include the singular.
- APPLICATION refers to the official submittal to the Town's Planning Division for review of the proposed land
  use development identified in the Land Use Review Application Form. The application includes the form, all
  materials submitted for review of the project, including those documents required by the Unified Development
  Code (the "UDC") and any additional information provided.
- PROJECT refers to the land use development identified on this Form and application materials.
- PROPERTY refers to the land that is being proposed for development as described in this Form and application materials.

#### **General Notes**

If information will not fit in the space provided,

#### A. CONTACT INFORMATION

- 1. Provide contact information for all owners of any property that is the subject of the application. Submit a separate sheet for the additional owners if information will not fit in space provided.
- 2. Provide contact information for all persons, firms or businesses that are authorized by the owners identified in Section A(1) to work on the land use application, including, but not limited to, discussing the project, submitting application materials, and attending meeting and hearings.
- 3. Provide contact and mailing information for the person that should receive all invoices for the project. If the Billing Contact changes at any time, contact the Planning Division immediately to update this information.

#### **B. SITE DESCRIPTION**

Parcel identification numbers (PINs) and address information may be found at the Grand County Property Viewer. Current zoning may be found on the Town of Winter Park's website.

#### APPLICATION TYPE

C. Select the land use application type that is applicable to the project. If there are multiple land use application types being submitted to run concurrently, select all that apply. The land use application types will be identified during the Pre-Application Conference (if required).

#### PROJECT DESCRIPTION

D. Select a project name that will be referenced throughout the project and a description of what the project entails. If you need more space for the project description, attach a separate sheet.

#### **REQUIRED ITEMS**

E. Required documents will be discussed during the Pre-Application Conference with the Planning Division, if required. If any documents are missing, the acceptance of the application may be delayed until the submittal is complete.

#### F CERTIFICATIONS

Representative Certification. Provide the signature of all authorized representatives in this section. Owner Certification. Provide the signature of all owners of properties included in the application in this section.

For any other questions, contact the Planning Division at <a href="mailto:permits@wpgov.com">permits@wpgov.com</a>



#### MAJOR SITE PLAN APPLICATION

Project Narrative 1097 Winter Park Drive Winter Park, Colorado

Project Name: RailWater

**Project Summary:** White Development is currently developing the property located at 1097 Winter Park Drive to be a stand-out asset in the rapidly growing Town of Winter Park, Colorado. The Project Site consists of a single lot--Parcel ID No: 170510105015, 0.405 acres. The Project Site is located approximately 2,600 feet (0.5 Miles) from the Base Village of the Winter Park Ski Resort and approximately 2,000 feet from the stop of the Amtrak Winter Park Express (the "Ski Train"). The Project Site is located approximately 2.4 miles from Hideaway Park in downtown Winter Park (the approximate center of the Town's main commercial area).

The design for the site is a three-story mixed-use building with two main-level commercial units and nine residential units above. The working name for the building is RailWater, a nod to the Moffat Tunnel project's dual purpose of providing rail access and water infrastructure to the Front Range. The project is located within the Old Town area of Winter Park, which is adjacent to the Base Village of the ski resort, within a 5-minute drive to Winter Park's main commercial area and with pedestrian access to all parts of the Fraser River Valley via the Frasier River multi-use path.

The exterior finishes of the building are selected to tell the story of the building's location with river rock masonry on the lower level (the Frasier River) and charred beetle kill pine siding on the upper levels (the Arapahoe National Forest). Large floor to ceiling windows provide exceptional views from the living rooms and master bedrooms of the six larger units, while decks on the backside of the units provide outdoor space. The third-floor landing above the lobby will provide a common recreation area (pool table, fireplace, lounge seating) and each unit has a secure bike and ski storage locker on the main level. Three smaller one-bedroom units are designed to be placed into the Town's long-term workforce housing program.

The main level will house two commercial units—one will be built out to be restaurant ready, and the other will be for retail (the Alpine Sun Aki Shop has committed to relocating into the new retail space upon completion of the building).

Address: 1097 Winter Park Drive, Winter Park, CO 80482

#### Owner:

LXXTWO, LLC C/O White Development, LLC PO Box 178, Denver, CO 80201





Contact Person: Devin Visciano; 303.506.5995; DVisciano@White-Dev.com

#### **Developer/Applicant:**

White Development, LLC LXXTWO, LLC C/O White Development, LLC PO Box 178, Denver, CO 80201

Contact Person: Devin Visciano; 303.506.5995; DVisciano@White-Dev.com

Project Manager: Devin Visciano; 303.506.5995; <u>DVisciano@White-Dev.com</u>

#### **Architect:**

Roth Shepherd Architects 700 E. 24<sup>th</sup> Ave. Denver, CO 80205

Contact Persons: Adam Harding, AIA; 303.534.7007; aharding@rothsheppard.com;

Marc Daubert, AIA; 303.534.7007; mdaubert@rothsheppard.com

#### **Civil Engineer:**

Personalized Engineering Solutions 9249 S. Broadway #200 - 388 Highlands Ranch, Colorado 80129

Contact Person: Stephen Douglas, PE; 303.503.6115; sdouglas@pengsolutions.com

#### **MEP Engineer:**

RJA Engineering 3301 Lawrence Street, Suite 2 Denver, CO 80205

Contact Person: Darin Ramirez, PE; 303.557.8634; darin@rja-eng.com

#### **Surveyor:**

Rocky Mountain Surveys, Inc. PO Box 552 Winter Park, CO 80482





Contact Person: Warren Ward; 970.726.7166; wward1224@comcast.net


Legal Description: Subd: WINTER PARK VILLAGE Lot: A Block: 3

Zoning District: C1/Limited Commercial

Lot Size: 0.405 Acres; 17641.80 sq.ft.

**Project Details:** The planned building at the Project site is a three-story structure with two commercial units on the main level (1,362 sq. ft. retail space; 1,419 sq. ft. restaurant space with 1,000 sq. ft. outdoor patio) and nine residential units on the two floors above. There are a total of six (6) split level 2 bedroom/2.25 bath units and three (3) 1 bedroom/1 bath units. The residential units will be **for-sale condominum units.** 

The building's residential unit mix is as follows:

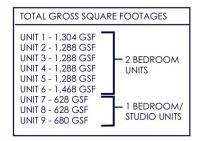

**Total Building Gross Square Footage: 18,055** 

**Parking Details:** The project has ten (10) off-street parking spaces serving the residential components of the building. An additional eight (8) on-street parking spaces are proposed along Winter Park Drive along the Property as allowed by Ordinance 610 (An Ordinance of the Town of Winter Park Amending Title 7, Article 3 of the Winter Park Municipal Code Regarding On-Street Parking) approved by the Town Council on September 19, 2023. The on-street parking spaces are designed to also provide improvements to the Frasier River Bike Trail and pedestrian infrastructure (sidewalks, crosswalks, etc.).



## WINTER PARK - OLD TOWN LOT

1097 Winter Park Drive Winter Park, CO 80482 2128

WHITE DEVELOPMENT, LLC

P: 303.506.5995

CONTACT: DEVIN VISCIANO

ARCHITECT:

ROTH SHEPPARD ARCHITECTS, LLP 1900 WAZEE STREET, SUITE 100 DENVER, CO 80202

P: 303.534.7007 F: 303.534.7722

ARCHITECT OF RECORD: ADAM HARDING, AIA

MECHANICAL, ELECTRICAL AND PLUMBING ENGINEER:

RAMIREZ, JOHNSON & ASSOCIATES 3301 LAWRENCE ST. SUITE #2, DENVER, CO 80205

P: 720.598.0774

CONTACT: ANDY ACHTERMANN, PE

PERSONALIZED ENGINEERING SOLUTIONS 9249 S. BROADWAY #200-388 HIGHLANDS RANCH, COLORADO 80129

P: 720.388.8126


CONTACT: STEPHEN DOUGLAS, PE

LANDSCAPE ARCHITECT:

NEILS LUNCEFORD, INC. P.O. BOX 2130 740 BLUE RIVER PARKWAY SILVERTHORNE, CO 80498

P: 970.468.0340

CONTACT: LAYLA LAZOUSKI

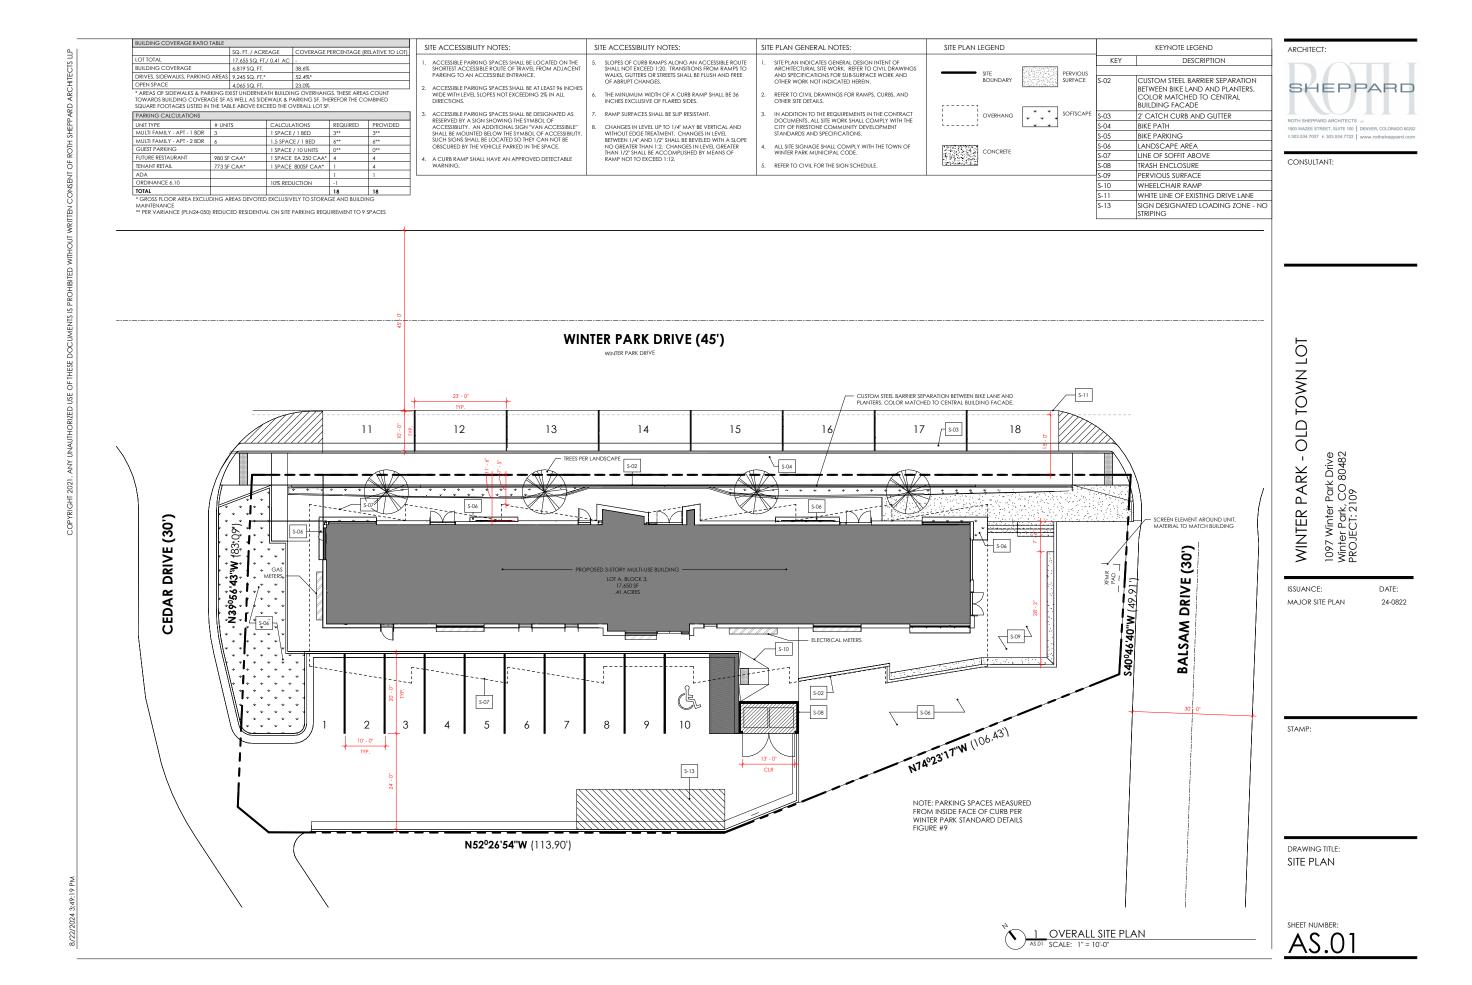

OVERALL FLOOR PLAN - LEVEL 01

A1.01 SCALE: 1/8" = 1'-0"

- RE: STRUCT FOR FOUNDATION WALL DIMENSIONS
- TYP INTERIOR DIMS TAKEN FROM FACE OF GYP, UNLESS NOTED OTHERWISE
- TYP EXTERIOR DIMS:

  ALL-GLASS\_ENIBLES DIMS TO SYSTEM CL
  STOREFROMT DIMS TO EXIT FO FRAME
  (NOT INCLUDING EXTENDED MULLION CAP)
  CLERESTORY DIMS TO EXIT FO FRAME
  STONE RAINSCREEN DIMS TO EXIT FO STONE
- ALL SLAB ON GRADE JOINTS, INCLUDING SLAB PERIMETER JOINTS, SHALL BE FILLED WITH SEALANT; SEALANT COLOR TO BE VERTIFED WITH ARCHITECT FOR ALL JOINTS EXPOSED TO VIEW.
- REFER TO A9.00 FOR EXTERIOR 3D AXONOMETRIC VIEWS.

ARCHITECT:

SHEPPARD

1900 WAZEE STREET, SUITE 100 | DENVER, COLORADO 80202 T.303.534.7007 F.303.534.7722 | www.rothsheppard.com

CONSULTANT:

WINTER PARK - OLD TOWN LOT

MAJOR SITE PLAN


1097 Winter Park Drive Winter Park, CO 80482 PROJECT: 2109 ISSUANCE: DATE:

24-0822

STAMP:

DRAWING TITLE: OVERALL FLOOR PLAN -LEVEL 01

SHEET NUMBER: A1.01

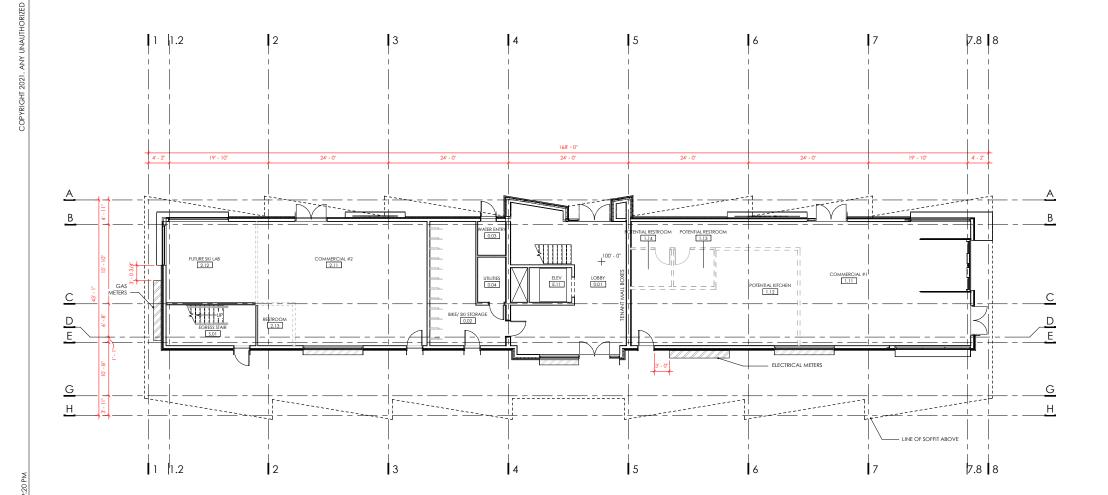

OVERALL FLOOR PLAN - LEVEL 02

A1.02 SCALE: 1/8" = 1'-0"

- . RE: STRUCT FOR FOUNDATION WALL DIMENSIONS
- TYP INTERIOR DIMS TAKEN FROM FACE OF GYP, UNLESS NOTED OTHERWISE
- 3. TYP EXTERIOR DIMS:

  AL-GLASS ENTRIES DIMS TO SYSTEM CL
  STOREFEONT DIMS TO EXI FO FRAME
  [NOT INCLUDING EXTENDED MULLION CAP]
  CLEESTORY DIMS TO EXT FO FRAME
  STONE RAINSCREEN DIMS TO EXT FO STONE
- ALL SLAB ON GRADE JOINTS, INCLUDING SLAB PERIMETER JOINTS, SHALL BE FILLED WITH SEALANT; SEALANT COLOR TO BE VERIFIED WITH ARCHITECT FOR ALL JOINTS EXPOSED TO VIEW.
- . REFER TO A9.00 FOR EXTERIOR 3D AXONOMETRIC VIEWS.

ARCHITECT:

SHEPPARD
ROTH SHEPPARD ARCHITECTS up

ROTH SHEPPARD ARCHITECTS UP

1900 WAZEE STREET, SUITE 100 | DENVER, COLORADO 8020;

7.303.534.7007 

8.303.534.7722 | www.rothsheppard.com

CONSULTANT:

WINTER PARK - OLD TOWN LOT

1097 Winter Park Drive Winter Park, CO 80482 PROJECT: 2109


ISSUANCE: DATE: MAJOR SITE PLAN 24-0822

STAMP:

DRAWING TITLE:

OVERALL FLOOR PLAN LEVEL 02

A 1.02

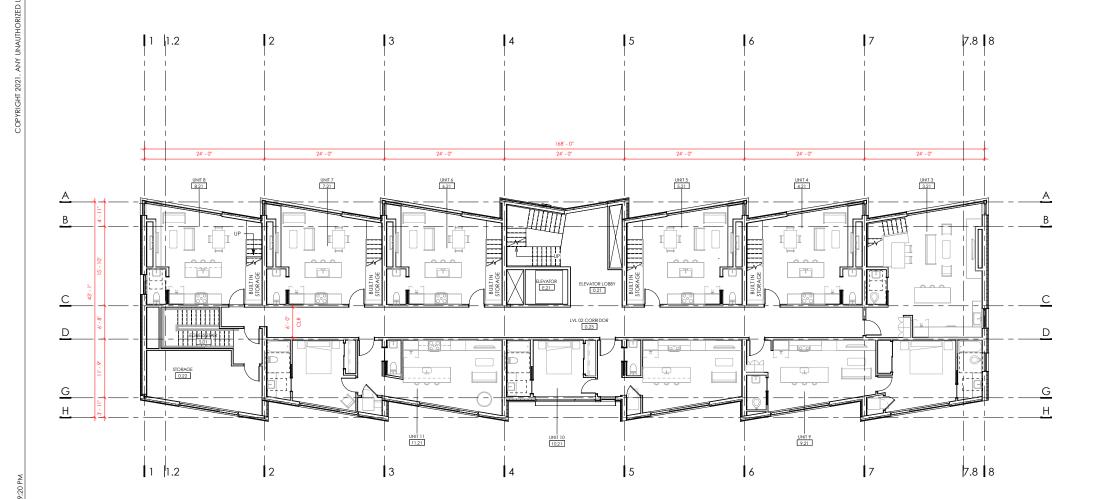

OVERALL FLOOR PLAN LEVEL - 03

A1.03 SCALE: 1/8" = 1'-0"

- . RE: STRUCT FOR FOUNDATION WALL DIMENSIONS
- TYP INTERIOR DIMS TAKEN FROM FACE OF GYP, UNLESS NOTED OTHERWISE
- 3. TYP EXTERIOR DIMS:

  AL-GLASS ENTRIES DIMS TO SYSTEM CL
  STOREFEONT DIMS TO EXI FO FRAME
  [NOT INCLUDING EXTENDED MULLION CAP]
  CLEESTORY DIMS TO EXT FO FRAME
  STONE RAINSCREEN DIMS TO EXT FO STONE
- ALL SLAB ON GRADE JOINTS, INCLUDING SLAB PERIMETER JOINTS, SHALL BE FILLED WITH SEALANT; SEALANT COLOR TO BE VERIFIED WITH ARCHITECT FOR ALL JOINTS EXPOSED TO VIEW.
- 5. REFER TO A9.00 FOR EXTERIOR 3D AXONOMETRIC VIEWS.

ARCHITECT:

SHEPPARD

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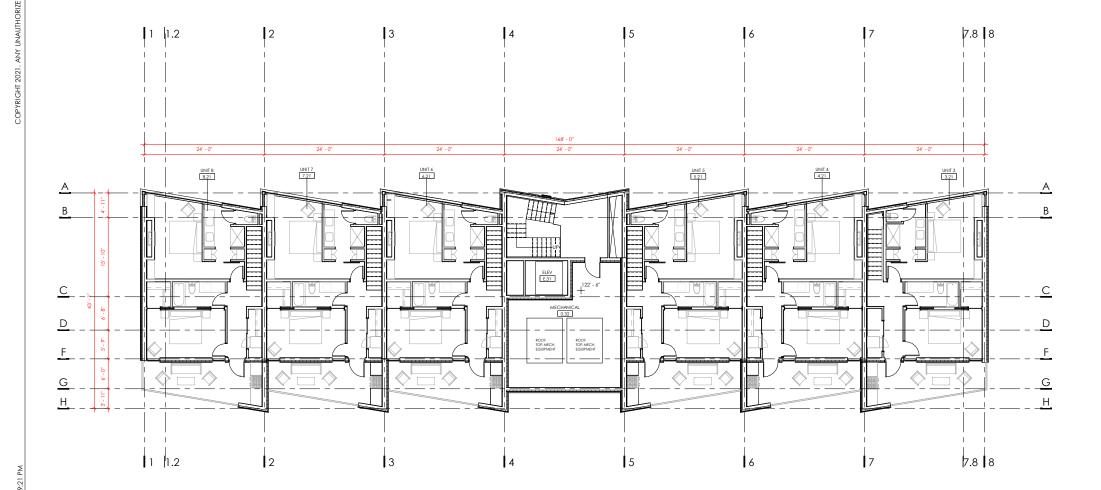
ISSUANCE: DATE: MAJOR SITE PLAN 24-0822

STAMP:

DRAWING TITLE:

OVERALL FLOOR PLAN LEVEL 03

A 1.03



- RE: STRUCT FOR FOUNDATION WALL DIMENSIONS
- 2. TYP INTERIOR DIMS TAKEN FROM FACE OF GYP, UNLESS NOTED OTHERWISE
- 3. TYP EXTERIOR DIMS:
  ALL-GLASS ENTIRES DIMS TO SYSTEM CL.
  STOREEDON DIMS TO SEXT FO FRAME
  (NOT INCLUDING EXTENDED MULLION CAP)
  CLEESTORY DIMS TO EXT FO FRAME
  STONE RAINSCREEN DIMS TO EXT FO STONE
- ALL SLAB ON GRADE JOINTS, INCLUDING SLAB PERIMETER JOINTS, SHALL BE FILLED WITH SEALANT; SEALANT COLOR TO BE VERTIED WITH ARCHITECT FOR ALL JOINTS EXPOSED TO VIEW.
- 5. REFER TO A9.00 FOR EXTERIOR 3D AXONOMETRIC VIEWS.

ARCHITECT:



ROTH SHEPPARD ARCHITECTS LLP
1900 WAZEE STREET, SUITE 100 | DENVER, COLORADO 80202
1.303.534.7007 p. 303.534.7722 | www.rothsheppard.com

CONSULTANT:


WINTER PARK - OLD TOWN LOT 1097 Winter Park Drive Winter Park, CO 80482 PROJECT: 2109

ISSUANCE: DATE: MAJOR SITE PLAN 24-0822

STAMP:

DRAWING TITLE: OVERALL ROOF PLAN

SHEET NUMBER:

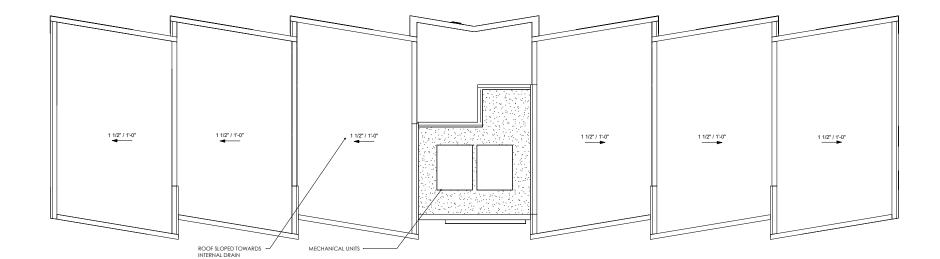

OVERALL ROOF PLAN

A1.21 SCALE: 1/8" = 1'-0"



MATERIAL LEGEND:

CONC-I) CAST IN PLACE CONCRETE, BROOM FINISH

CONC-2) BOARD FORM CONCRETE, VERTICAL ORIENTATION

EGL-01) EXTERIOR GLAZING, LOW-E, ULTRA-CLEAR

MTL-01 STEEL CORRUGATED METAL PANEL, WEATHERED, 22 GA

MTL-02 STEEL FLAT METAL PANEL, WEATHERED, 11 GA

(STN-1) RIVER ROCK MASONRY

(WD-1) SHOU SUGI BAN WOOD, VERTICAL ORIENTATION

WD-2 LUNAWOOD, VERTICAL ORIENTATION

BOARD FORM CONCRETE (CONC-2)
 THE BOARD FORM CONCRETE ADDS A HUMAN SCALE
 TO THE CONCRETE WHILE RELATING TO THE TEXTURE
 OF THE BUILDINGS SHOU SUGI BAN SIDING

ARCHITECT:

SHEPPARD

ROTH SHEPPARD ARCHITECTS LLP
1900 WAZEE STREET, SUITE 100 | DENVER, COLORADO 80202
T.303.534.7007 F.303.534.7722 | www.rothsheppard.com

CONSULTANT:

WINTER PARK - OLD TOWN LOT

1097 Winter Park Drive Winter Park, CO 80482 PROJECT: 2109

ISSUANCE: DATE: MAJOR SITE PLAN 24-0822

STAMP:

DRAWING TITLE:
MATERIAL BOARD

SHEET NUMBER: A 2.02

1 MATERIAL BOARD ELEVATION
A2.02 SCALE: 1/4" = 1'-0"



3 NORTHWEST PERSPECTIVE
A9.00 SCALE: N.T.S.



2 SOUTHEAST PERSPECTIVE
A9.00 SCALE: N.T.S.



1 NOTH PERSPECTIVE
A9.00 SCALE: N.T.S.

ARCHITECT:

SHEPPARD

1900 WAZEE STREET, SUITE 100 | DENVER, COLORADO 8

CONSULTANT:

WINTER PARK - OLD TOWN LOT

1097 Winter Park Drive
Winter Park, CO 80482
PROJECT: 2109

MAJOR SITE PLAN


ISSUANCE: DATE:

24-0822

STAMP:

DRAWING TITLE:
EXTERIOR PERSPECTIVES

A9.00

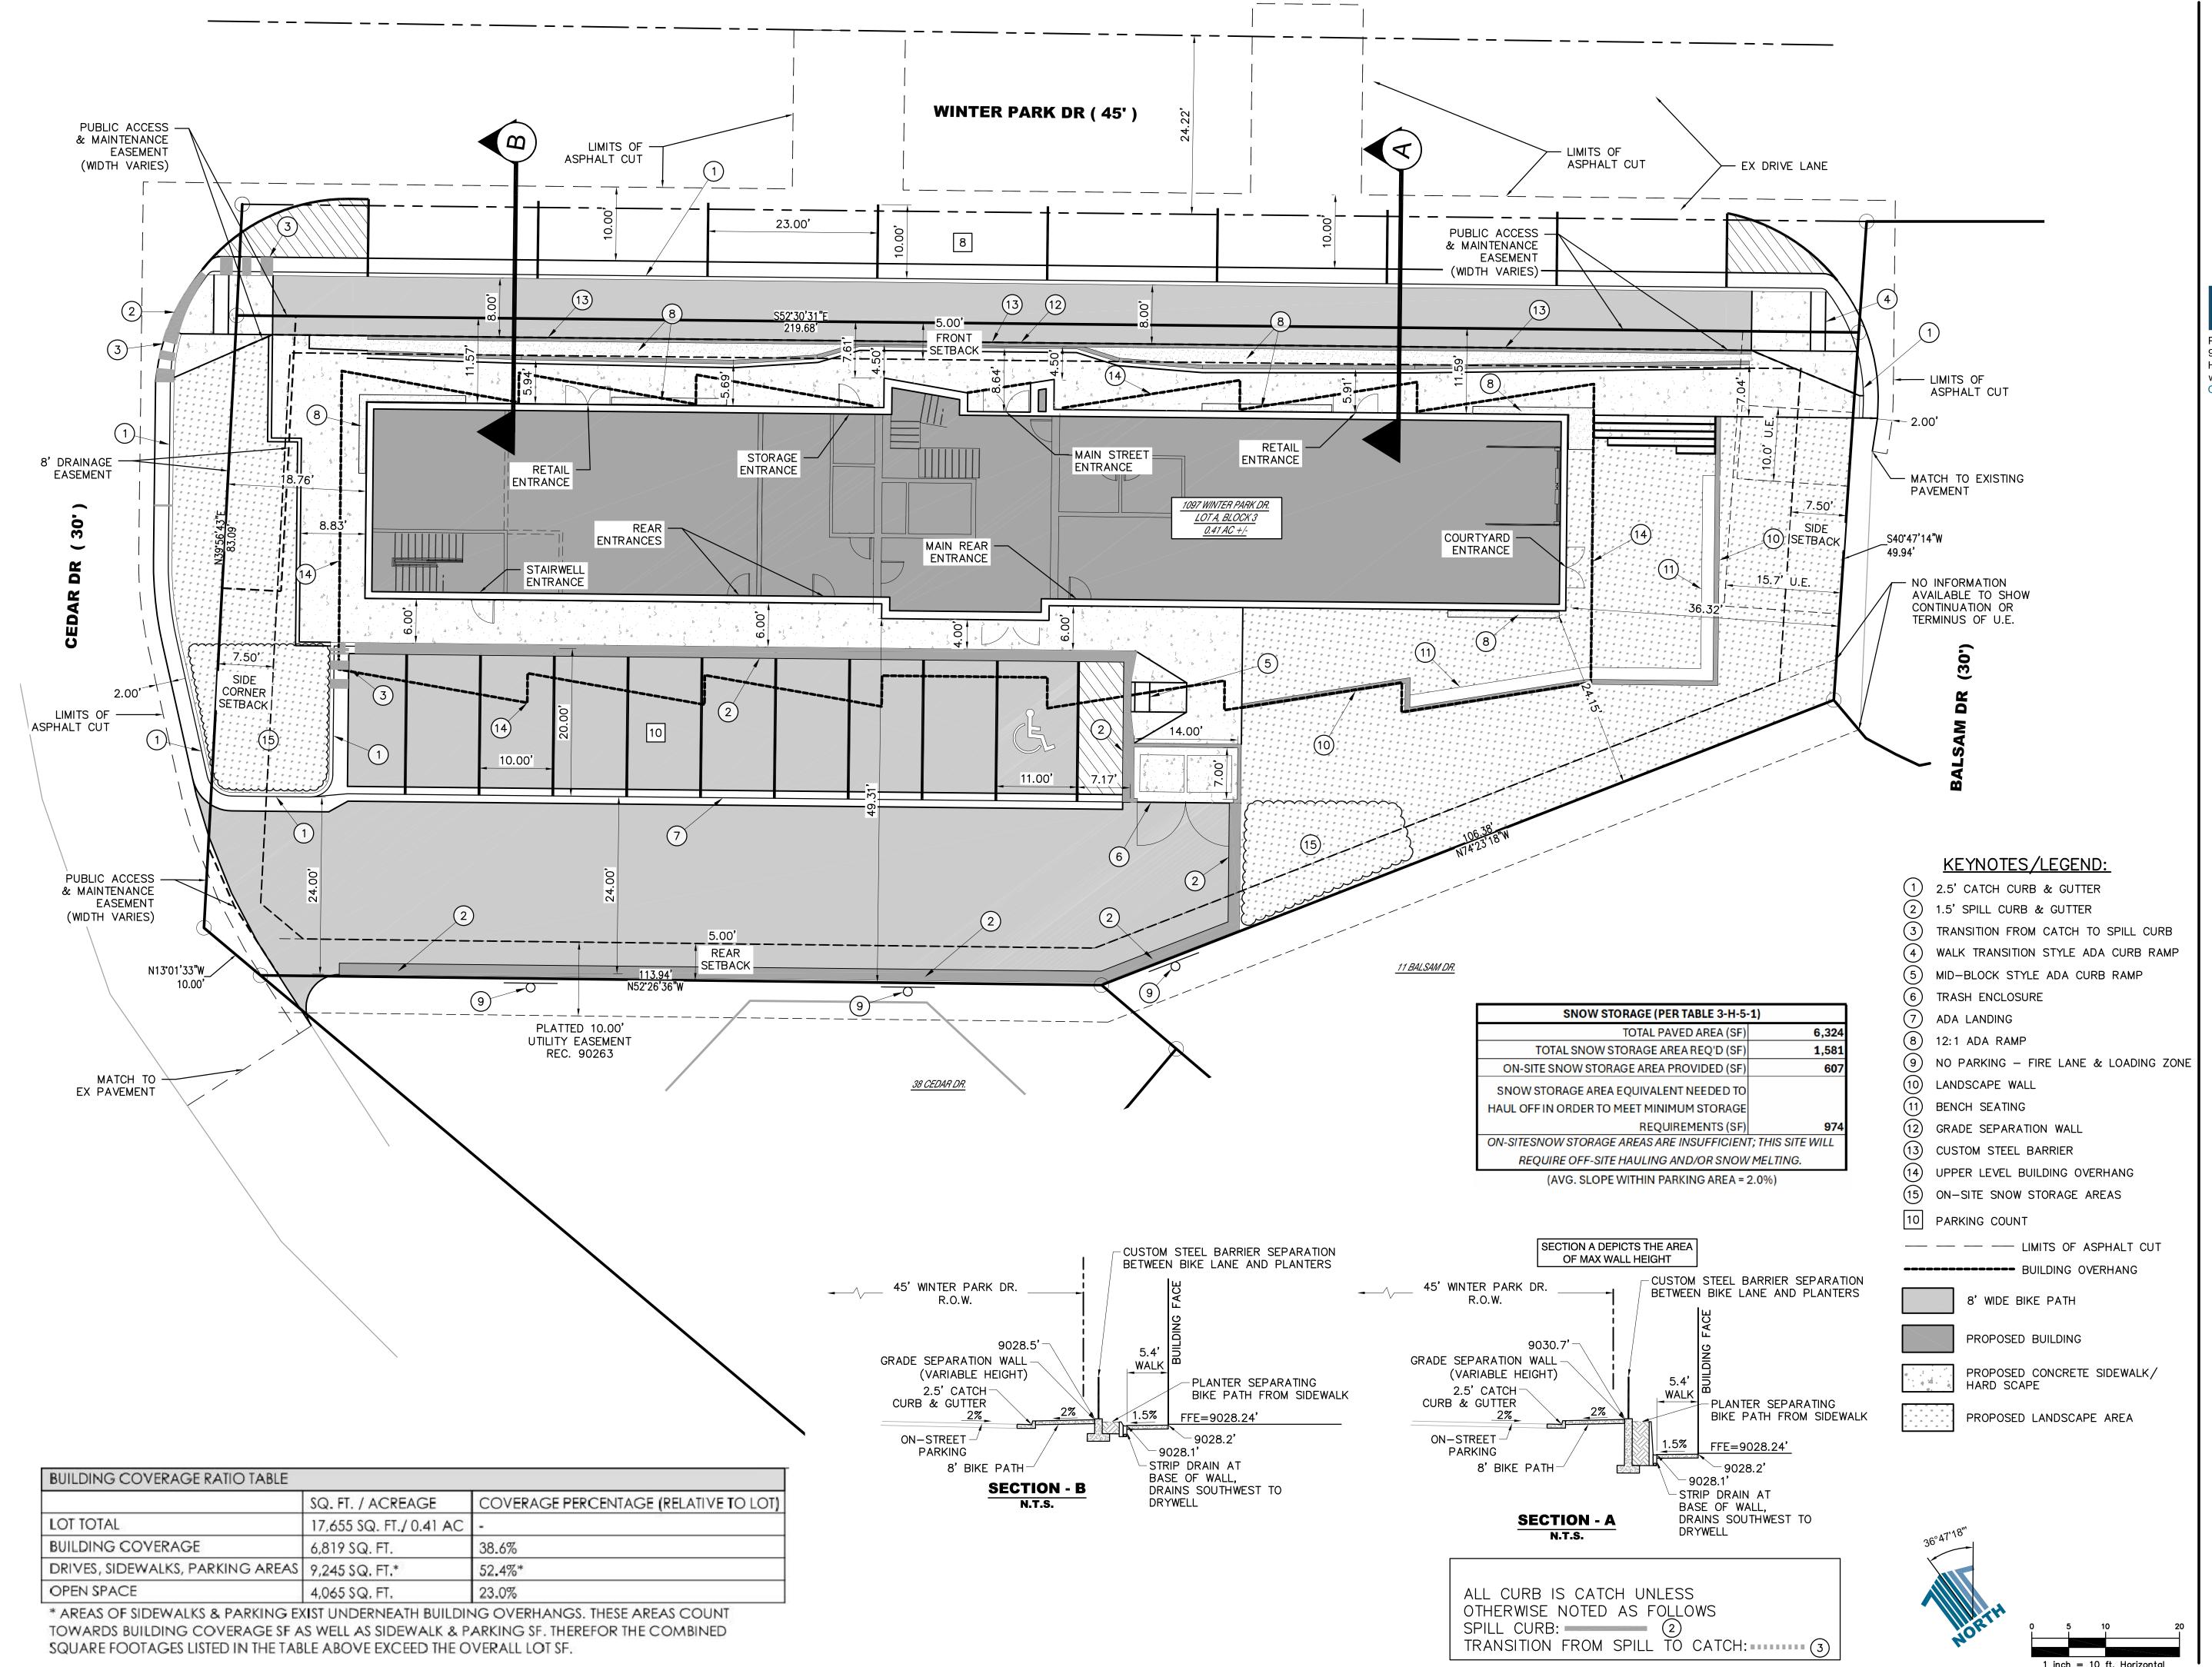

ARCHITECT:

ROTH SHEPPARD ARCHITECTS LLP

1900 WAZEE STREET, SUITE 100 DENVER, COLORADO 80202

т.303.534.7007 **г**.303.534.7722 www.rothsheppard.com

CONSULTANT:

ES Personalized Engineering Solutions

Personalized Engineering Solutions, LLC 9249 S. Broadway #200-388
Highlands Ranch, CO 80129 720.388.8126

www.pengsolutions.com
Construction Management Civil Engineering Land Planning

RK - OLD TOWN LO


1097 Winter Park Drive Winter Park, CO 80482 PROJECT: 2109

ISSUANCE: DATE:

MAJOR SITE PLAN 23-0403
1ST REVISION 24-0822

STAMP:

DRAWING TITLE: SITE PLAN

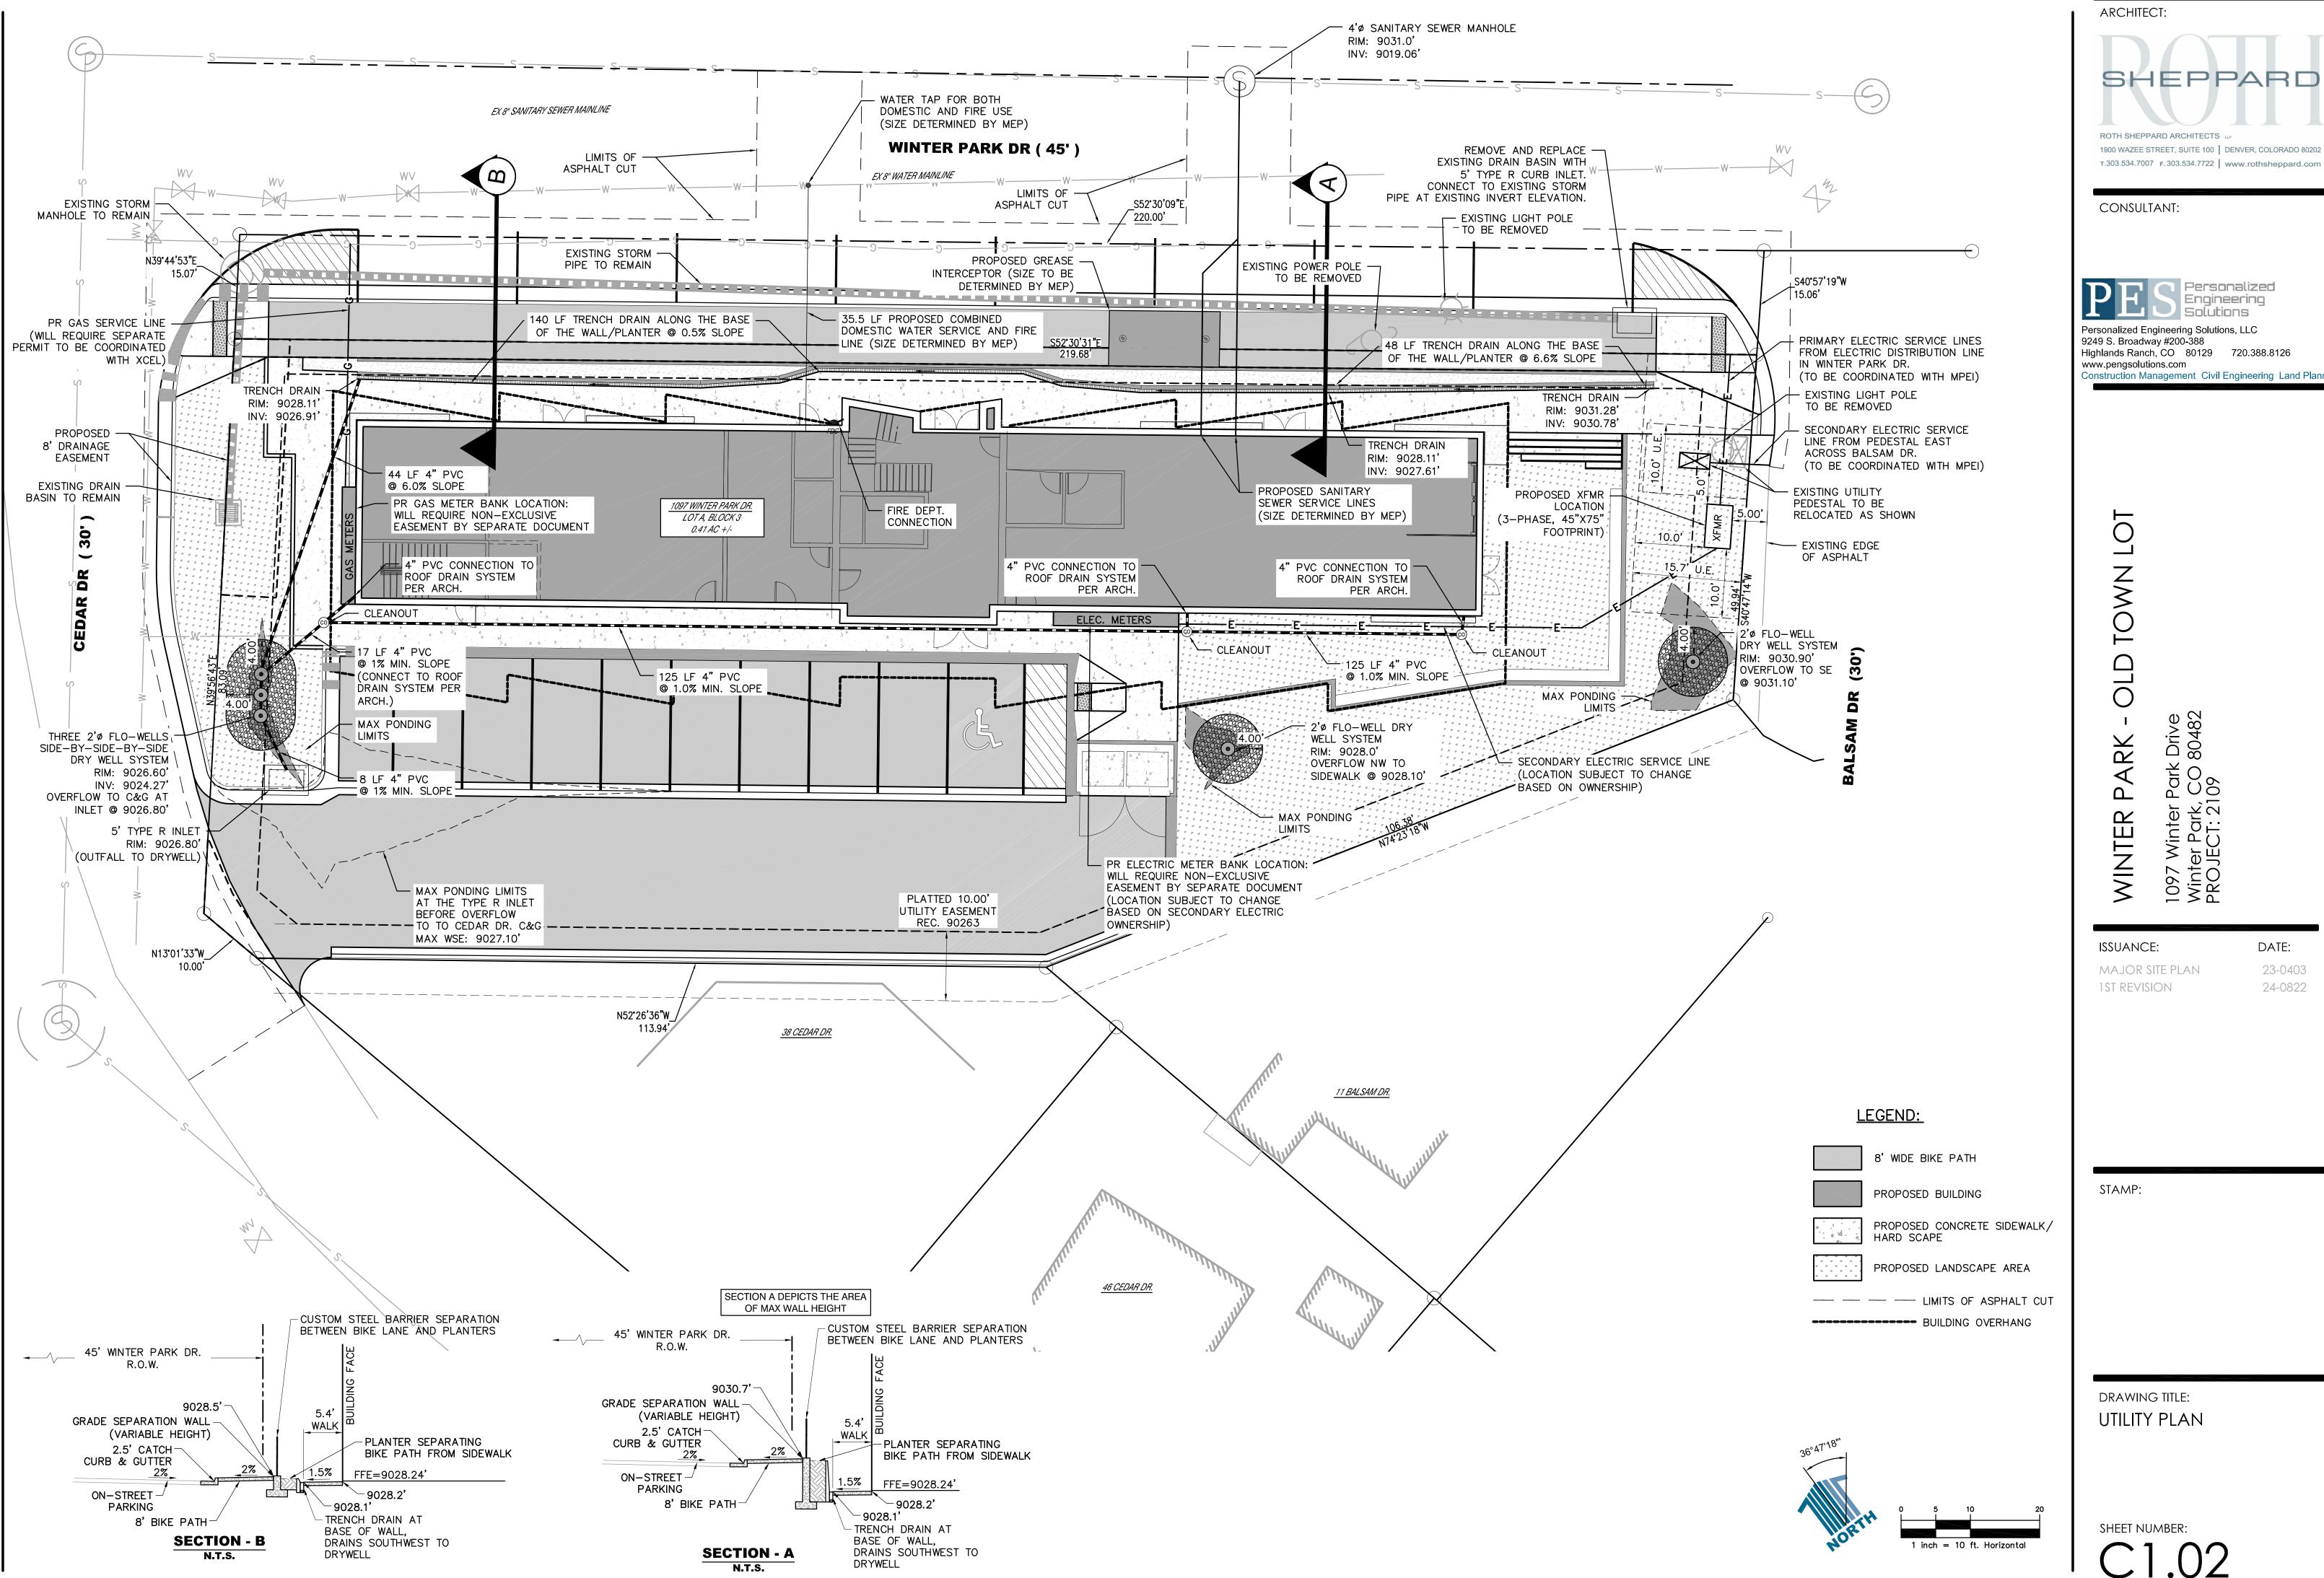

ROTH SHEPPARD ARCHITECTS

Engineering Solutions

Personalized Engineering Solutions, LLC 9249 S. Broadway #200-388 Highlands Ranch, CO 80129 720.388.8126 www.pengsolutions.com

Construction Management Civil Engineering Land Planning


**ISSUANCE:** 

**1ST REVISION** 

23-0403 24-0822

DATE:

DRAWING TITLE:

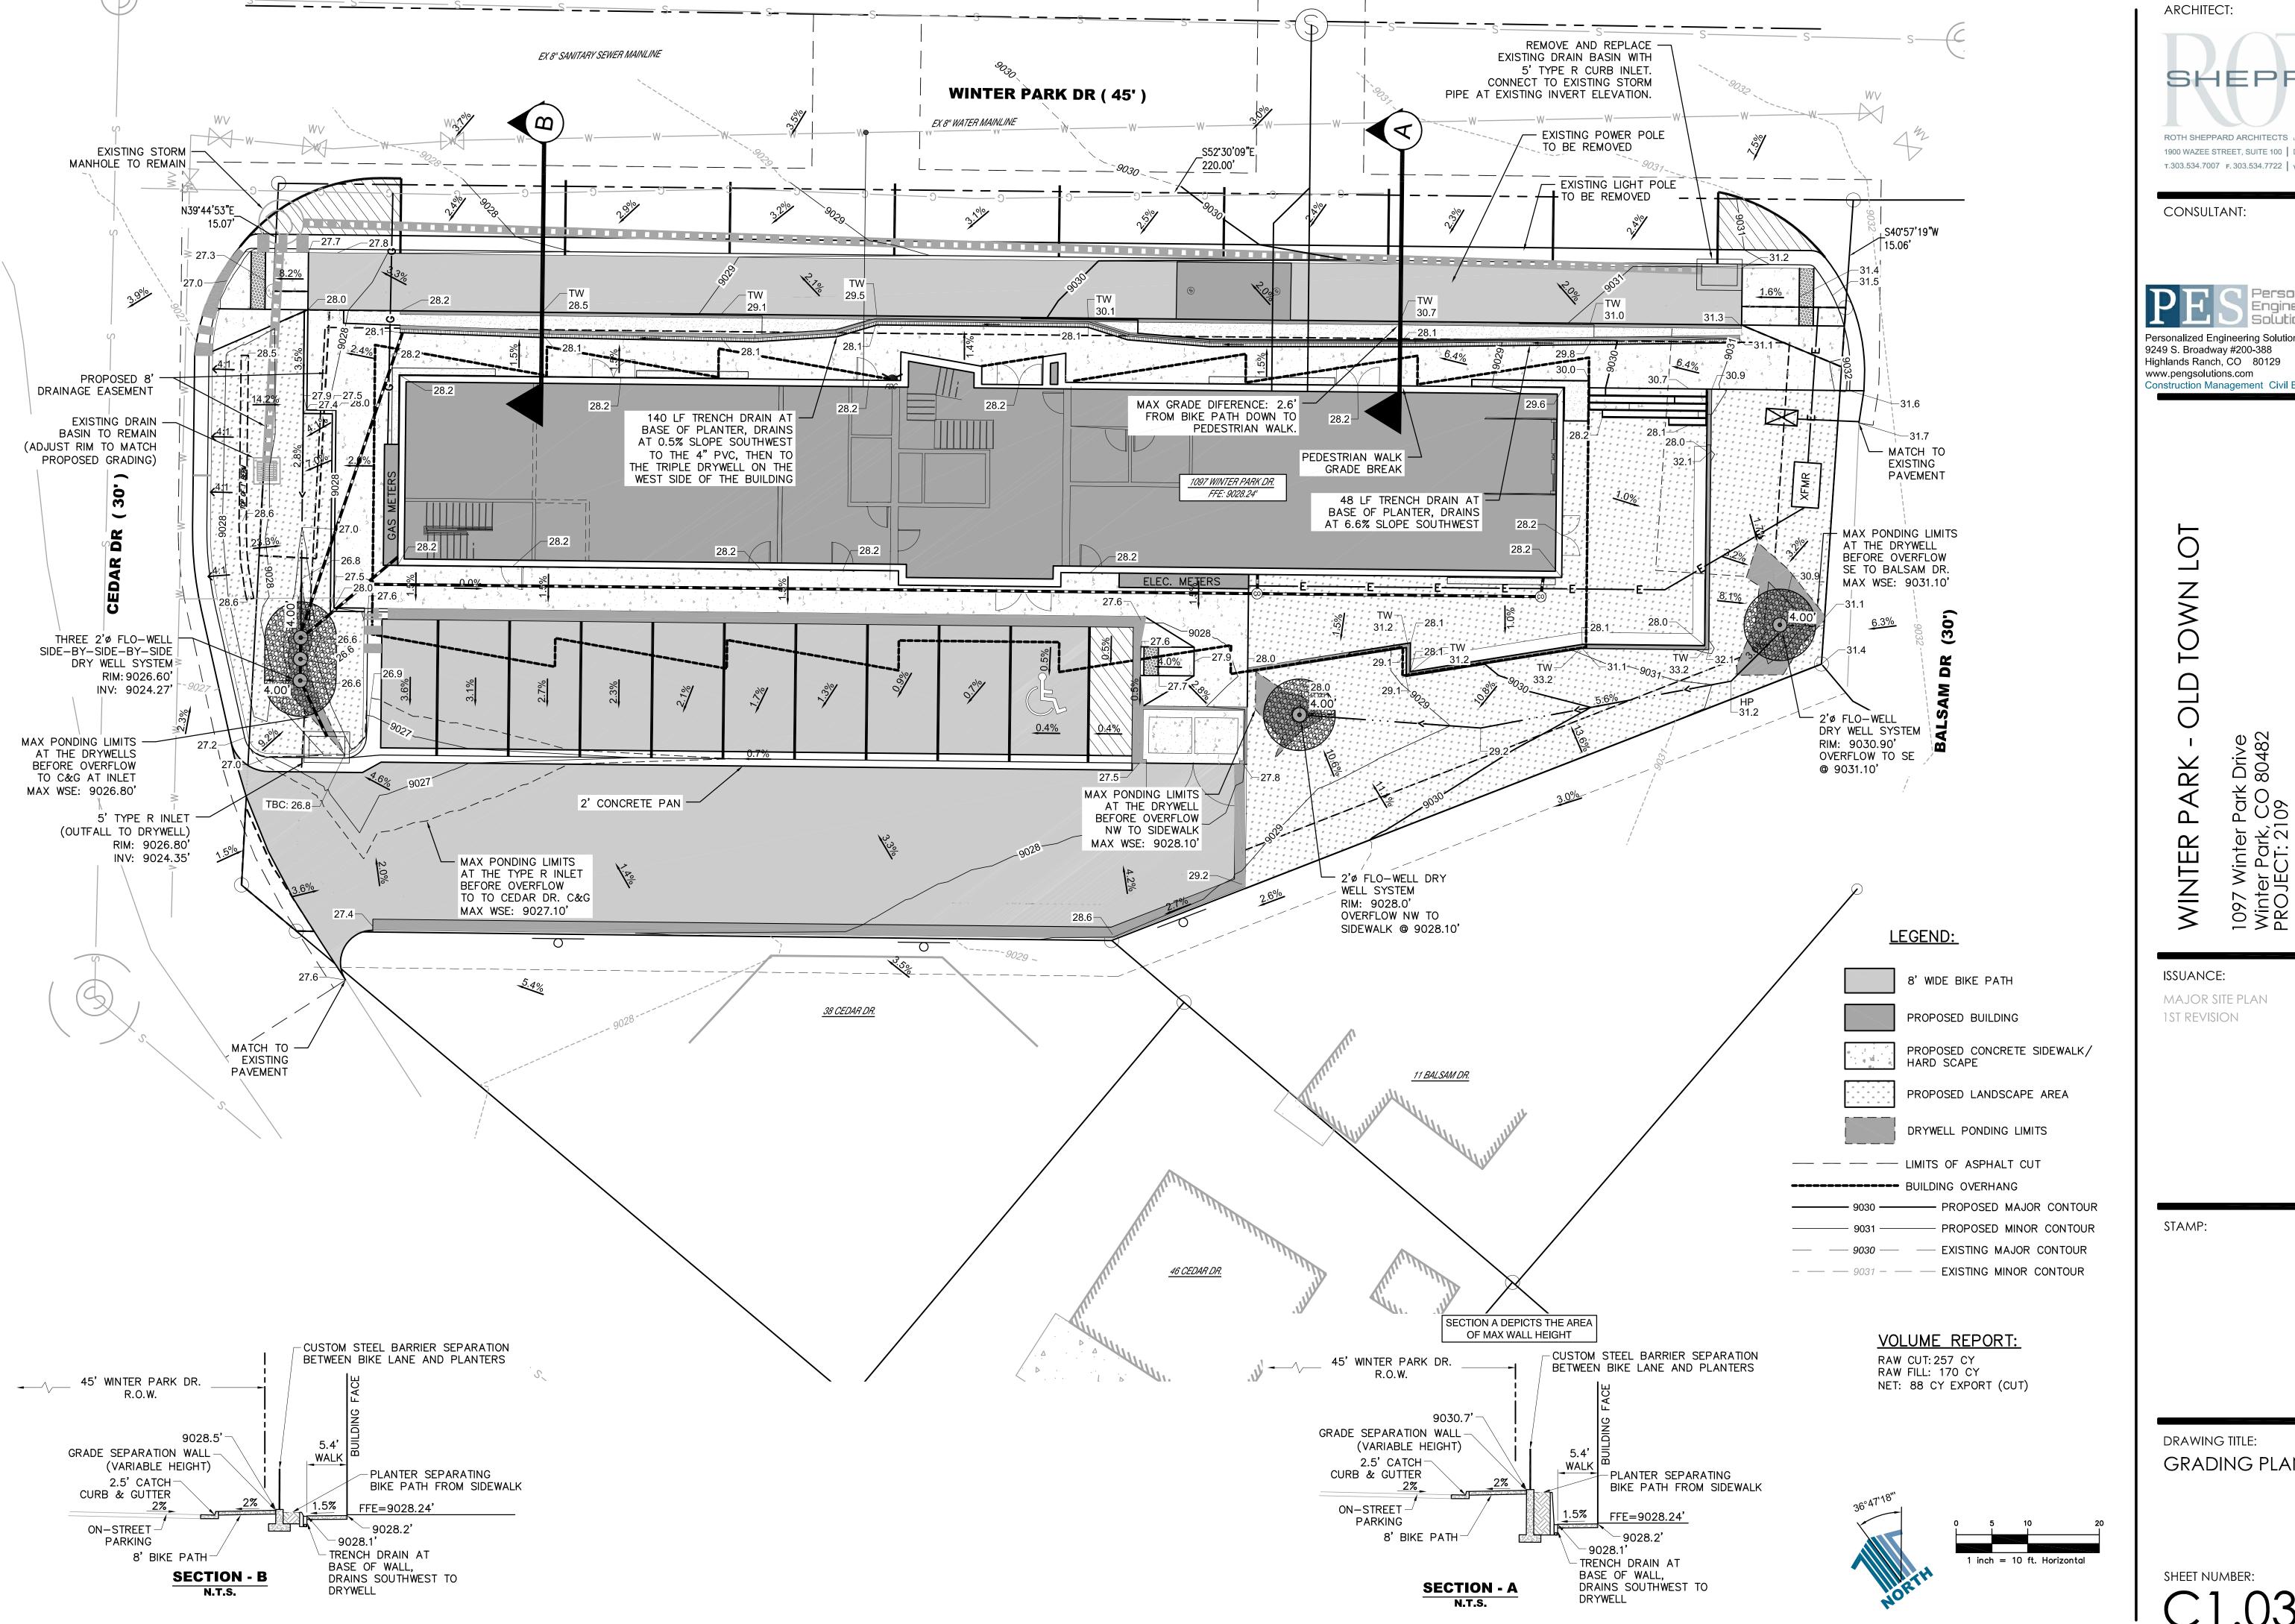

1900 WAZEE STREET, SUITE 100 DENVER, COLORADO 80202 T.303.534.7007 F.303.534.7722 www.rothsheppard.com

Solutions

Personalized Engineering Solutions, LLC Highlands Ranch, CO 80129 720.388.8126

Construction Management Civil Engineering Land Planning

1097 Wint Winter Pa PROJECT:

DATE: 23-0403 24-0822

GRADING PLAN

## **ABBREVIATIONS**

ARV - AIR RELEASE VAC

PCR - POINT OF CURB RETURN

PC - POINT OF CURVATURE PT - POINT OF TANGENCY

STA - STATION

GB - GRADE BREAK FL - FLOWLINE

¢ – CENTERLINE

STM - STORM

RCP - REINFORCED CONCRETE PIPE

TC - TOP OF CURB FES - FLARED END SECTION

EX - EXISTING

ROW - RIGHT OF WAY

EL - ELEVATION

WSE - WATER SURFACE ELEVATION

WQ - WATER QUALITY

WQCV - WATER QUALITY CAPTURE VOLUME



Utility Notification Center of Colorado Administrative Office 303-232-1991

16361 Table Mountain Parkway Golden, Co. 80403 CALL 2 BUSINESS DAYS IN ADVANCE BEFORE YOU DIG,


PERSONALIZED ENGINEERING SOLUTIONS, LLC ASSUMES NO RESPONSIBILITY FOR EXISTING UTILITY LOCATIONS (HORIZONTAL AND VERTICAL). THE EXISTING UTILITIES SHOWN ÒN THIS DRAWING HAVE BEÉN PLOTTED FROM THE BEST AVAILABLE INFORMATION. IT IS, HOWEVER, THE RESPONSIBILITY OF THE CONTRACTOR TO FIELD VERIFY THE LOCATIONS OF ALL UTILITIES PRIOR TO THE COMMENCEMENT OF ANY CONSTRUCTION ACTIVITIES.

GRADE OR EXCAVATE FOR THE MARKING OF

UNDERGROUND MEMBER UTILITIES.

# WINTER PARK OLD TOWN LOT CONSTRUCTION DOCUMENTS

WINTER PARK VILLAGE, BLOCK 3, LOT A **TOWN OF WINTER PARK** GRAND COUNTY, STATE OF COLORADO

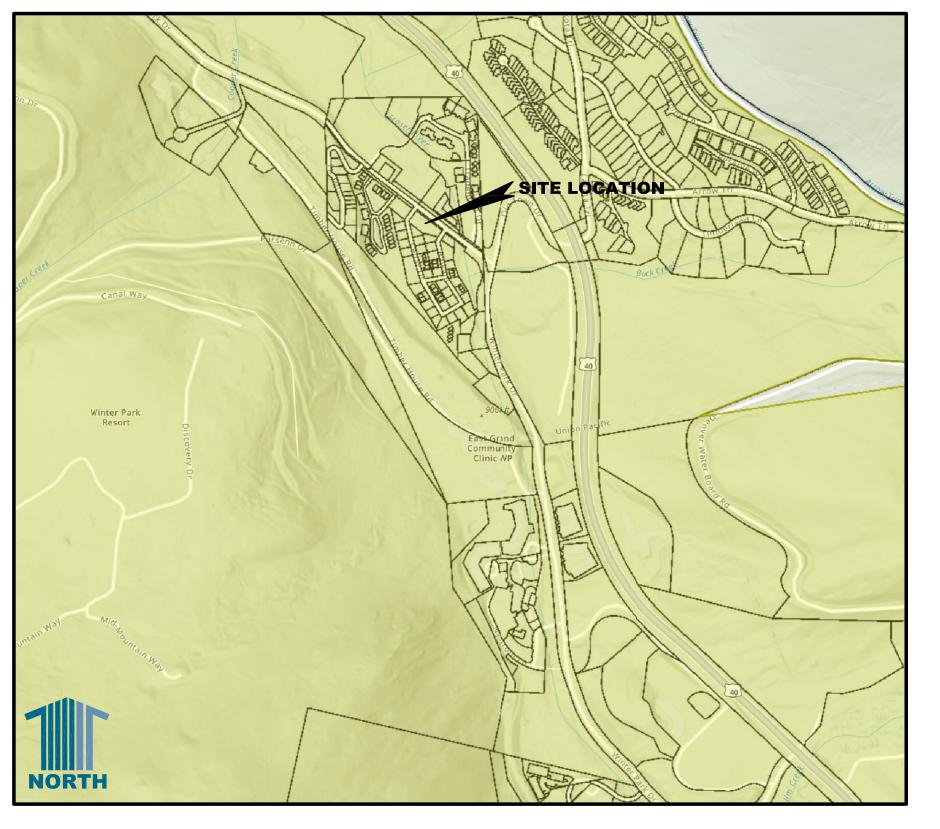

## **VICINITY MAP**

N.T.S.

## **BENCHMARK**

A. - FOUND ALUMINUM CAPPED REBAR STAMPED PLS 2690, DISTURBED. REPLACED AND UPGRADED WITH ALUMINUM CAPPED, 1/2" REBAR STAMPED PLS 25971.

C. - FOUND ALUMINUM CAPPED, %" REBAR STAMPED PLS 31942.

B. - FOUND ALUMINUM CAPPED, 1/2" REBAR STAMPED PLS 25971

D. - SET PLASTIC CAPPED, 1/2" REBAR SCRIBED LS 25971. E. — DENOTES RECORD PLAT DATA DEPICTING THE SAME LINE ON THE GROUND AS RETRACED BY SURVEY.

F. - EXTANT PLSS CORNER NOTED. FOUND 3" DMWW BRASS CAP.

- G. FOUND 3/4" REBAR. APPARENT ORIGINAL MONUMENT.
- H. FOUND PLASTIC CAPPED, 1/2" REBAR STAMPED PLS 25971.
- I. FOUND 3/4" REBAR, APPARENTLY SET BY PLS 35586 FOR "ADOLF'S PARCEL SURVEY, DEPOSITED UNDER LS 2174, COUNTY SURVEYOR INDEX".

## **BASIS OF BEARINGS**

BASIS OF BEARING: ASSUMED S13'01'33"E, ALONG THE WEST BOUNDARY OF LOT 11, BLOCK 3, BETWEEN MONUMENTS SHOWN, DERIVED WITH GPS/RTK.

## **SHEET INDEX**

GN1 (2) GENERAL NOTES DM1 (3) DEMOLITION PLAN

HC1 (4) HORIZONTAL CONTROL PLAN

OU1 (5) OVERALL UTILITY PLAN GRADING PLAN

ADA1 (7) ADA ROUTE

EC1 (8) EROSION CONTROL PLAN DT1 (9) CONSTRUCTION DETAILS

DT2 (10) DRYWELL AND STRIP DRAIN DETAILS

DT3 (11) SWMP DETAILS

11 TOTAL SHEETS

## **KEY CONTACTS**

TOWN OF WINTER PARK JAMES SHOCKEY (970) 726-8081 EXT. 206 <u>OWNER</u> WHITE DEVELOPMENT, LLC DEVIN VISCIANO \_\_\_\_\_ (303) 506-5995 ADAM HARDING, AIA (303) 534-7007 ROTH SHEPPARD ARCHITECTS AHARDING@ROTHSHEPPARD.COM 1900 WAZEE STREET, SUITE 100 DENVER, CO 80202 **ENGINEER** STEPHEN DOUGLAS, P.E. (720) 388-8126 SDOUGLAS@PENGSOLUTIONS.COM PERSONALIZED ENGINEERING SOLUTIONS, LLC 9249 S. BROADWAY #200-388, HIGHLANDS RANCH, CO 80129 **UTILITY NOTIFICATION** UTILITY NOTIFICATION CENTER OF COLORADO \_\_\_\_\_ (800) 922-1987 **SURVEYOR** WARREN WARD (970) 531-1120 ROCKY MOUNTAIN SURVEYS, INC. WWARD1224@COMCAST.NET P.O. BOX 552, WINTER PARK, CO 80482

THESE CONSTRUCTION DOCUMENTS FOR THE WINTER PARK OLD TOWN LOT WERE PREPARED BY ME (OR UNDER MY DIRECT SUPERVISION) IN ACCORDANCE WITH THE REQUIREMENTS OF THE TOWN OF WINTER PARK'S LATEST ADOPTED STANDARDS AND SPECIFICATIONS.

STEPHEN M. DOUGLAS, P.E. REGISTERED LICENSED PROFESSIONAL ENGINEER STATE OF COLORADO No. 41176 FOR AND ON BEHALF OF PERSONALIZED ENGINEERING SOLUTIONS, LLC (720)388-8126

TOWN OF WINTER PARK PLAN REVIEW IS FOR GENERAL CONFORMANCE WITH TOWN OF WINTER PARK STANDARD SPECIFICATIONS FOR DESIGN AND CONSTRUCTION OF PUBLIC IMPROVEMENTS ONLY. THIS ACCEPTANCE DOES NOT RELIEVE THE CONSULTANTS OF ANY LIABILITY FOR ERRORS, OMISSIONS OR VIOLATIONS OF TOWN STANDARDS AND SPECIFICATIONS OR STATE OR FEDERAL GOVERNMENT REGULATIONS. THE TOWN OF WINTER PARK ASSUMES NO RESPONSIBILITY OTHER THAN AS STATED ABOVE FOR COMPLETENESS. THE CONSTRUCTION OF THESE PUBLIC IMPROVEMENTS SHALL BE IN ACCORDANCE WITH THE LATEST ADOPTED STANDARDS AND SPECIFICATIONS.

AUG 2024	ADDRESSING TOWN REVIEW COMMENTS
MARCH 2024	GRADING REVISION: LOWERED BUILDING FFE BY 3'
APRIL 2023	INITIAL CD SUBMITTAL
DATE	REVISION DESCRIPTION

Drawing Name 20T1.dwg				
Job Number				
WP OTL				
Prepared For	Designer	Drafter	Checked	
WHITE DEVELOPMENT	SMD	SN	SMD	



**WINTER PARK - OLD TOWN LOT CONSTRUCTION DOCUMENTS** TITLE SHEET



**APRIL 2023** 

OWNER -PROPERTY OWNER.

CONTRACTOR -AS DETERMINED BY BID.

ENGINEER -PROFESSIONAL ENGINEER OF RECORD.

TOWN OF WINTER PARK -AUTHORIZED REPRESENTATIVE(S) OF THE TOWN OF WINTER PARK ENGINEERING DIVISION AND PUBLIC WORKS DEPARTMENT; THE AGENCY OF JURISDICTION.

CONTRACTOR SHALL HAVE IN CONTRACTOR'S POSSESSION AT ALL TIMES ONE (1) COPY OF CONSTRUCTION DOCUMENTS STAMPED AND SIGNED BY ENGINEER AND TOWN OF WINTER PARK., AND ONE (1) COPY OF THE LATEST EDITION OF THE TOWN OF WINTER PARK STANDARDS AND SPECIFICATIONS.

ALL WORK SHALL COMPLY WITH THE TOWN OF WINTER PARK STANDARDS AND SPECIFICATIONS, LATEST EDITION. THE ENGINEERING DESIGN AND CONCEPT REMAINS THE RESPONSIBILITY OF THE PROFESSIONAL ENGINEER WHOSE STAMP AND SIGNATURE APPEAR ON THE CONSTRUCTION DOCUMENTS. CONTRACTOR SHALL REPORT ANY DISCREPANCIES TO ENGINEER AND TOWN OF WINTER PARK IMMEDIATELY.

#### 2. WORK HOURS

a. ALL WORK ON THE PROJECT SHALL BE PERFORMED DURING REGULAR WORK HOURS, 7:00 A.M. UNTIL 7:00 P.M., MONDAY THROUGH FRIDAY. RESTRICTED HOURS MAY BE INCLUDED WITH CONDITIONS OF THE CITY COUNCIL RESOLUTION APPROVING THE PROJECT, OR WITHIN THE WORK PERMIT. ALL WORK ON THE PROJECT SHALL COMPLY WITH TOWN OF WINTER PARK STANDARDS AND SPECIFICATIONS.

b. CONTRACTOR SHALL NOT PERFORM WORK OUTSIDE REGULAR WORK HOURS OR ON SATURDAY, SUNDAY OR ANY TOWN OF WINTER PARK OBSERVED HOLIDAY WITHOUT RECEIVING WRITTEN CONSENT FROM THE TOWN ENGINEER OR DESIGNATED REPRESENTATIVE. TOWN OF WINTER PARK OBSERVED HOLIDAYS INCLUDE: NEW YEAR'S DAY, MARTIN LUTHER KING DAY, PRESIDENT'S DAY, MEMORIAL DAY, INDEPENDENCE DAY, LABOR DAY, VETERAN'S DAY, THANKSGIVING DAY, FRIDAY FOLLOWING THANKSGIVING, CHRISTMAS EVE, CHRISTMAS DAY. REQUEST FOR WORK OUTSIDE REGULAR WORK HOURS SHALL BE RECEIVED TWO BUSINESS DAYS PRIOR TO THE PROPOSED DATE OF THE WORK. REFER THE TOWN OF WINTER PARK STANDARDS AND SPECIFICATIONS.

#### 3. PRECONSTRUCTION MEETINGS

a. OWNER SHALL SCHEDULE A PRECONSTRUCTION MEETING WITH TOWN OF WINTER PARK ENGINEERING STAFF AT LEAST 3 BUSINESS DAYS PRIOR TO THE START OF CONSTRUCTION. THOSE IN ATTENDANCE SHALL INCLUDE:

- OWNERENGINEER
- TOWN OF WINTER PARK
- CONTRACTOR
- GEOTECHNICAL ENGINEER
- SURVEYORANY OTHER AFFECTED AGENCIES
- b. CONSTRUCTION DOCUMENTS WITH THE TOWN OF WINTER PARK REVIEW STAMP AND SIGNATURE SHALL BE DISTRIBUTED AT THE PRECONSTRUCTION MEETING.
- THERE SHALL BE A SEPARATE ONSITE PRECONSTRUCTION CONFERENCE WITH TOWN OF WINTER PARK PUBLIC WORKS AT LEAST 48 HOURS PRIOR TO CONNECTING TO EXISTING TOWN OF WINTER PARK UTILITIES.
- 4. CONTRACTOR SHALL RESTRICT CONSTRUCTION ACTIVITY TO PUBLIC RIGHT—OF—WAY (R.O.W.) AND AREAS DEFINED AS PERMANENT AND/OR TEMPORARY CONSTRUCTION EASEMENTS, AND AREAS UNDER OWNERSHIP OF OWNER, UNLESS OTHERWISE AUTHORIZED BY THE AFFECTED PROPERTY OWNER AND ACKNOWLEDGED BY THE TOWN OF WINTER PARK. PRIOR TO BEGINNING CONSTRUCTION ACTIVITIES, CONTRACTOR SHALL OBTAIN WRITTEN AGREEMENTS FOR INGRESS AND EGRESS TO THE WORK SITE FROM ADJACENT PRIVATE PROPERTY OWNERS. ACCESS TO ANY ADJACENT PRIVATE PROPERTY SHALL BE MAINTAINED THROUGHOUT THE CONSTRUCTION PERIOD.
- 5. CONTRACTOR SHALL VERIFY ACCURACY BETWEEN WORK SET FORTH ON THESE CONSTRUCTION DOCUMENTS AND WORK REQUIRED IN THE FIELD. ANY DISCREPANCIES SHALL BE BROUGHT TO THE ATTENTION OF ENGINEER AND THE TOWN OF WINTER PARK PRIOR TO START OF CONSTRUCTION.
- 6. ENGINEER SHALL COORDINATE ANY PROPOSED CHANGES WITH THE TOWN OF WINTER PARK.
- 7. CONTRACTOR SHALL BE RESPONSIBLE FOR THE FOLLOWING NOTIFICATIONS:
- a. UTILITY NOTIFICATION CENTER OF COLORADO, 1-800-922-1987. CALL TWO (2) BUSINESS
  DAYS PRIOR (NOT INCLUDING THE DAY OF THE CALL) TO DIGGING, GRADING OR EXCAVATING FOR
  THE MARKING OF UNDERGROUND MEMBER UTILITIES.
- LOCATION OF EXISTING UTILITIES SHALL BE VERIFIED BY CONTRACTOR PRIOR TO CONSTRUCTION. CONTRACTOR SHALL BE RESPONSIBLE FOR LOCATION, SUPPORT, PROTECTION AND RESTORATION OF ALL EXISTING UTILITIES AND APPURTENANCES, WHETHER SHOWN OR NOT SHOWN ON THE APPROVED CONSTRUCTION DOCUMENTS.
- ii. PROVIDING NOTIFICATION AND RECEIVING MARKINGS OF UNDERGROUND MEMBER
- UTILITIES IN NO WAY CONSTITUTES PERMISSION TO PERFORM CONSTRUCTION.

  UTILITY NOTIFICATION CENTER OF COLORADO AT 1-800-922-1987 FOR LOCATES OF EXISTING TOWN OF WINTER PARK UTILITIES,
- INCLUDING POTABLE AND NON-POTABLE WATERLINES, SANITARY SEWER LINES, STORM SEWER LINES, PUBLIC IRRIGATION LINES AND TRAFFIC CONTROL DEVICES. CALL TWO BUSINESS DAYS (48 HOURS) PRIOR (NOT INCLUDING THE DAY OF THE CALL) TO THE START OF CONSTRUCTION. LOCATION OF EXISTING UTILITIES SHALL BE VERIFIED BY CONTRACTOR PRIOR TO CONSTRUCTION.
- c. THE TOWN OF WINTER PARK UTILITY CUSTOMERS FOR POTENTIAL SERVICE OUTAGES AND COORDINATION
- WITH THE TOWN OF WINTER PARK PUBLIC WORKS FOR DETERMINATION OF MINIMUM TIME REQUIREMENT. THE TOWN OF WINTER PARK PUBLIC WORKS SHALL BE NOTIFIED TWO BUSINESS
- DAYS (48 HOURS) IN ADVANCE TO SCHEDULE AN OUTAGE.

  d. THE TOWN OF WINTER PARK 24 HOURS IN ADVANCE FOR OBSERVATIONS OF WORK IN PROGRESS.

  OBSERVATION AND ONSITE VISITS ARE NOT TO BE CONSTRUED AS A GUARANTEE OR APPROVAL BY

  THE TOWN OF WINTER PARK STAFF OF CONTRACTOR'S WORK OR CONTRACTUAL COMMITMENT. IF

  WORK IS SUSPENDED FOR LONGER THAN 5 DAYS AFTER INITIAL START—UP, CONTRACTOR

  SHALL NOTIFY THE TOWN OF WINTER PARK CONSTRUCTION INSPECTION SUPERVISOR ONE (1)
- BUSINESS DAYS (24 HOURS) PRIOR TO RESTART OF CONSTRUCTION.

  e. THE TOWN OF WINTER PARK OFFICE IN THE EVENT OF AN EMERGENCY, AT (970) 725-3549

  DURING REGULAR WORK HOURS OR (970) 722-7779 AFTER HOURS.
- 8. FOR DEVELOPMENT WORK, OWNER SHALL OBTAIN AT OWNER'S EXPENSE, ALL PERMITS NECESSARY TO PERFORM THE PROPOSED WORK.
- ONTRACTOR SHALL BE RESPONSIBLE FOR ALL TRAFFIC CONTROL DURING CONSTRUCTION:

  CONTRACTOR SHALL SUBMIT TRAFFIC CONTROL PLANS TO THE TOWN OF WINTER PARK FOR

- PRIOR TO CONSTRUCTION.
- b. ALL SIGNS, STRIPING AND TRAFFIC CONTROL DEVICES SHALL CONFORM TO AND PLACEMENT SHALL BE PERFORMED IN ACCORDANCE WITH THE MANUAL ON UNIFORM TRAFFIC CONTROL DEVICES LATEST EDITION AND CDOT M&S STANDARDS, LATEST EDITION.
- c. CONTRACTOR SHALL BE RESPONSIBLE FOR MAINTENANCE AND CLEANING OF TRAFFIC CONTROL DEVICES.
- d. CONTRACTOR SHALL MAINTAIN EXISTING PAVEMENT MARKINGS DURING CONSTRUCTION OPERATIONS, IN CONFORMANCE WITH THE CONSTRUCTION DOCUMENTS AND THE TOWN OF WINTER PARK STANDARDS AND SPECIFICATIONS.
- e. REMOVAL OF EXISTING PAVEMENT MARKINGS SHALL BE ACCOMPLISHED BY A METHOD THAT DOES NOT MATERIALLY DAMAGE THE SURFACE OR TEXTURE OF THE PAVEMENT OR EXISTING SURFACING. THE PAVEMENT MARKINGS SHALL BE REMOVED TO THE EXTENT THAT THEY ARE NOT VISIBLE UNDER DAY OR NIGHT CONDITIONS.
- 10. WHEN DISCHARGING GROUNDWATER, ALL DEWATERING METHODS SHALL BE IN CONFORMANCE WITH ALL LAWS AND REGULATIONS OF THE STATE—INCLUDING OBTAINING A COLORADO DISCHARGE PERMIT SYSTEM FOR CONSTRUCTION DEWATERING WASTEWATER DISCHARGE—AND SUBJECT TO THE APPROVAL OF THE TOWN OF WINTER PARK. CONTRACTOR SHALL TAKE ALL NECESSARY AND PROPER PRECAUTIONS TO PROTECT ADJACENT PROPERTIES FROM ANY AND ALL DAMAGE THAT MAY OCCUR
  FROM STORMWATER RUNOFF AND/OR DEPOSITION OF DEBRIS RESULTING FROM ANY AND ALL WORK.
- 11. CONTRACTOR SHALL RESTORE ANY DISTURBED AREAS TO EQUAL OR BETTER CONDITION THAN EXISTED BEFORE CONSTRUCTION. DRAINAGE DITCHES OR WATERCOURSES THAT ARE DISTURBED BY CONSTRUCTION SHALL BE RESTORED TO THE GRADES AND CROSS—SECTIONS THAT EXISTED BEFORE CONSTRUCTION, UNLESS OTHERWISE SHOWN ON THE CONSTRUCTION DOCUMENTS.
- 12. CONTRACTOR SHALL CAREFULLY PRESERVE BENCHMARKS, PROPERTY CORNERS, REFERENCE POINTS, STAKES AND OTHER SURVEY REFERENCE MONUMENTS OR MARKERS. IN CASES OF WILLFUL OR CARELESS DESTRUCTION, CONTRACTOR SHALL BE RESPONSIBLE FOR RESTORATIONS. RESETTING OF MARKERS SHALL BE PERFORMED UNDER THE DIRECTION OF A COLORADO LICENSED PROFESSIONAL LAND SURVEYOR AND AS APPROVED BY THE TOWN OF WINTER PARK.
- 13. CONTRACTOR SHALL IMMEDIATELY REMOVE ANY CONSTRUCTION DEBRIS AND MUD TRACKED ONTO EXISTING ROADWAYS. CONTRACTOR SHALL REPAIR ANY EXCAVATION OR PAVEMENT FAILURES CAUSED BY THE CONSTRUCTION.
- 14. CONTRACTOR SHALL BE RESPONSIBLE FOR COMPLYING WITH ALL STATE AND TOWN OF WINTER PARK DUST AND EROSION CONTROL ORDINANCES. CONSTRUCTION VEHICLES SHALL USE TRUCK ROUTES DESIGNATED BY THE TOWN OF WINTER PARK.
- 15. ALL CONCRETE AND ASPHALT MIXTURE DESIGNS SHALL BE APPROVED BY THE TOWN OF WINTER PARK PRIOR TO PLACEMENT OF CONCRETE AND ASPHALT.
- 16. WORK IN PUBLIC STREETS SHALL BE PERFORMED IN A MANNER THAT PROVIDES MINIMUM INCONVENIENCE TO ADJACENT PROPERTY OWNERS AND THE GENERAL PUBLIC.
- 17. ALL PAVEMENT CUTS AND EXPLORATORY POTHOLES SHALL BE REPAIRED AS REQUIRED BY THE TOWN OF WINTER PARK.
- 18. NO ROADWAY SHALL BE OPEN CUT UNLESS APPROVED BY THE TOWN OF WINTER PARK.
- 19. OWNER SHALL SUBMIT A PAPER COPY OF REDLINED RECORD CONSTRUCTION DOCUMENTS TO THE TOWN OF WINTER PARK PRIOR TO THE CONSTRUCTION ACCEPTANCE INSPECTION. REFER TO THE THE TOWN OF WINTER PARK STANDARDS AND SPECIFICATIONS FOR ADDITIONAL RECORD DOCUMENT SUBMITTAL REQUIREMENTS.
- 20. PRIOR TO CONSTRUCTION ACCEPTANCE, SURVEYOR SHALL SUBMIT A PLAN OF PROPOSED LOCATIONS FOR INSTALLATION OF RANGE POINTS TO THE TOWN OF WINTER PARK FOR APPROVAL. RANGE POINTS SHALL BE SET IN ACCORDANCE WITH THE REQUIREMENTS OF ARTICLES 51 AND 53 OF TITLE 38 OF THE COLORADO REVISED STATUTES, AND AS REQUIRED BY THE BYLAWS AND RULES OF PROCEDURE OF THE COLORADO STATE BOARD OF REGISTRATION FOR PROFESSIONAL ENGINEERS AND PROFESSIONAL LAND SURVEYORS. RANGE POINTS SHALL BE SET IN VALVE BOXES THAT COMPLY WITH THE TOWN OF WINTER PARK STANDARDS AND SPECIFICATIONS WITH BOX LIDS MARKED "SURVEY POINT", OR AS OTHERWISE APPROVED BY THE TOWN ENGINEER.
- 21. TRASH ENCLOSURES AND SERVICE AREAS WILL BE EFFECTIVELY SCREENED THROUGH THE USE OF LANDSCAPE MATERIALS AND SCREEN WALLS OF MATERIALS AND COLORS TO MATCH THE BUILDING ARCHITECTURE
- 22. ELECTRICAL DISTRIBUTION PANELS WILL BE CONTAINED WITHIN THE BUILDING, SERVICE ENCLOSURES OR SCREENED PERMANENTLY FROM VIEW.
- 23. GAS METERS WILL BE PERMANENTLY SCREENED FROM VIEW AND PAINTED TO MATCH THE BUILDING.
- 24. LIGHT SOURCES WILL BE CONCEALED FROM VIEW AND THERE WILL BE NO LIGHT GLARE SPILLOVER BEYOND THE PROPERTY LINE. PARKING LOT LIGHTING SHALL BE CONTROLLED BY AUTOMATIC TIMERS PROGRAMMED TO SHUT OFF DAILY AT 11PM MINIMUM. THE PARKING LOT LIGHTING MAY REMAIN IN USE ON A LIMITED TIME BASIS.
- 25. ALL BUILDINGS, PARKING, AND LANDSCAPING WILL COMPLY WITH SIGHT TRIANGLES AT INTERSECTIONS.
- 26. ALL FUTURE ROW, DRAINAGE EASEMENTS, SHARED ACCESS, AND TRAIL EASEMENTS ARE TO BE DEDICATED BY A SEPARATE INSTRUMENT.
- 27. ALL WORK RELATED TO THE EXISTING WATER MAINS IN WINTER PARK DRIVE AND CEDAR DRIVE; AND THE NEW FIRE AND DOMESTIC WATER SERVICE TO THE BUILDING SHALL BE DONE IN ACCORDANCE WITH WINTER PARK WATER AND SANITATION DISTRICT RULES AND REGULATIONS AND WITH PRIOR COORDINATION WITH WPWSD STAFF.
- 28. ALL WORK RELATED TO THE EXISTING SEWER IN WINTER PARK DRIVE AND CEDAR DRIVE; AND THE SEWER SERVICE TO THE BUILDING SHALL BE DONE IN ACCORDANCE WITH WINTER PARK WATER AND SANITATION DISTRICT RULES AND REGULATIONS AND WITH PRIOR COORDINATION WITH WPWSD STAFF

### **PLAT NOTES:**

- WITH RESPECT TO THE ELECTRIC UTILITY EASEMENT GRANTED HEREBY, NO STRUCTURE SHALL BE ALLOWED CLOSER THAN TEN FEET (10') FROM ANY PRIMARY VOLTAGE POWER LINES OR WITHIN TEN FEET (10') AROUND ANY ABOVE GROUND EQUIPMENT. NO OTHER UTILITY LINE (WHETHER GAS, WATER, SEWER OR OTHER UTILITY) SHALL BE ALLOWED CLOSER THAN FIVE FEET (5') FROM ANY PRIMARY VOLTAGE POWER LINES OR WITHIN FIVE FEET (5') AROUND ANY ABOVE GROUND EQUIPMENT. NOTWITHSTANDING THE FOREGOING, UNDERGROUND COMMUNICATION FACILITIES SHALL NOT BE ALLOWED CLOSER THAN ONE FOOT (1') TO ANY POWER LINES AND ABOVE GROUND COMMUNICATION FACILITIES SHALL NOT BE CLOSER THAN TWO FEET (2') TO ANY ABOVE GROUND ELECTRIC FACILITIES. NO GRADE CHANGES (FILL OR CUT) IN EXCESS OF SIX INCHES (6") ARE PERMITTED WITHIN TEN FEET (10') OF ANY PRIMARY ELECTRIC LINE OR WITHIN FIVE FEET (5') OF ANY OTHER FACILITY, INCLUDING SECONDARY ELECTRIC LINES, WITHOUT PRIOR WRITTEN AUTHORIZATION FROM MOUNTAIN PARKS ELECTRIC, INC.
- EACH TOWNHOME, DUPLEX, MULTI-FAMILY OR MULTI-USE BUILDING ON THE PROPERTY SHALL HAVE GAS METERS ON THE GABLE END OF ONE (1) END UNIT ("GAS METER BANK"). DEVELOPER, FUTURE HOME OWNER, OR METRO DISTRICT HEREBY GRANTS TO XCEL (PSCO) A NON-EXCLUSIVE UTILITY EASEMENT FOR (I) ONE GAS METER BANK ON THE END OF ONE (1) END UNIT PER BUILDING AND (II) ALL OTHER THINGS REASONABLY NECESSARY TO CONSTRUCT, INSTALL, MAINTAIN AND OPERATE SUCH GAS METER BANK ON EACH OF THE BUILDINGS (THE "GAS METERING EASEMENT"). ALL LINES AND OTHER FACILITIES RELATED TO SUCH GAS METER BANK, SUCH AS METER RISERS (BUT NOT INDIVIDUAL GAS METERS), SHALL BE THE PROPERTY OF XCEL (PSCO). ALL OF THE FOREGOING RIGHTS AND BENEFITS OF XCEL (PSCO) WITH RESPECT TO THE GAS METERING EASEMENT SHALL BE BINDING UPON AND SHALL INURE TO THE BENEFIT OF SUCCESSORS AND ASSIGNS.

AUG 2024 ADDRESSING TOWN REVIEW COMMENTS

MARCH 2024 GRADING REVISION: LOWERED BUILDING FFE BY 3'

APRIL 2023 INITIAL CD SUBMITTAL

DATE REVISION DESCRIPTION

Drawing Name
20GN.dwg

Job Number

WP OTL

Prepared For

WHITE DEVELOPMENT

Designer

SMD

SN

SMD

Personalized Engineering Solutions


Personalized Engineering Solutions, LLC 9249 S. Broadway #200-388


Highlands Ranch, CO 80129 720.388.8126 www.pengsolutions.com


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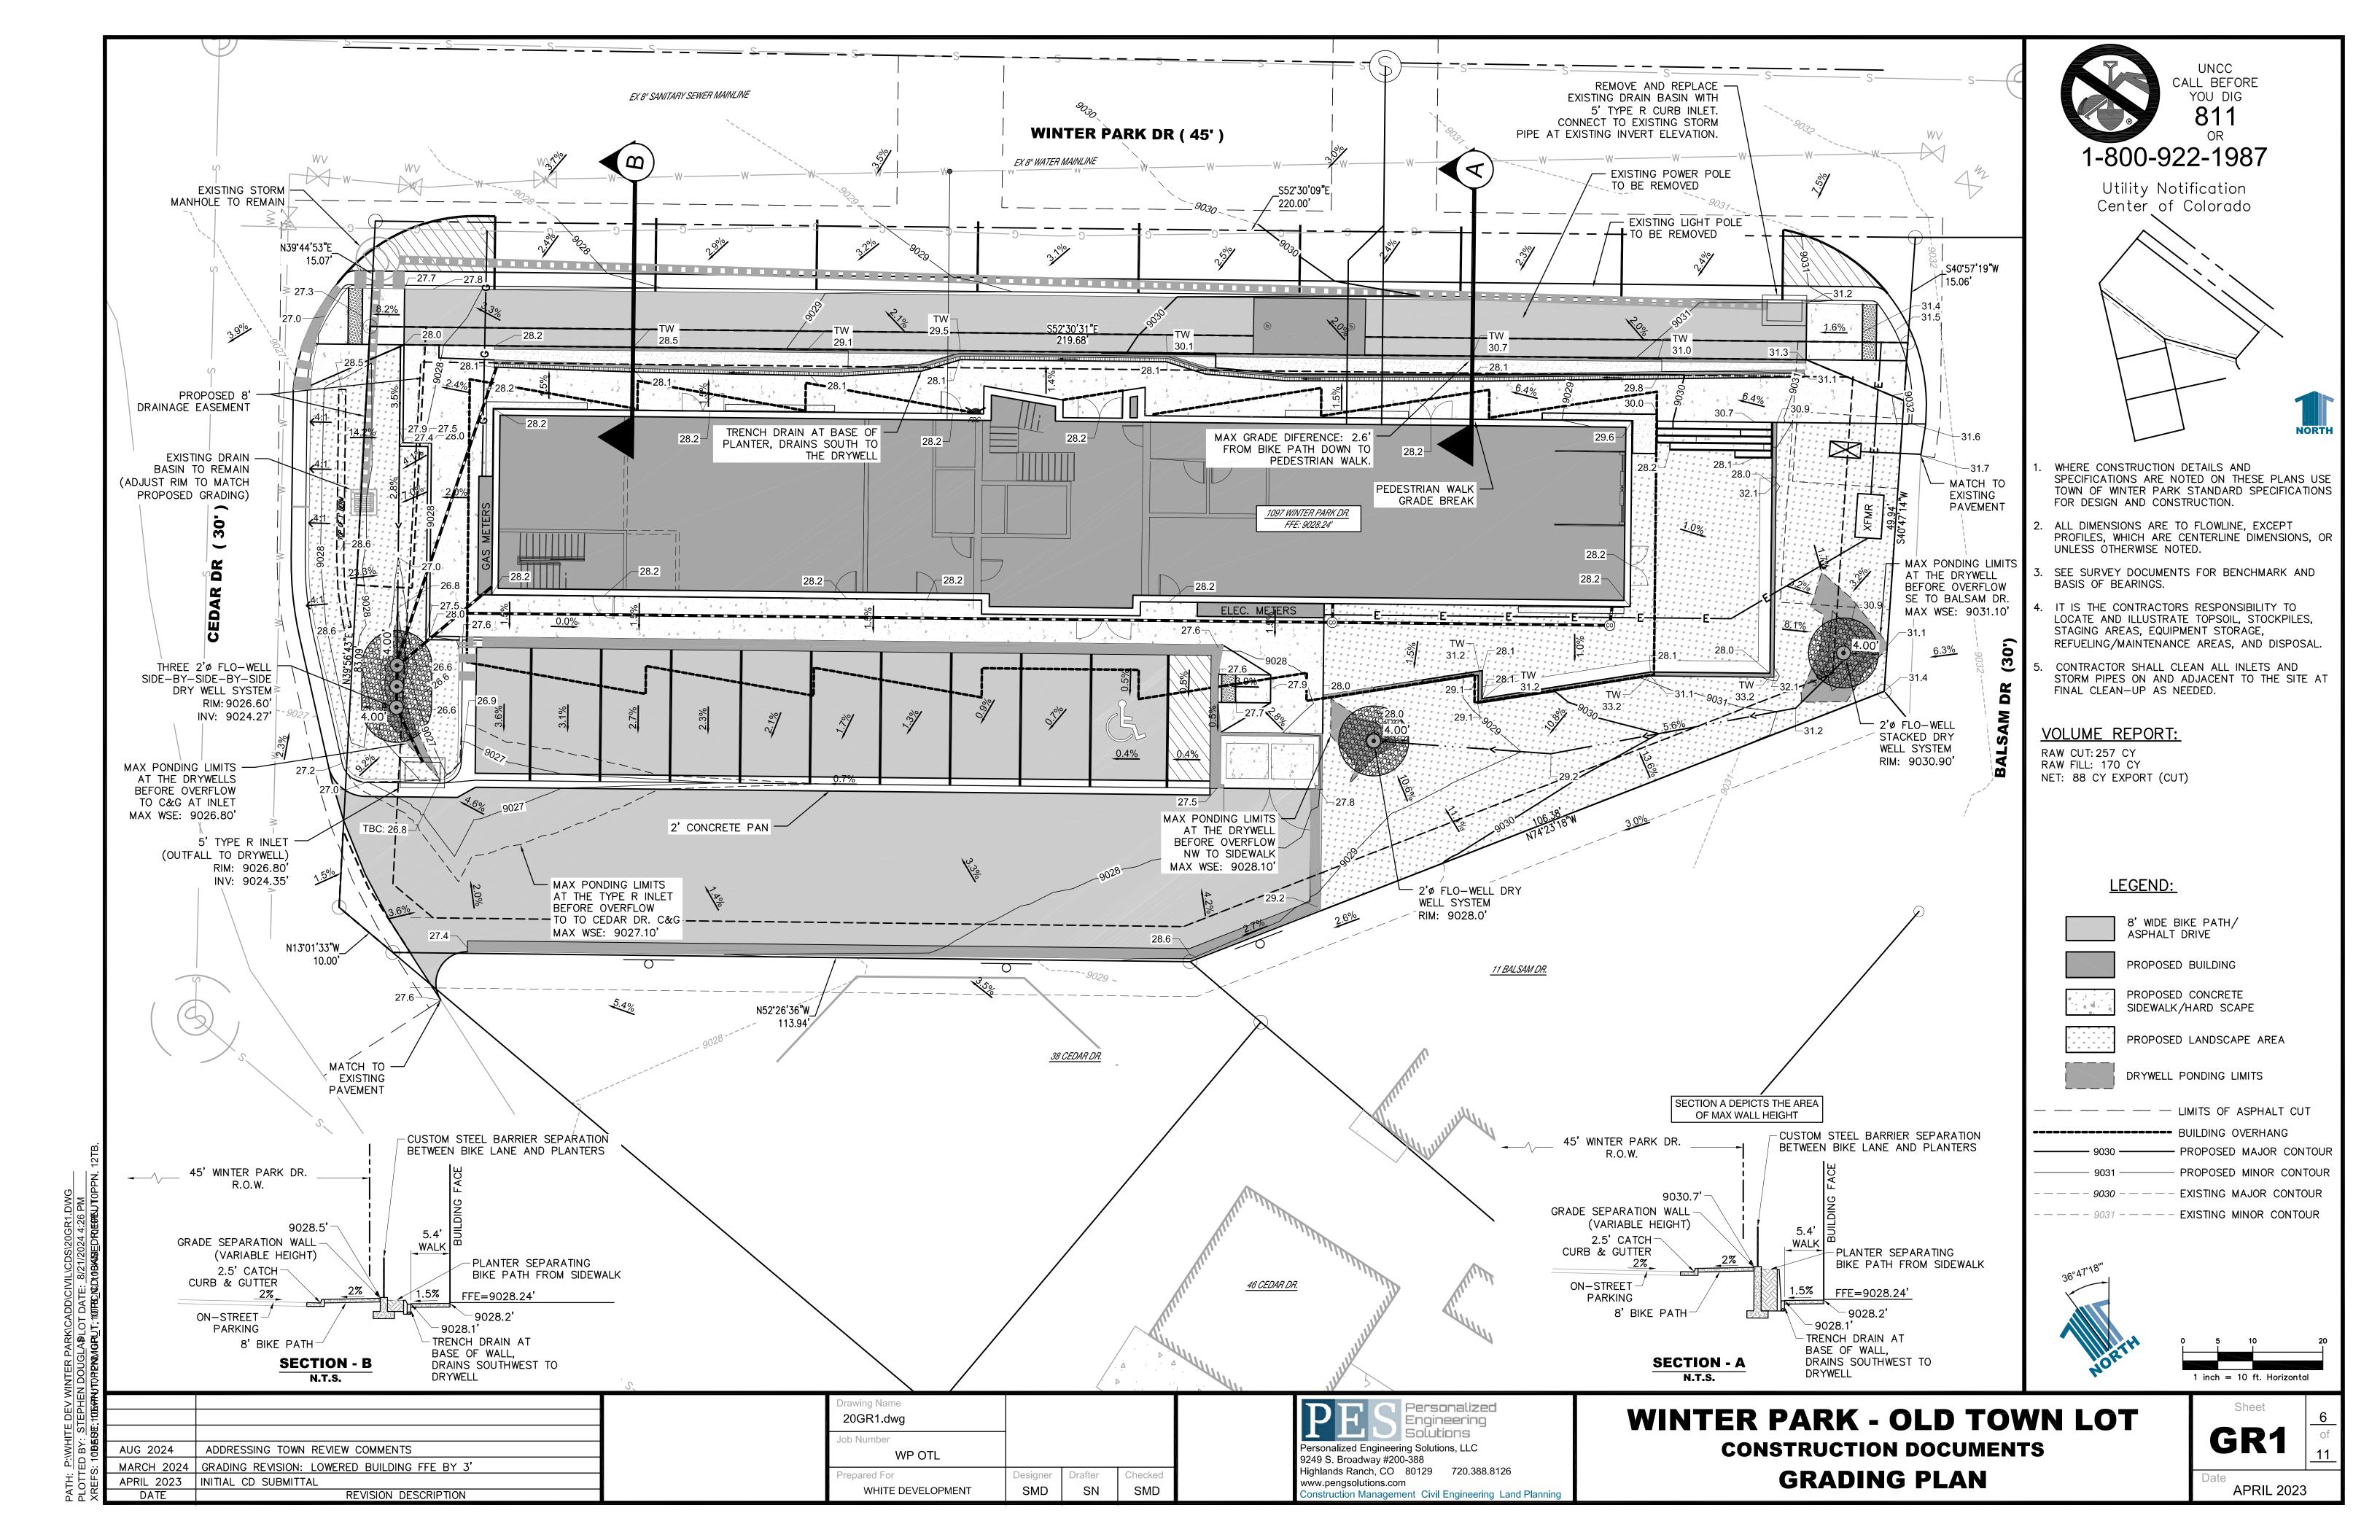
WINTER PARK - OLD TOWN LOT CONSTRUCTION DOCUMENTS
GENERAL NOTES







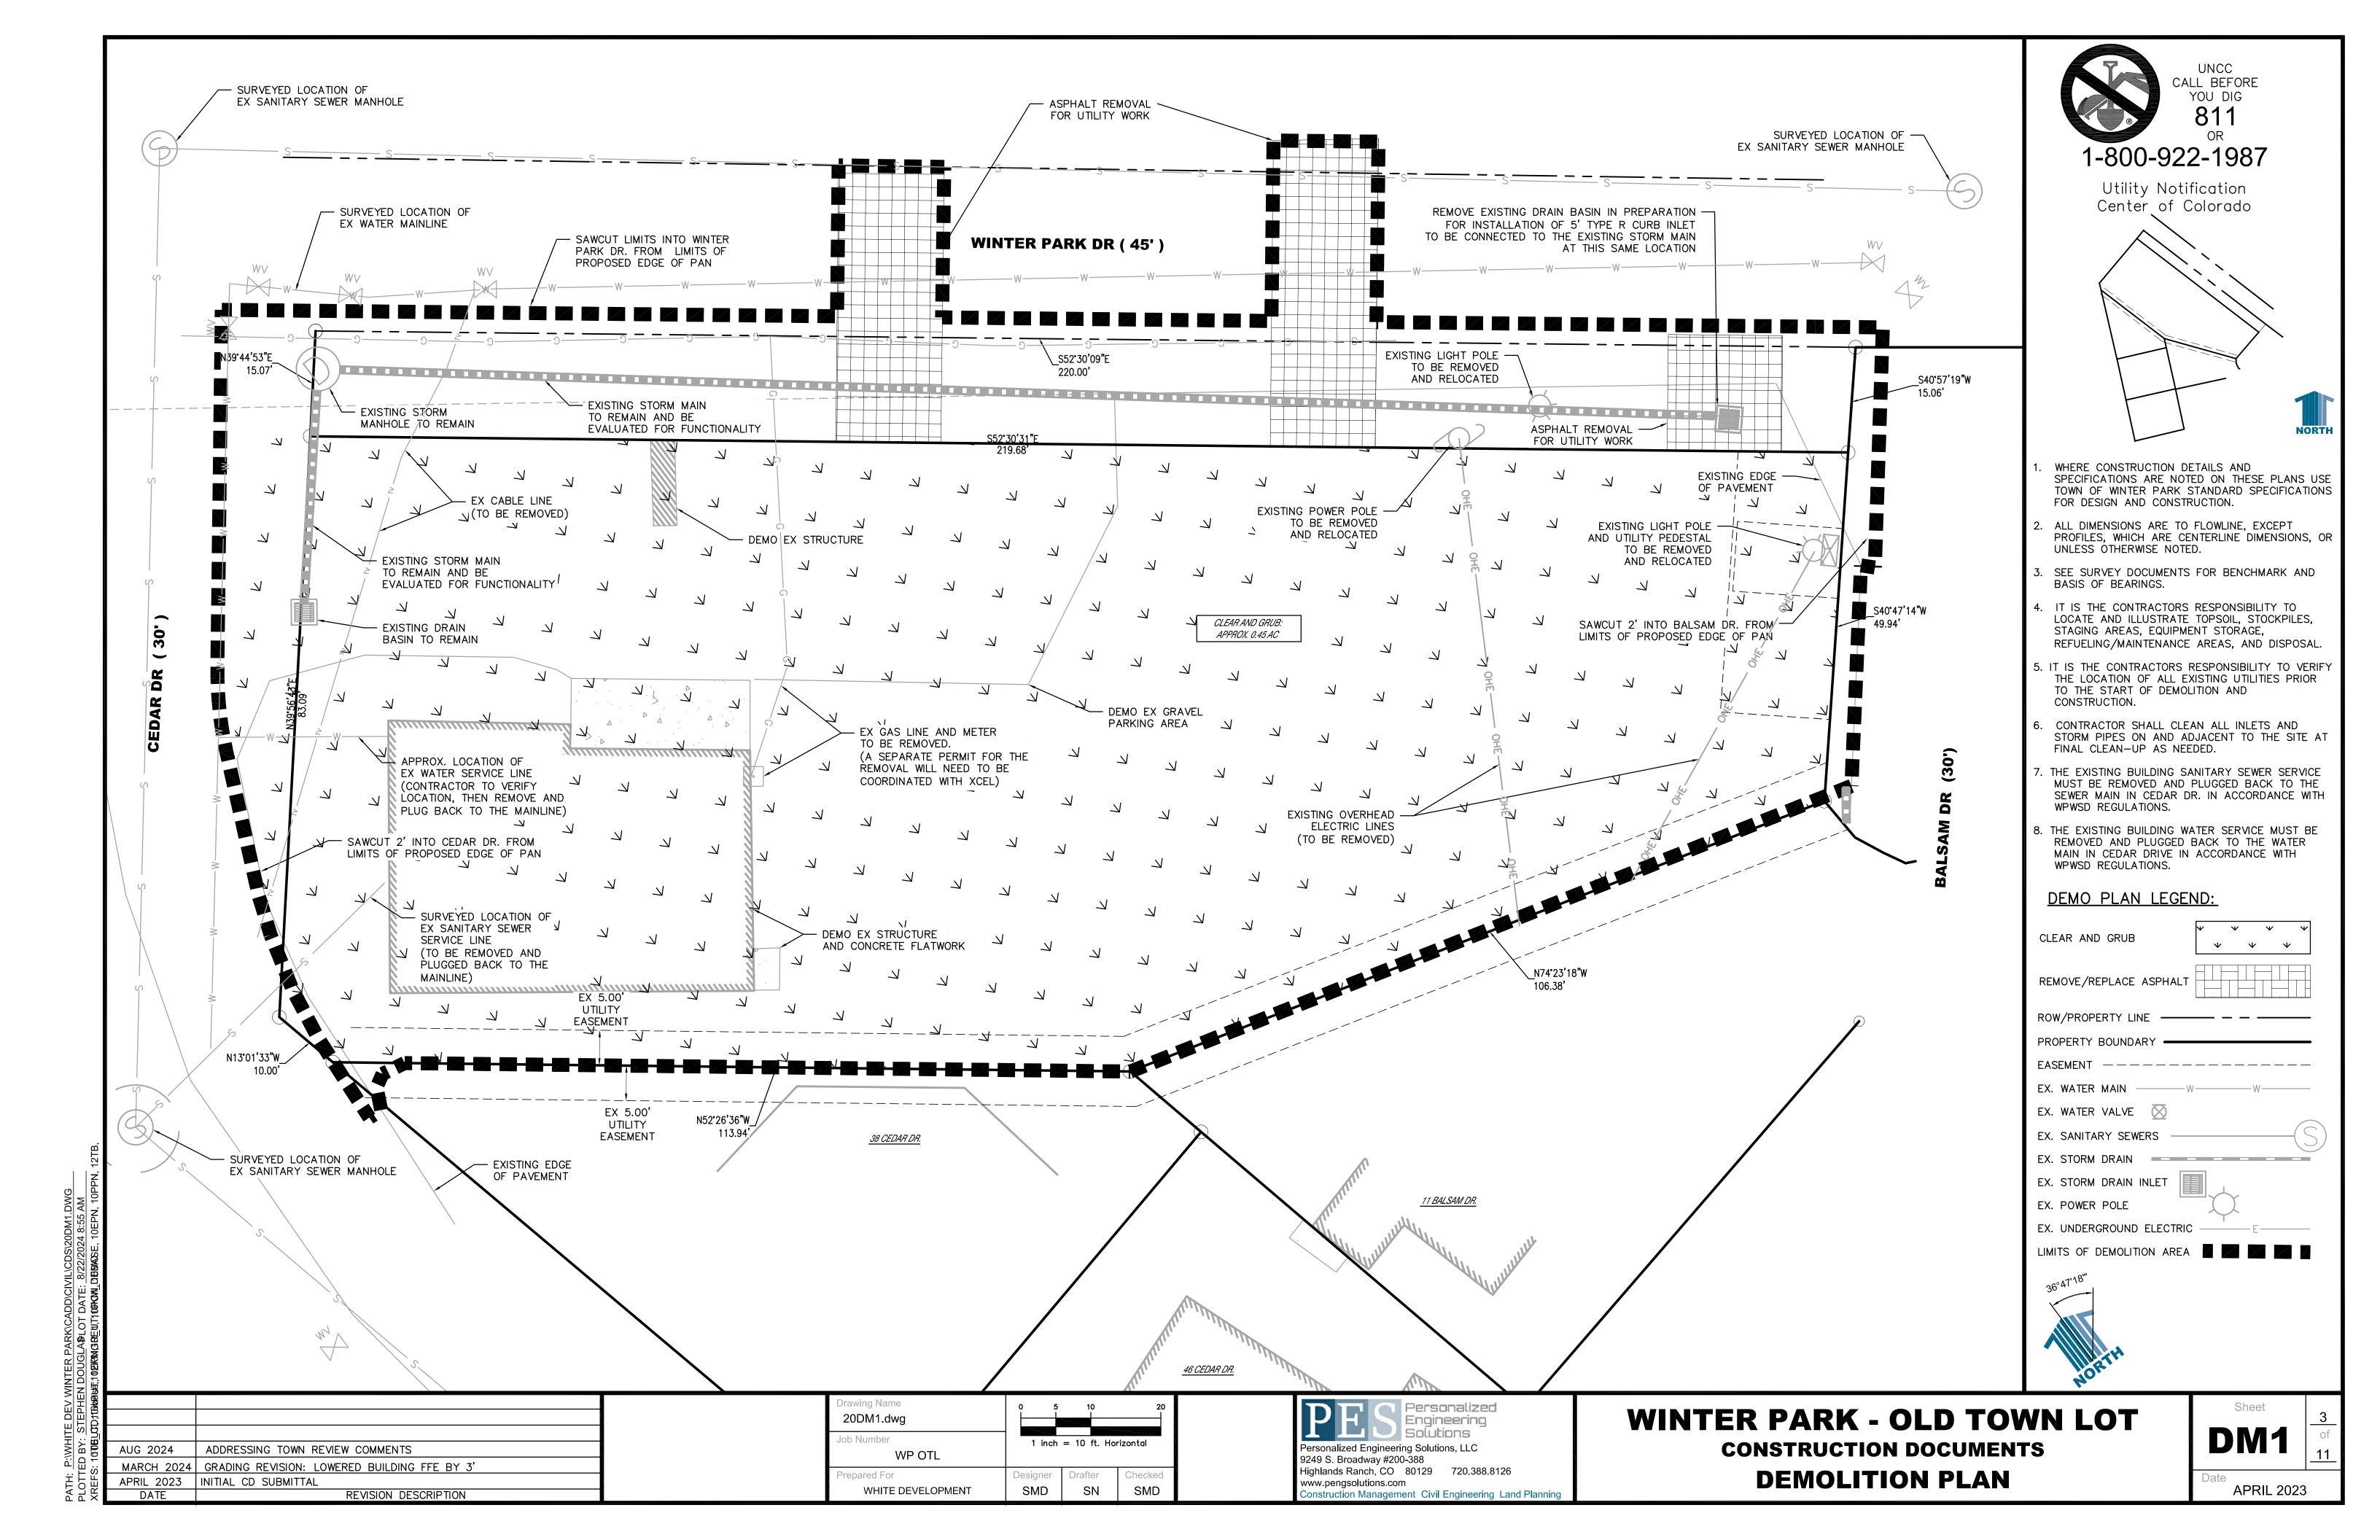


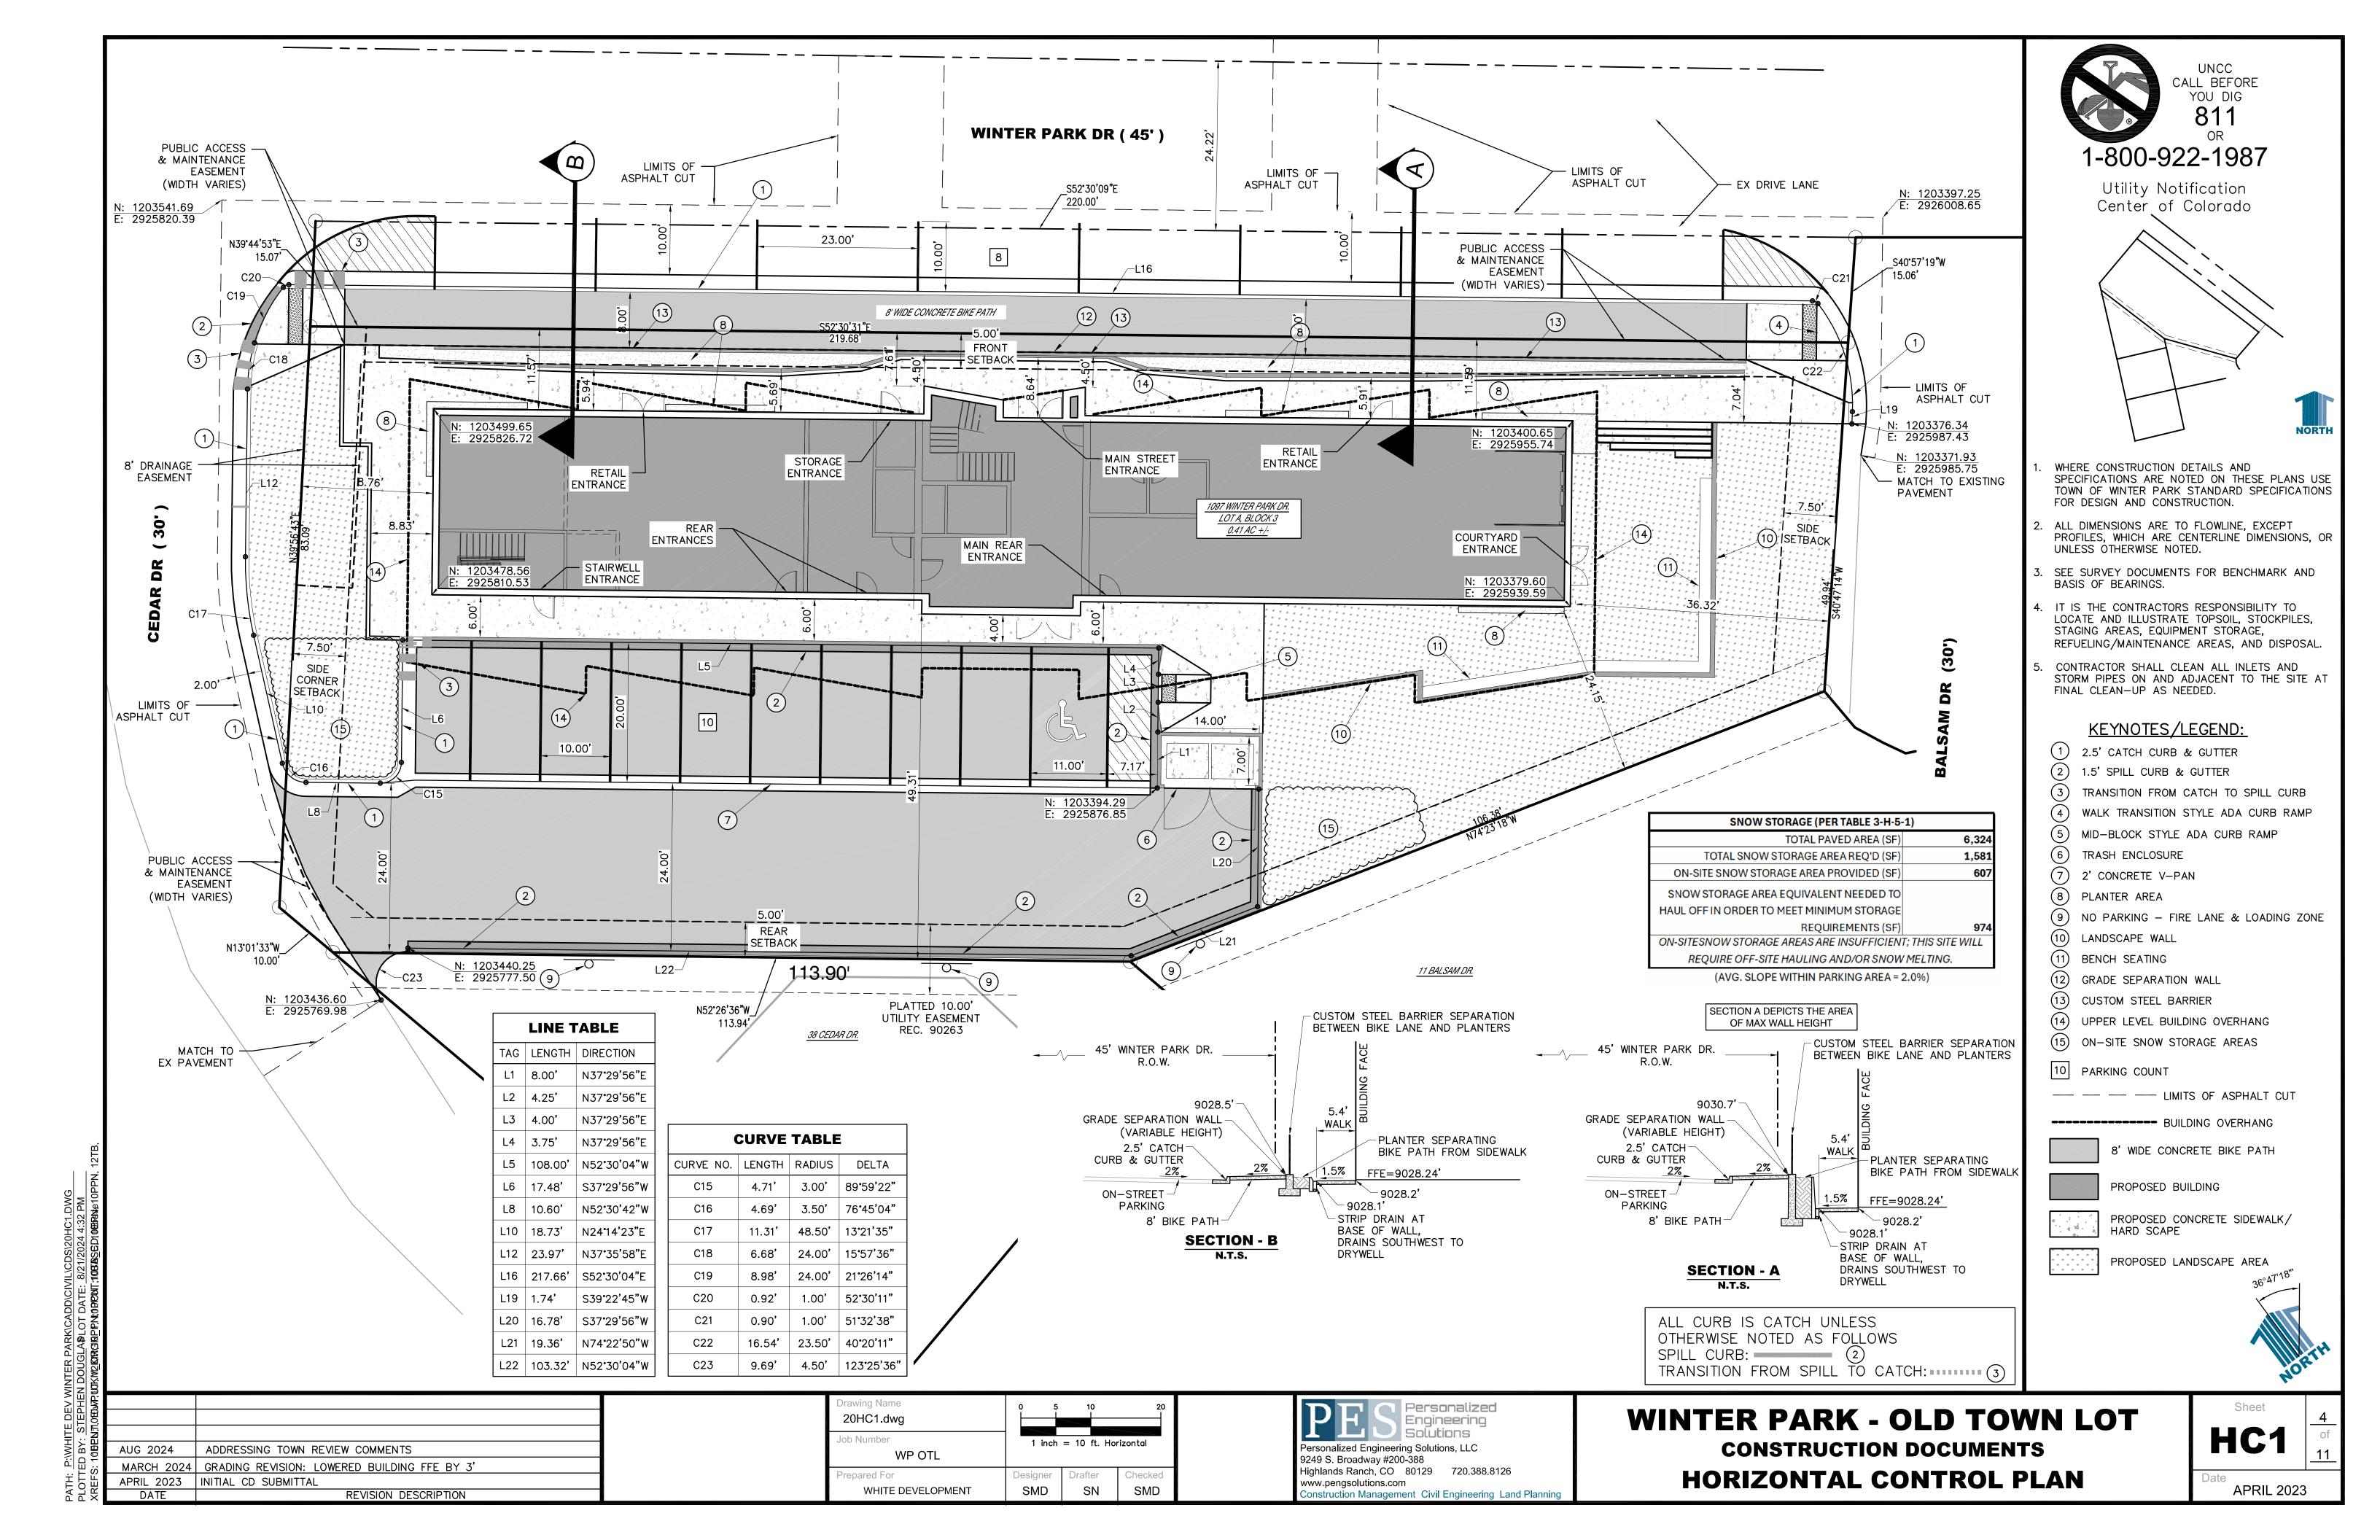


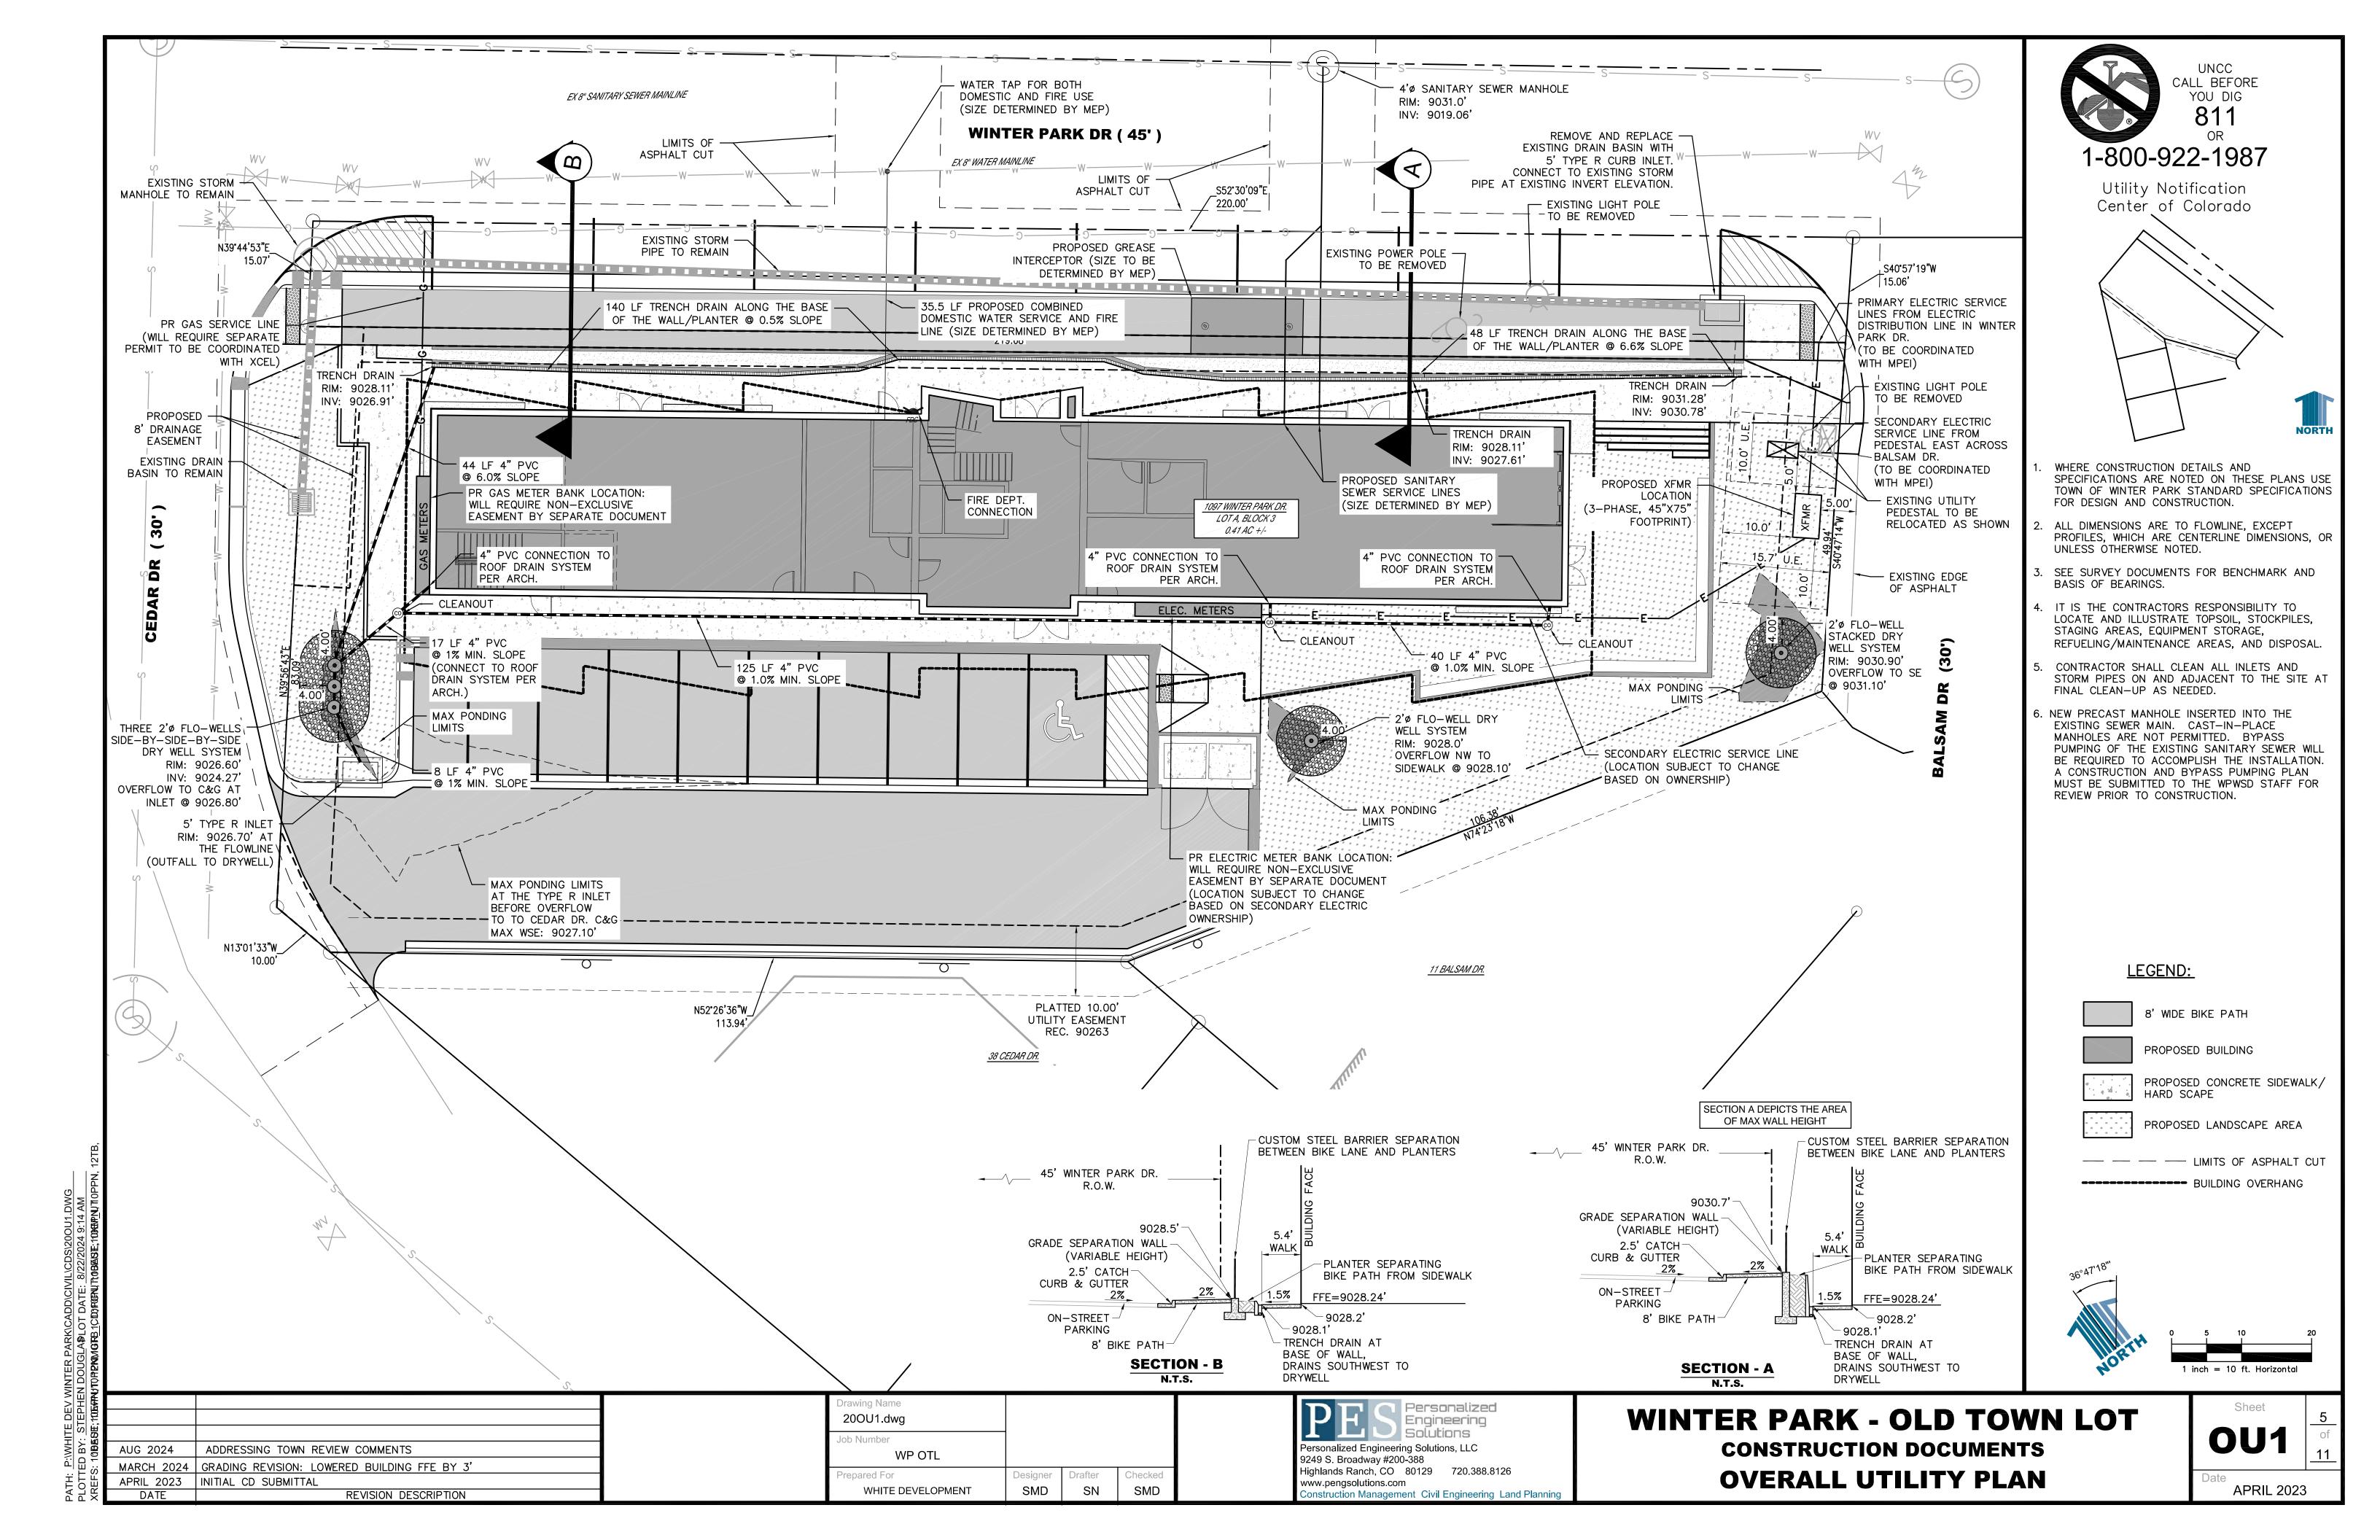


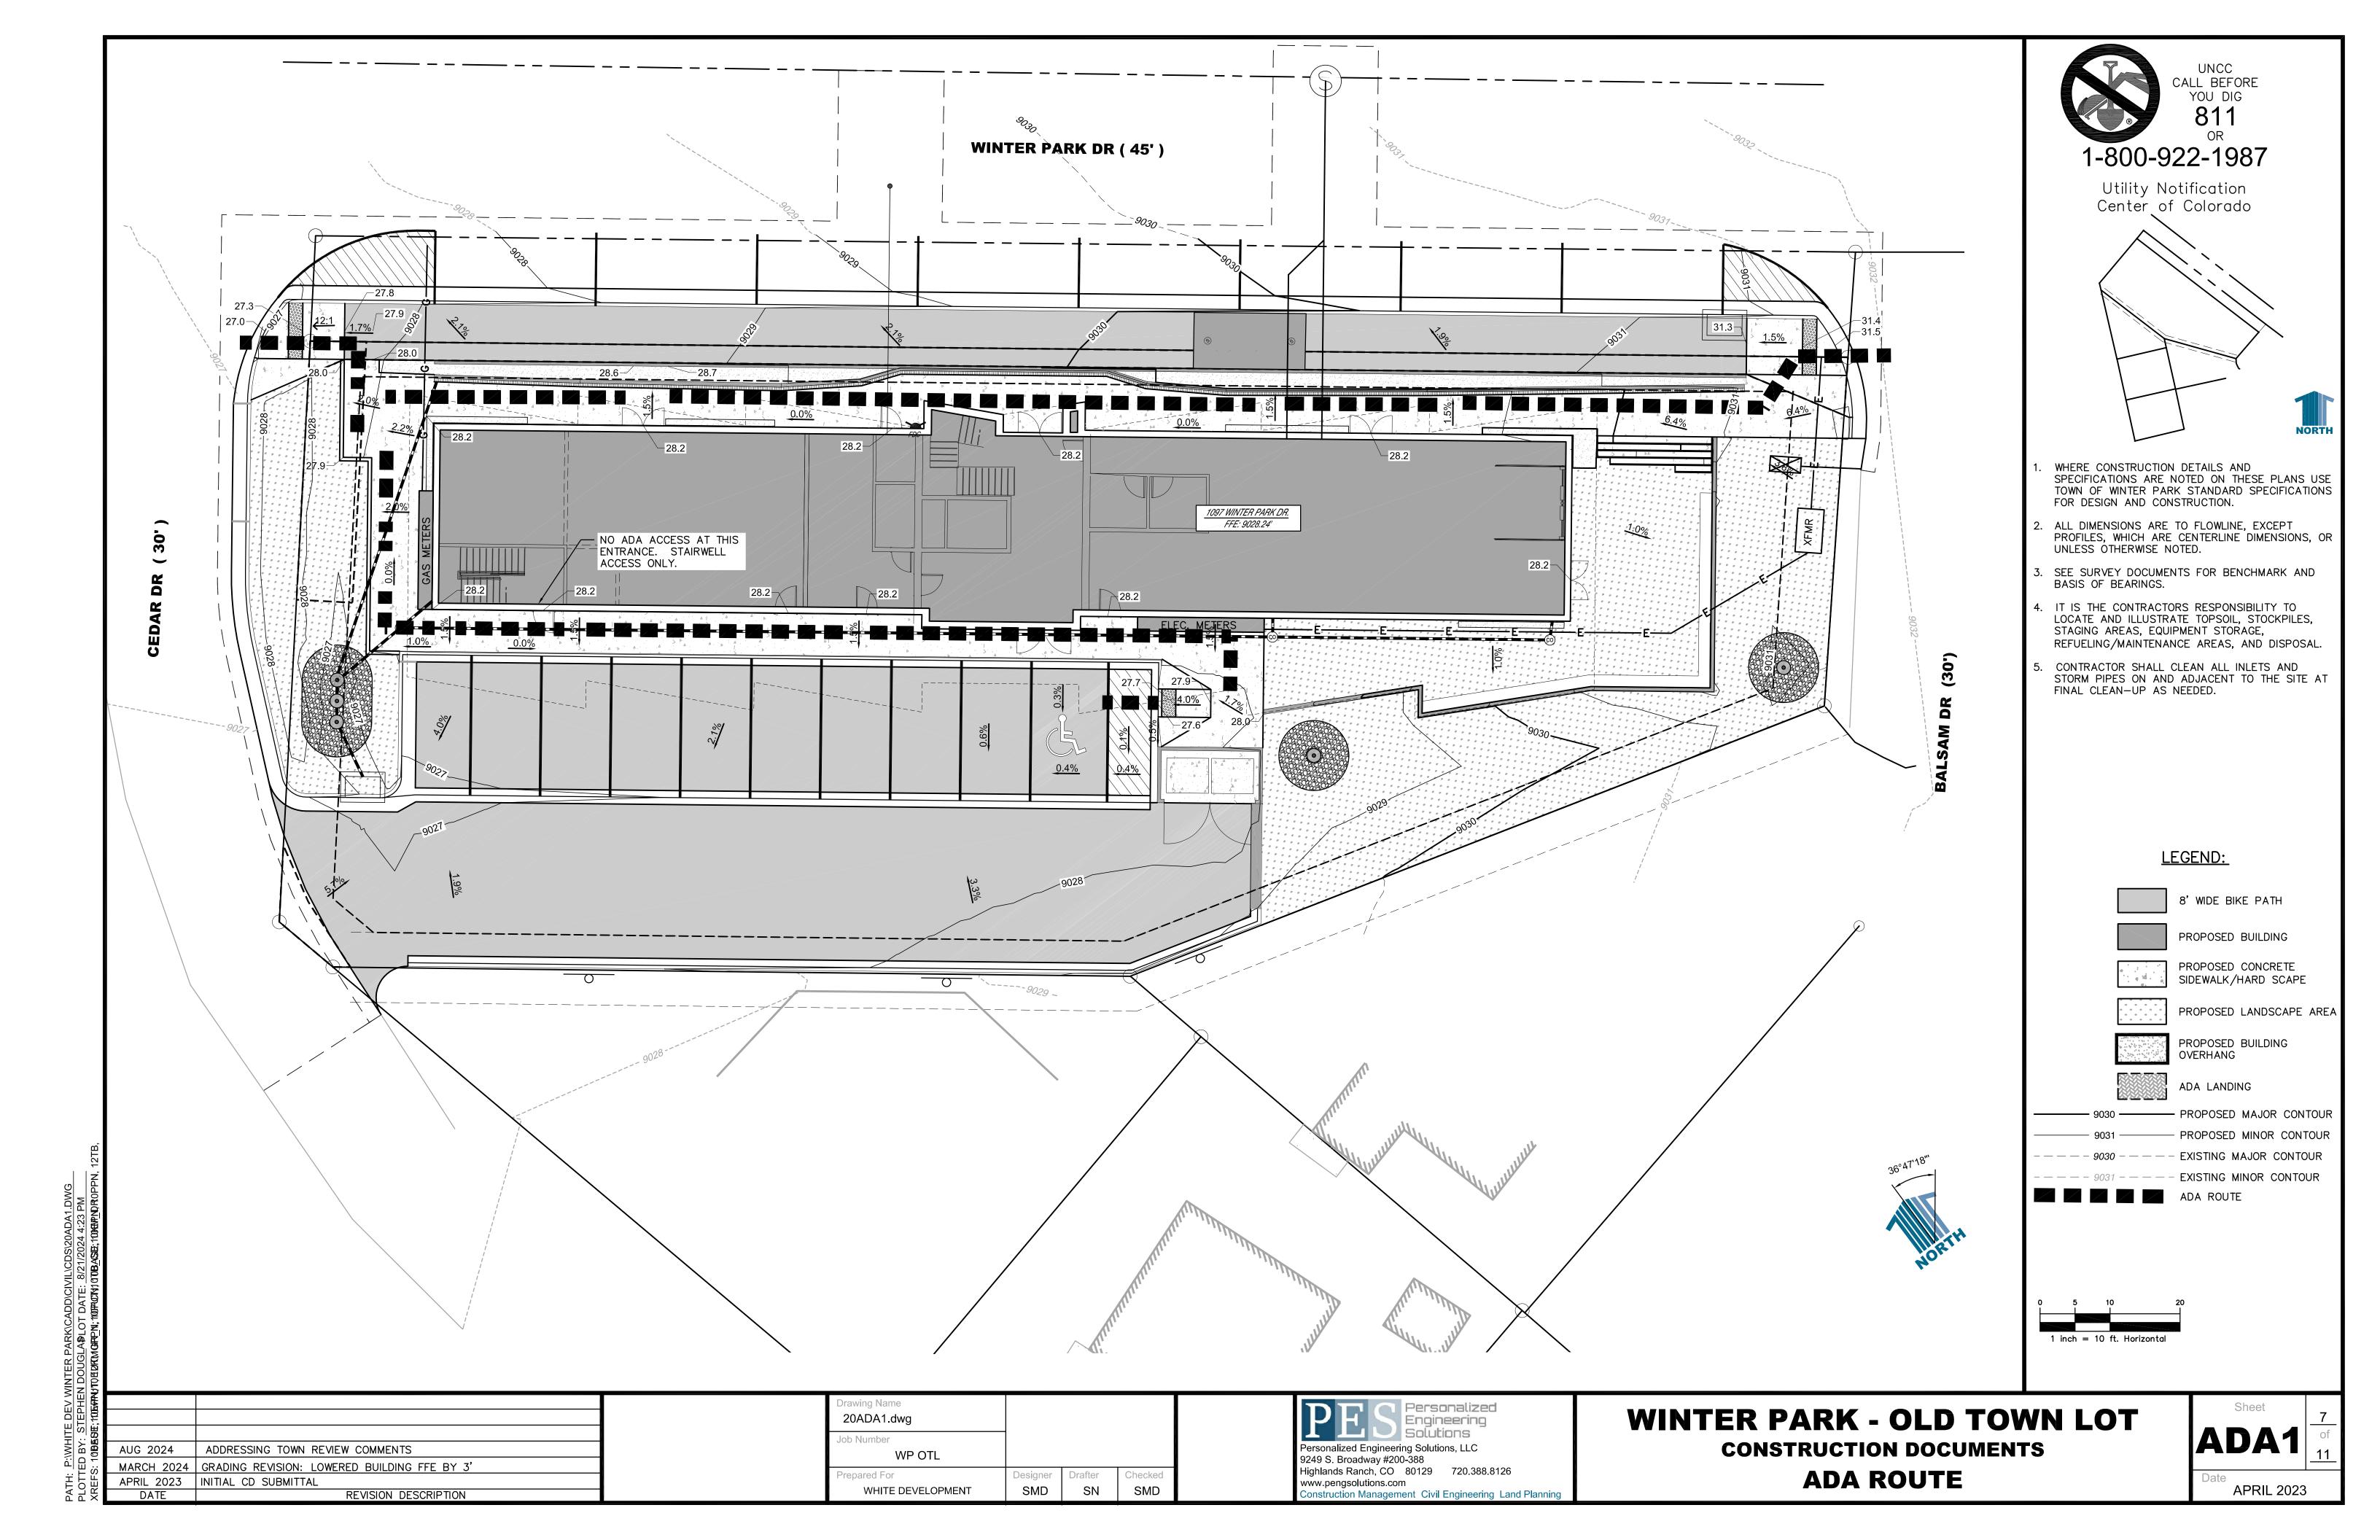


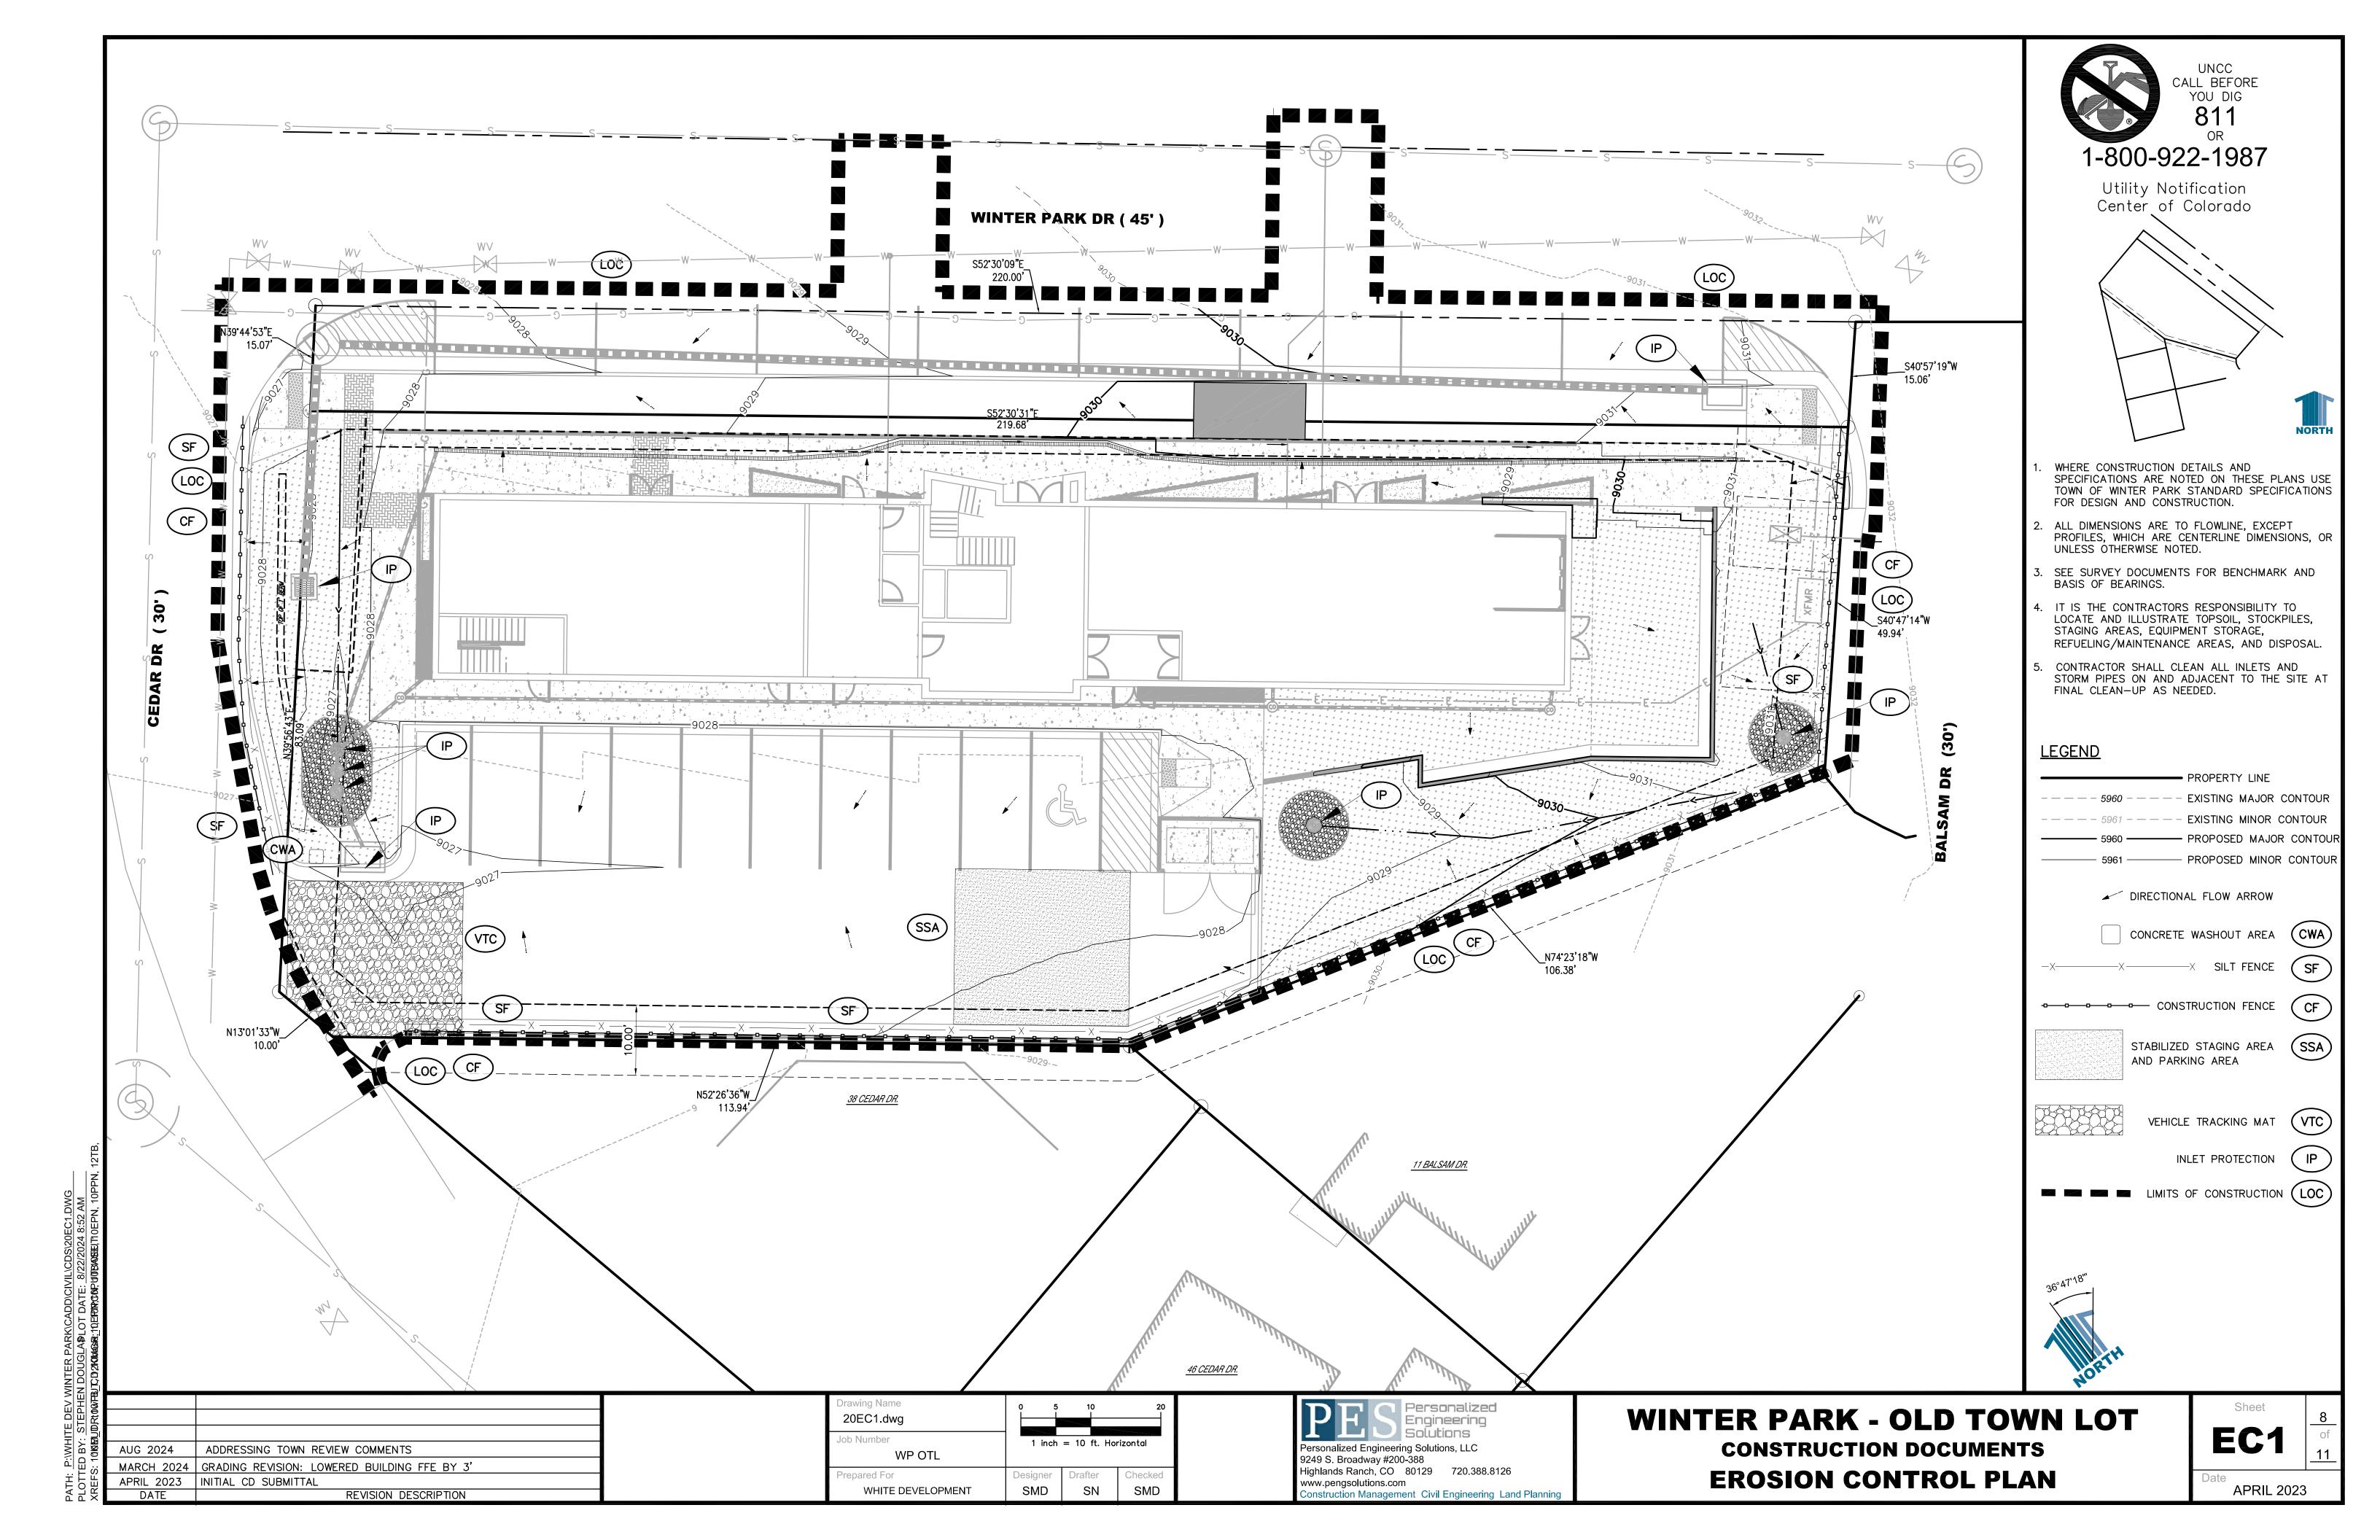


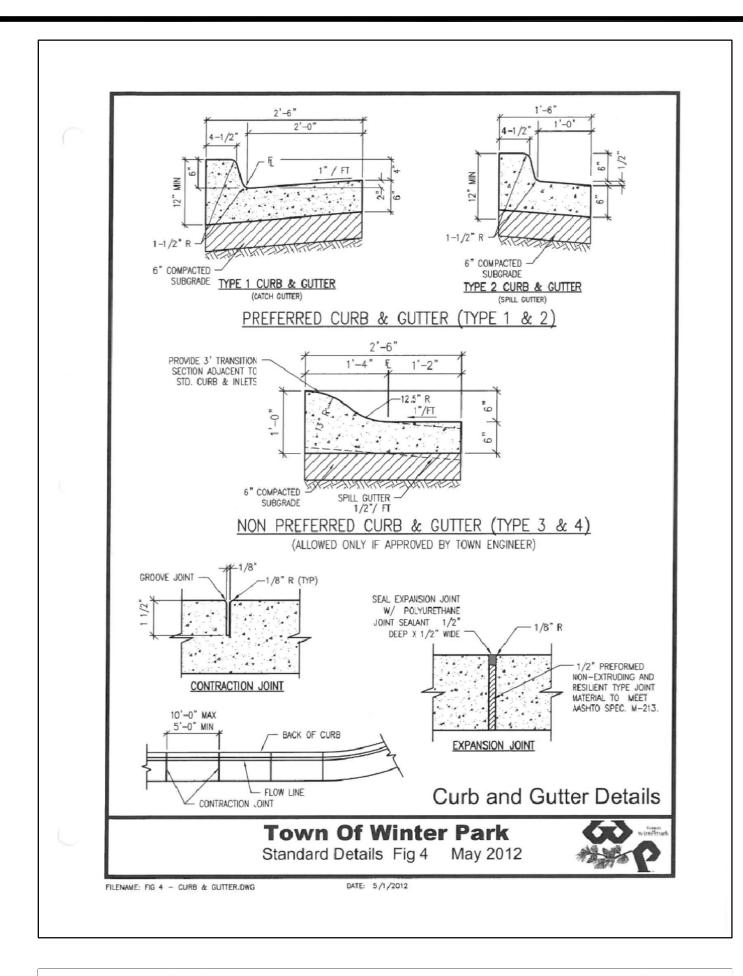


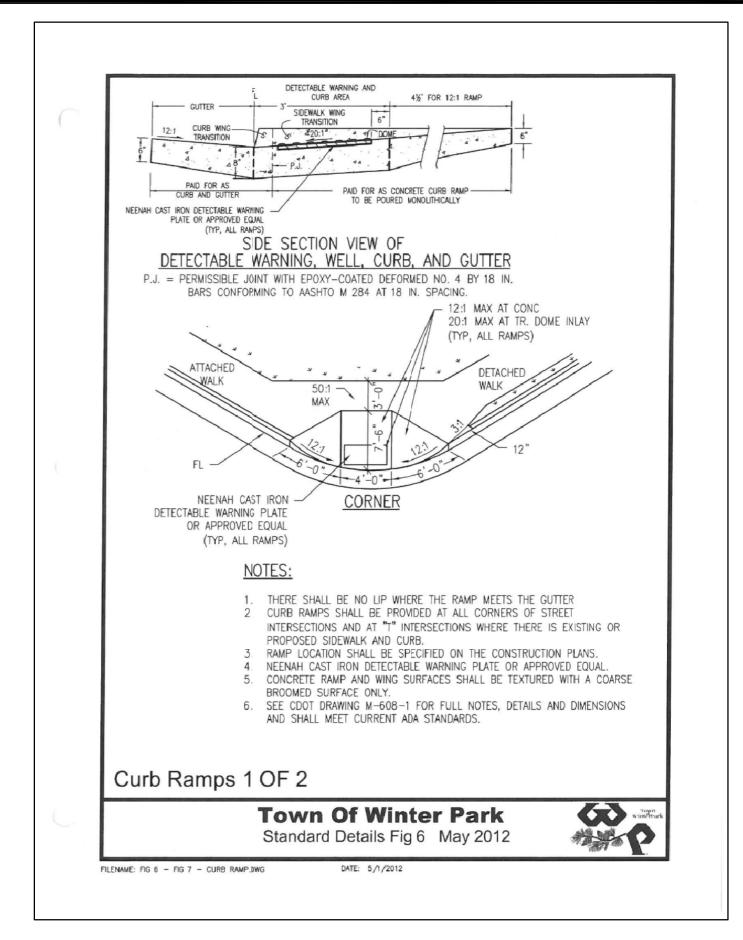


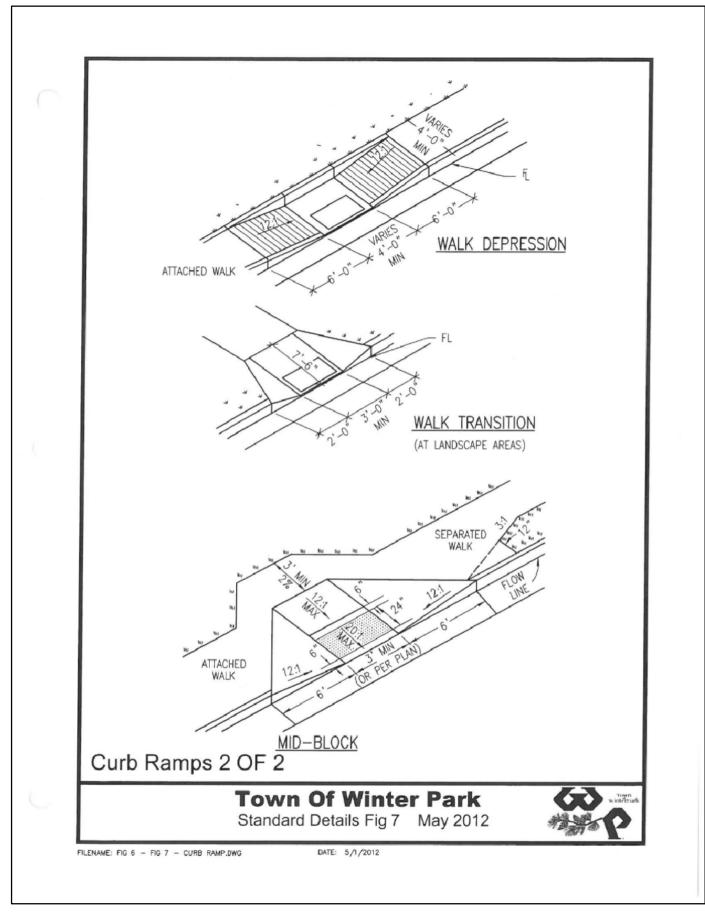


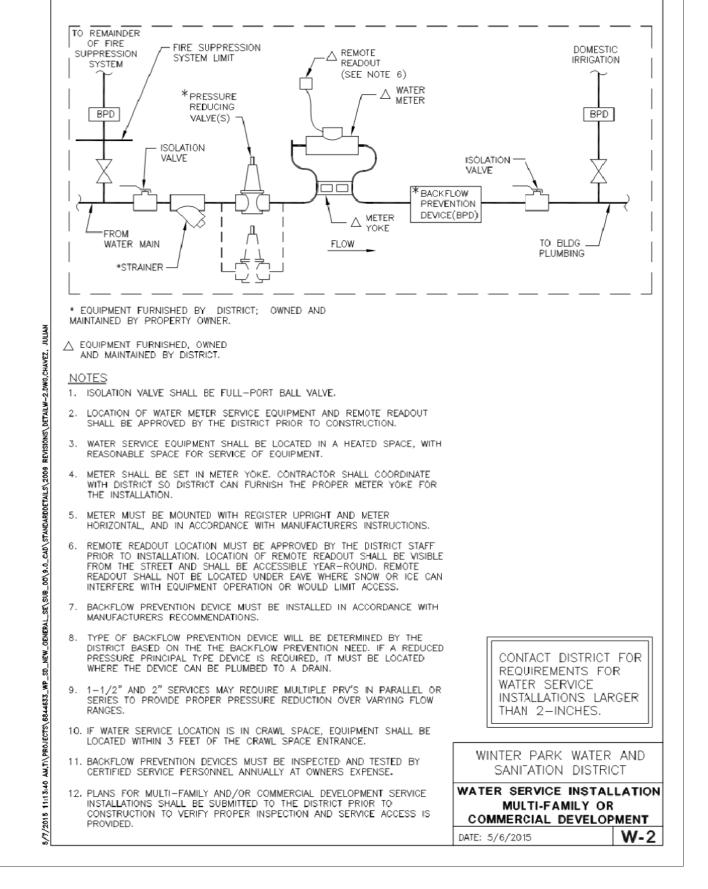


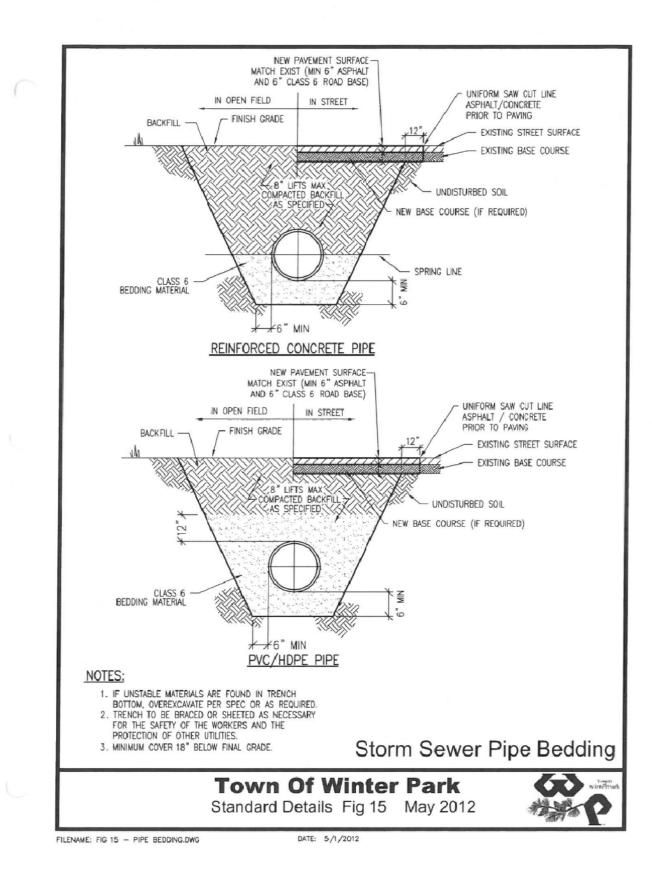

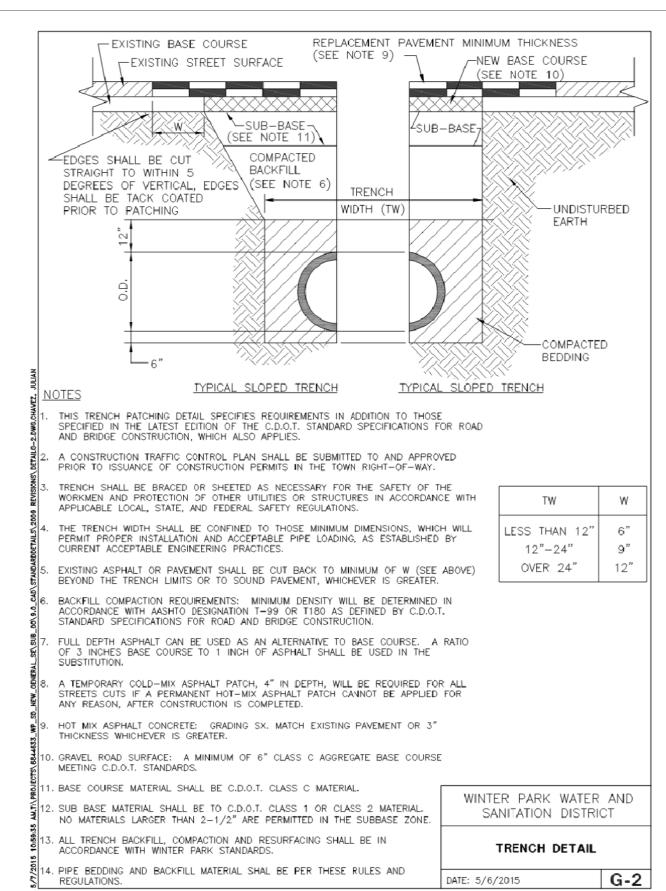

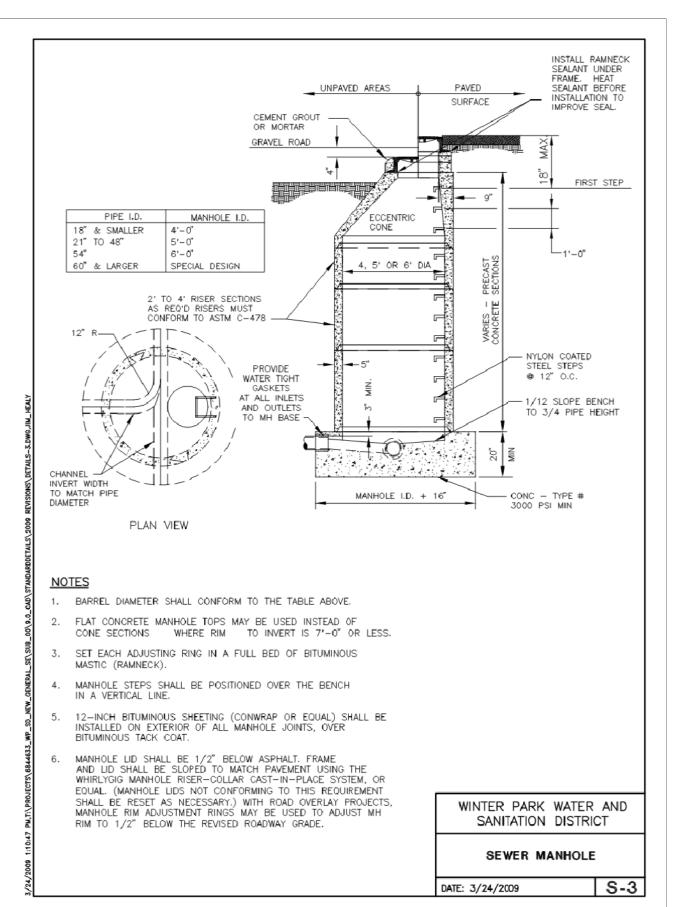

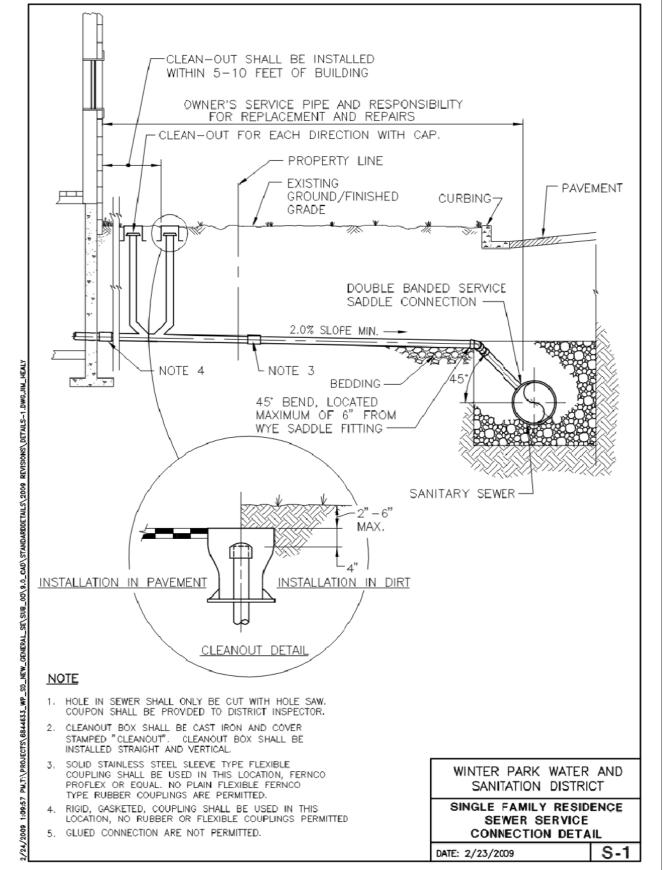


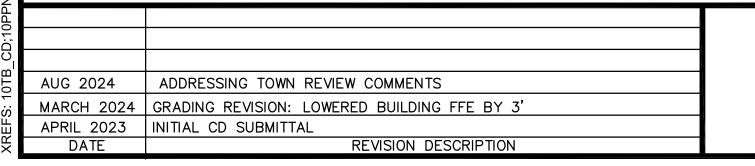


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Job Number				
WP OTL				
Prepared For	Designer	Drafter	Checked	
WHITE DEVELOPMENT	SMD	SN	SMD	





**WINTER PARK - OLD TOWN LOT CONSTRUCTION DOCUMENTS CONSTRUCTION DETAILS** 

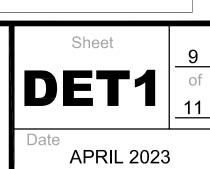



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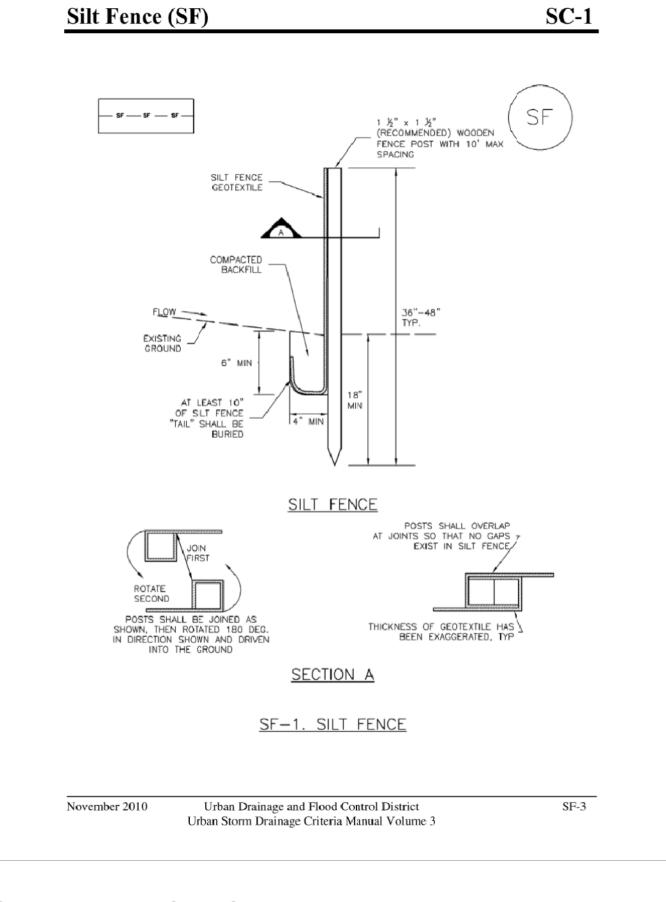


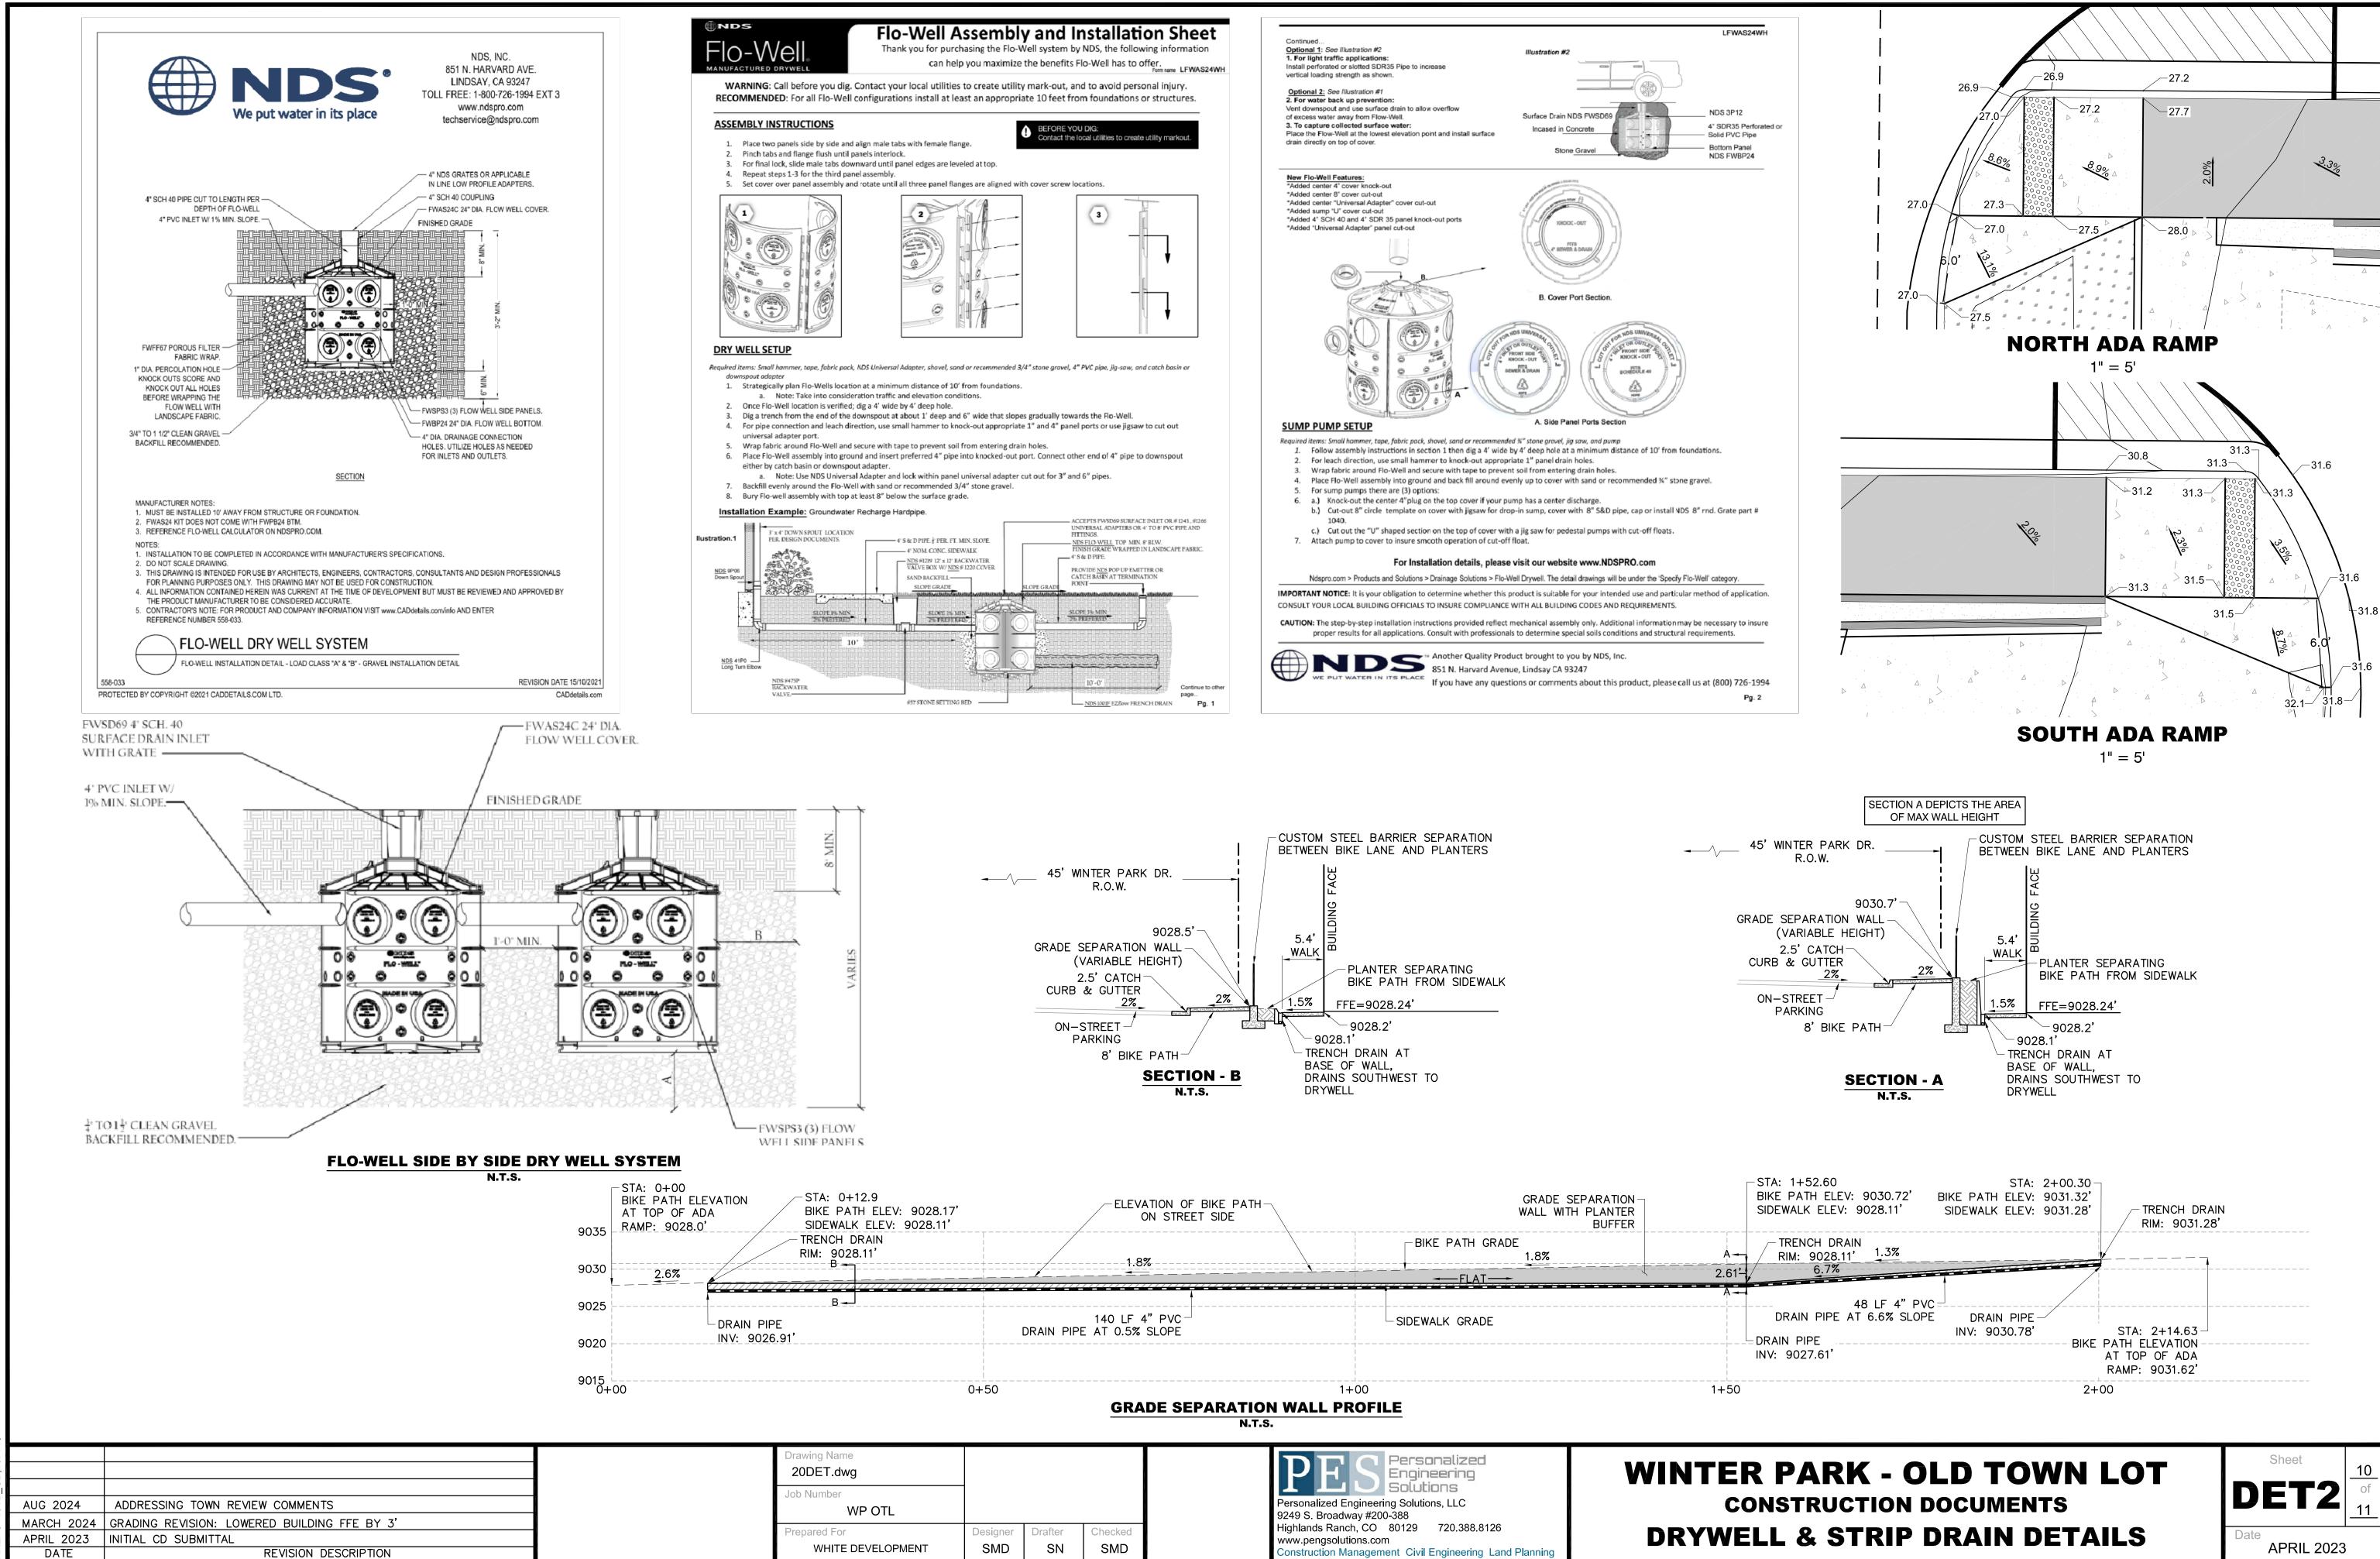


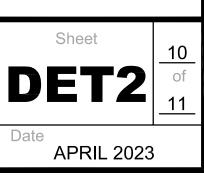


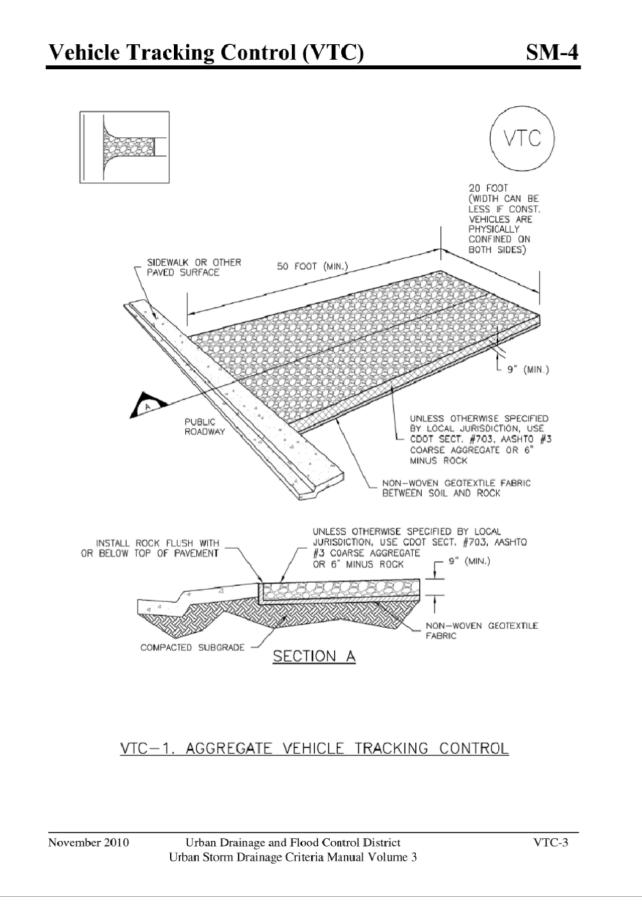


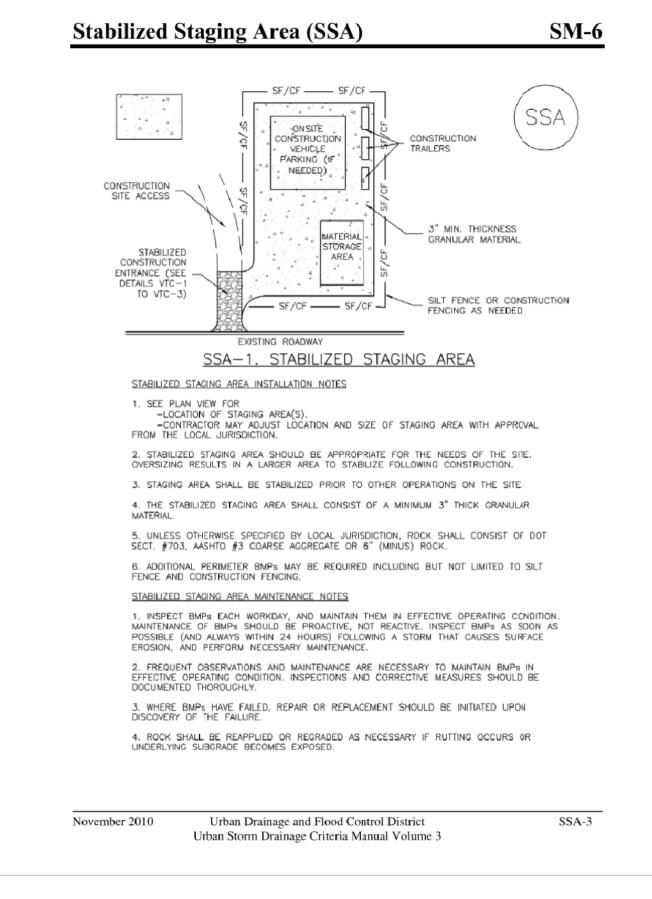


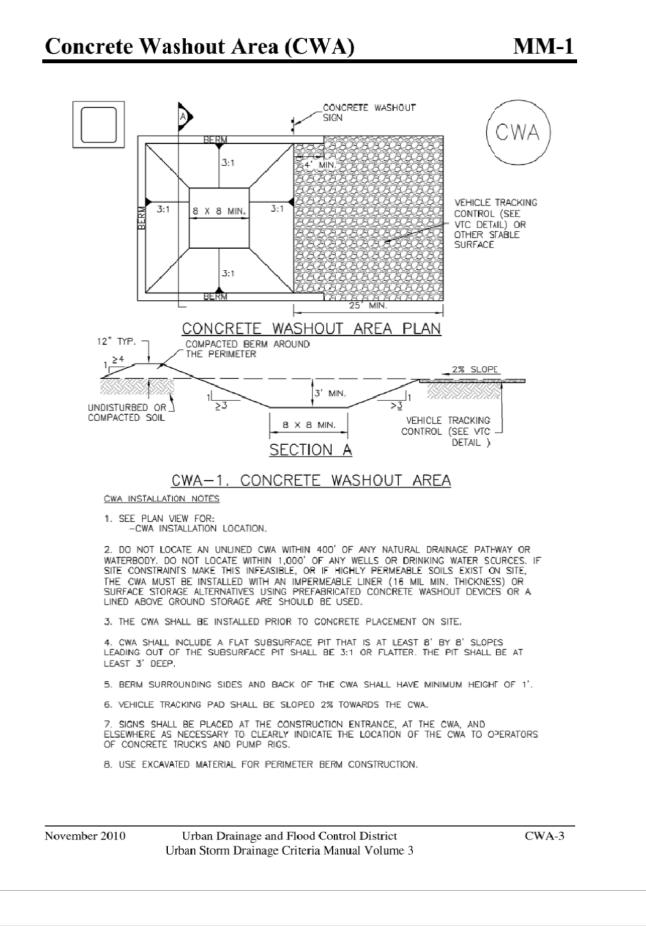

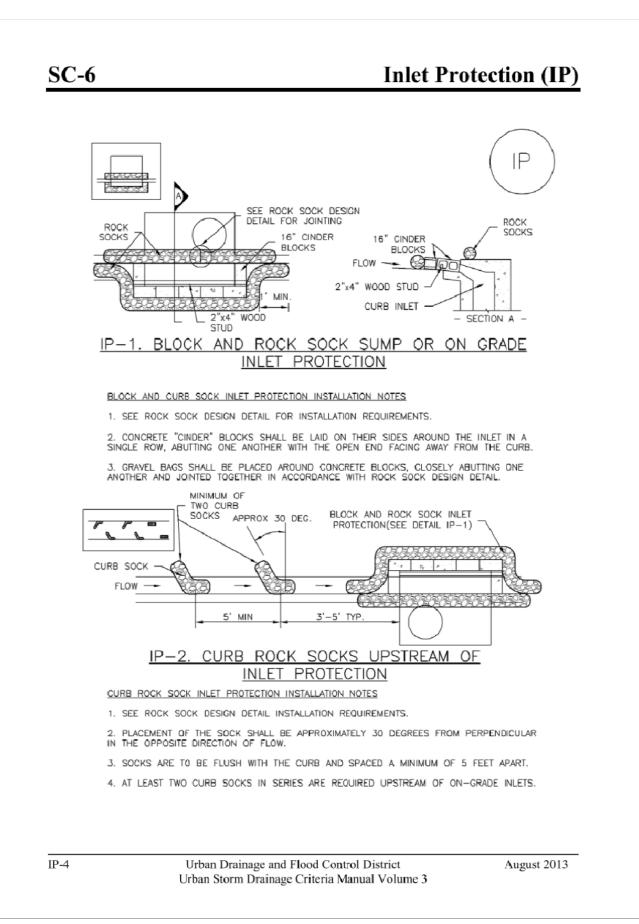

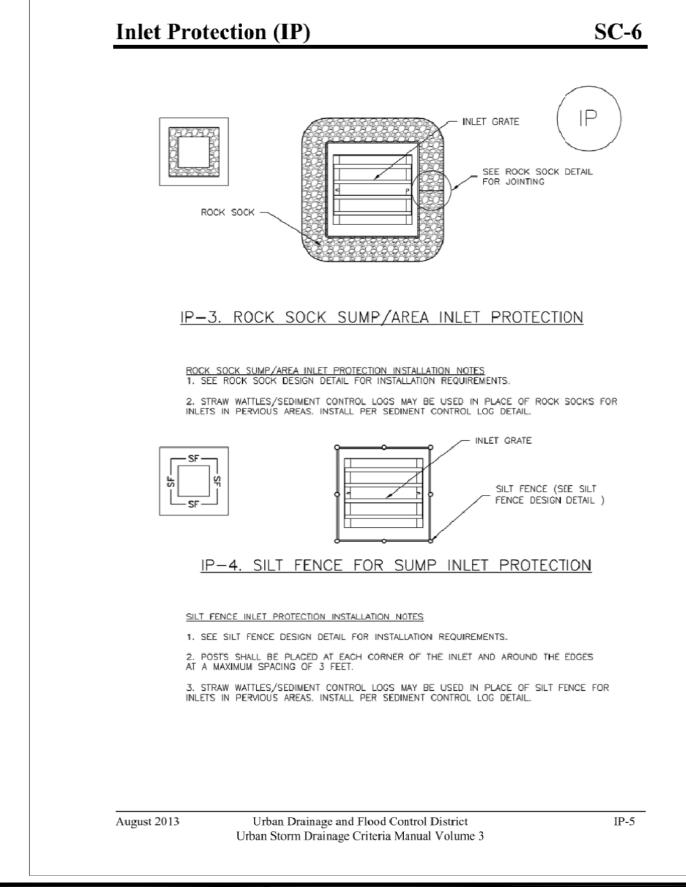

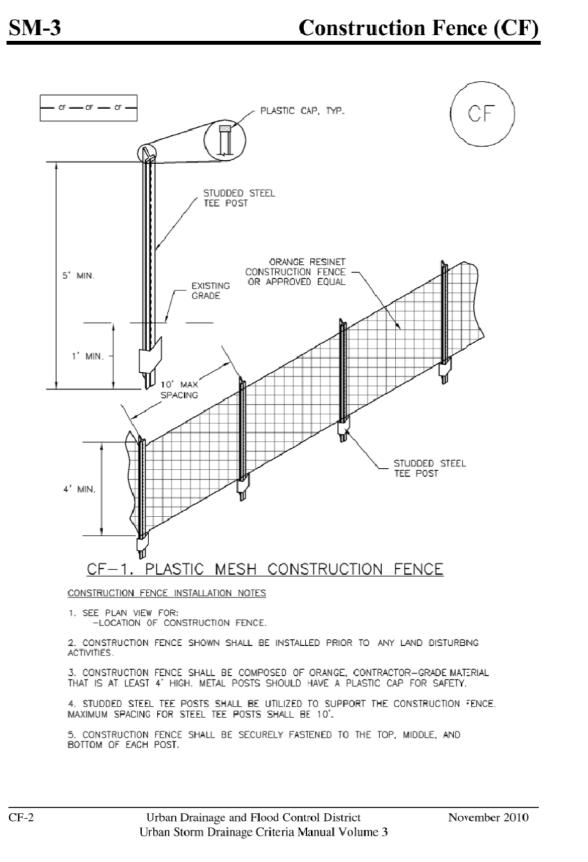

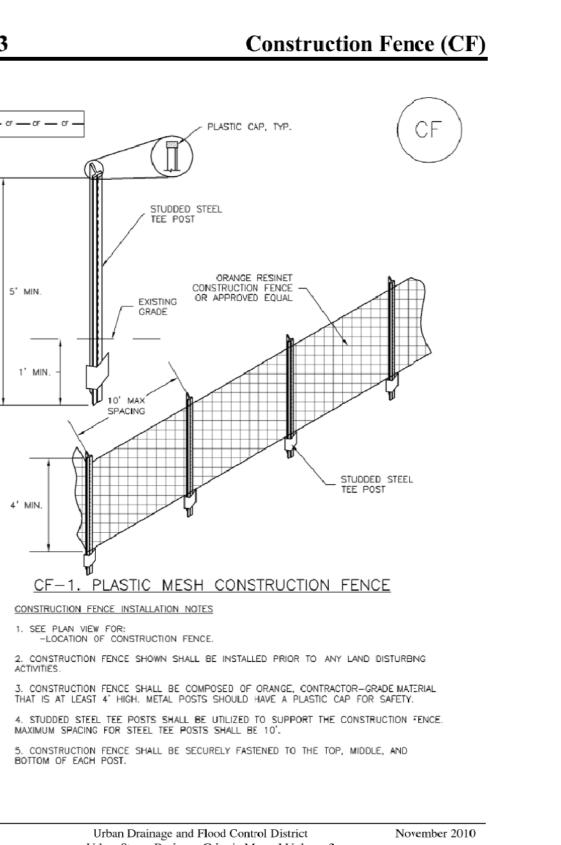

## **GENERAL NOTES:**


- THE CONTRACTOR SHALL NOT STORE MATERIALS OR PARK VEHICLES OUTSIDE THE PROPERTY LINE. 2. THE CONTRACTOR SHALL REMOVE THE TOP 6" OF SOIL FROM WITHIN THE CONSTRUCTION BOUNDARIES PRIOR TO FOUNDATION EXCAVATION. THIS MATERIAL SHALL BE STORED AND STABILIZED ACCORDING TO THE APPROVED CONSTRUCTION PLANS.
- DURING FINAL GRADING THE CONTRACTOR SHALL LEAVE ALL SLOPES AS ROUGH AS POSSIBLE
- ACCORDING TO THE REVEGETATION NOTES. DRAINAGE SWALES ARE SHOWN IN THEIR APPROXIMATE LOCATIONS. THE CONTRACTOR SHALL MAKE MINOR LOCATION CHANGES AS NECESSARY TO AVOID CUTTING THE ROOT ZONE OF TREES
- OVER 3" IN DIAMETER. CONTRACTOR SHALL REFER TO DRAWINGS AND APPLICABLE NOTES FOR COMPLETE LISTING OF MATERIALS AND METHODS OF PLACEMENT TO BE USED FOR TEMPORARY AND PERMANENT EROSION


## **TEMPORARY EROSION CONTROL:**

- TEMPORARY SILTATION FENCE SHALL BE UTILIZED DURING THE CONSTRUCTION AND LANDSCAPING PERIODS. FENCE SHALL BE LOCATED ACCORDING TO THE EROSION CONTROL PLAN AND SHALL BE INSTALLED PRIOR TO EXCAVATION.
- THE CONTRACTOR SHALL BE RESPONSIBLE FOR PREVENTING THE RELEASE OF SEDIMENT LADEN WATER FROM THE CONSTRUCTION SITE, AND SHALL BE REQUIRED TO INSTALL ADDITIONAL CONTROL FACILITIES, SHOULD PROBLEMS OCCUR DURING CONSTRUCTION.

## PERMANENT EROSION CONTROL:

- RUNOFF FROM PAVED SURFACES SHALL SHEET FLOW TO AREAS TO BE PLANTED WITH SELECTED
- GRASSES, TREES AND SHRUBS, UNLESS OTHER NOTED ON THE EROSION CONTROL PLANS. EXPOSED SOIL SHALL BE STABILIZED AND PROTECTED FROM EROSIVE FORCES AS SOON AS POSSIBLE, BUT NO LATER THAN 14 DAYS AFTER ACHIEVING FINISHED GRADE. APPROPRIATE SOIL STABILIZATION TECHNIQUES INCLUDE: MULCHING, ROLLED EROSION CONTROL PRODUCTS,
- PROPRIETARY GEOSYNTHETICS AND BONDED FIBER MATRIX. 3. IN ADDITION TO THE SOIL STABILIZATION TECHNIQUES APPLIED, TEMPORARY REVEGATATION IS REQUIRED ON ALL DISTURBED AREAS HAVING A PERIOD OF EXPOSURE OF ONE YEAR OR LONGER PRIOR TO FINAL STABILIZATION. TEMPORARY SEEDING SHALL CONSIST OF AN ANNUAL GRASS COVER CROP AND MAY BE APPLIED HYDRAULICALLY, DRILLED, OR BROADCAST.
- 4. PERMANENT REVEGETATION IS REQUIRED ON ALL DISTURBED AREAS THAT ARE EITHER AT FINISHED GRADE OR EXPECTED TO REMAIN DORMANT FOR A PERIOD LONGER THAN ONE YEAR. PERMANENT SEEDING SHALL CONSIST OF AN APPROPRIATE NATIVE PERENNIAL COVER CROP AS RECOMMENDED BY THE NATURAL RESOURCE CONSERVATION SERVICE OR APPROVED EQUAL.

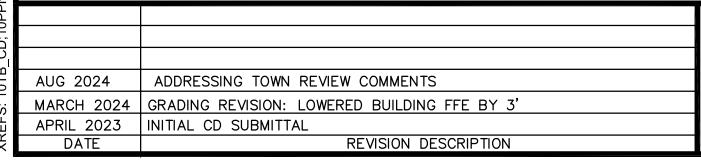

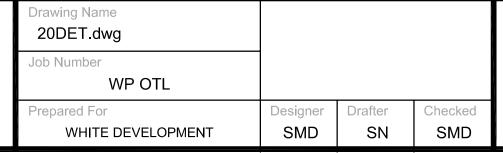




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**WINTER PARK - OLD TOWN LOT CONSTRUCTION DOCUMENTS SWMP DETAILS** 



# WINTER PARK - OLD TOWN LOT

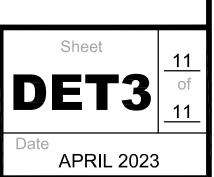MAJOR SITE PLAN

ISSUE DATE: 04/03/2023

1097 Winter Park Drive Winter Park, CO 80482 2128

## ITEM #6E - BUILDING ELEVATIONS

OWNER:

WHITE DEVELOPMENT, LLC

P: 303.506.5995

CONTACT: DEVIN VISCIANO

ARCHITECT:

ROTH SHEPPARD ARCHITECTS, LLP 1900 WAZEE STREET, SUITE 100 DENVER, CO 80202

P: 303.534.7007 F: 303.534.7722

ARCHITECT OF RECORD: ADAM HARDING, AIA MECHANICAL, ELECTRICAL AND PLUMBING ENGINEER:

RAMIREZ, JOHNSON & ASSOCIATES 3301 LAWRENCE ST. SUITE #2, DENVER, CO 80205

P: 720.598.0774

CONTACT: NATE MORRISON, E.I.

CIVIL ENGINEER:

PERSONALIZED ENGINEERING SOLUTIONS 9249 S. BROADWAY #200-388 HIGHLANDS RANCH, COLORADO 80129

P: 720.388.8126

CONTACT: STEPHEN DOUGLAS, PE


LANDSCAPE ARCHITECT:

NEILS LUNCEFORD, INC. P.O. BOX 2130 740 BLUE RIVER PARKWAY SILVERTHORNE, CO 80498

P: 970.468.0340

CONTACT: LAYLA LAZOUSKI



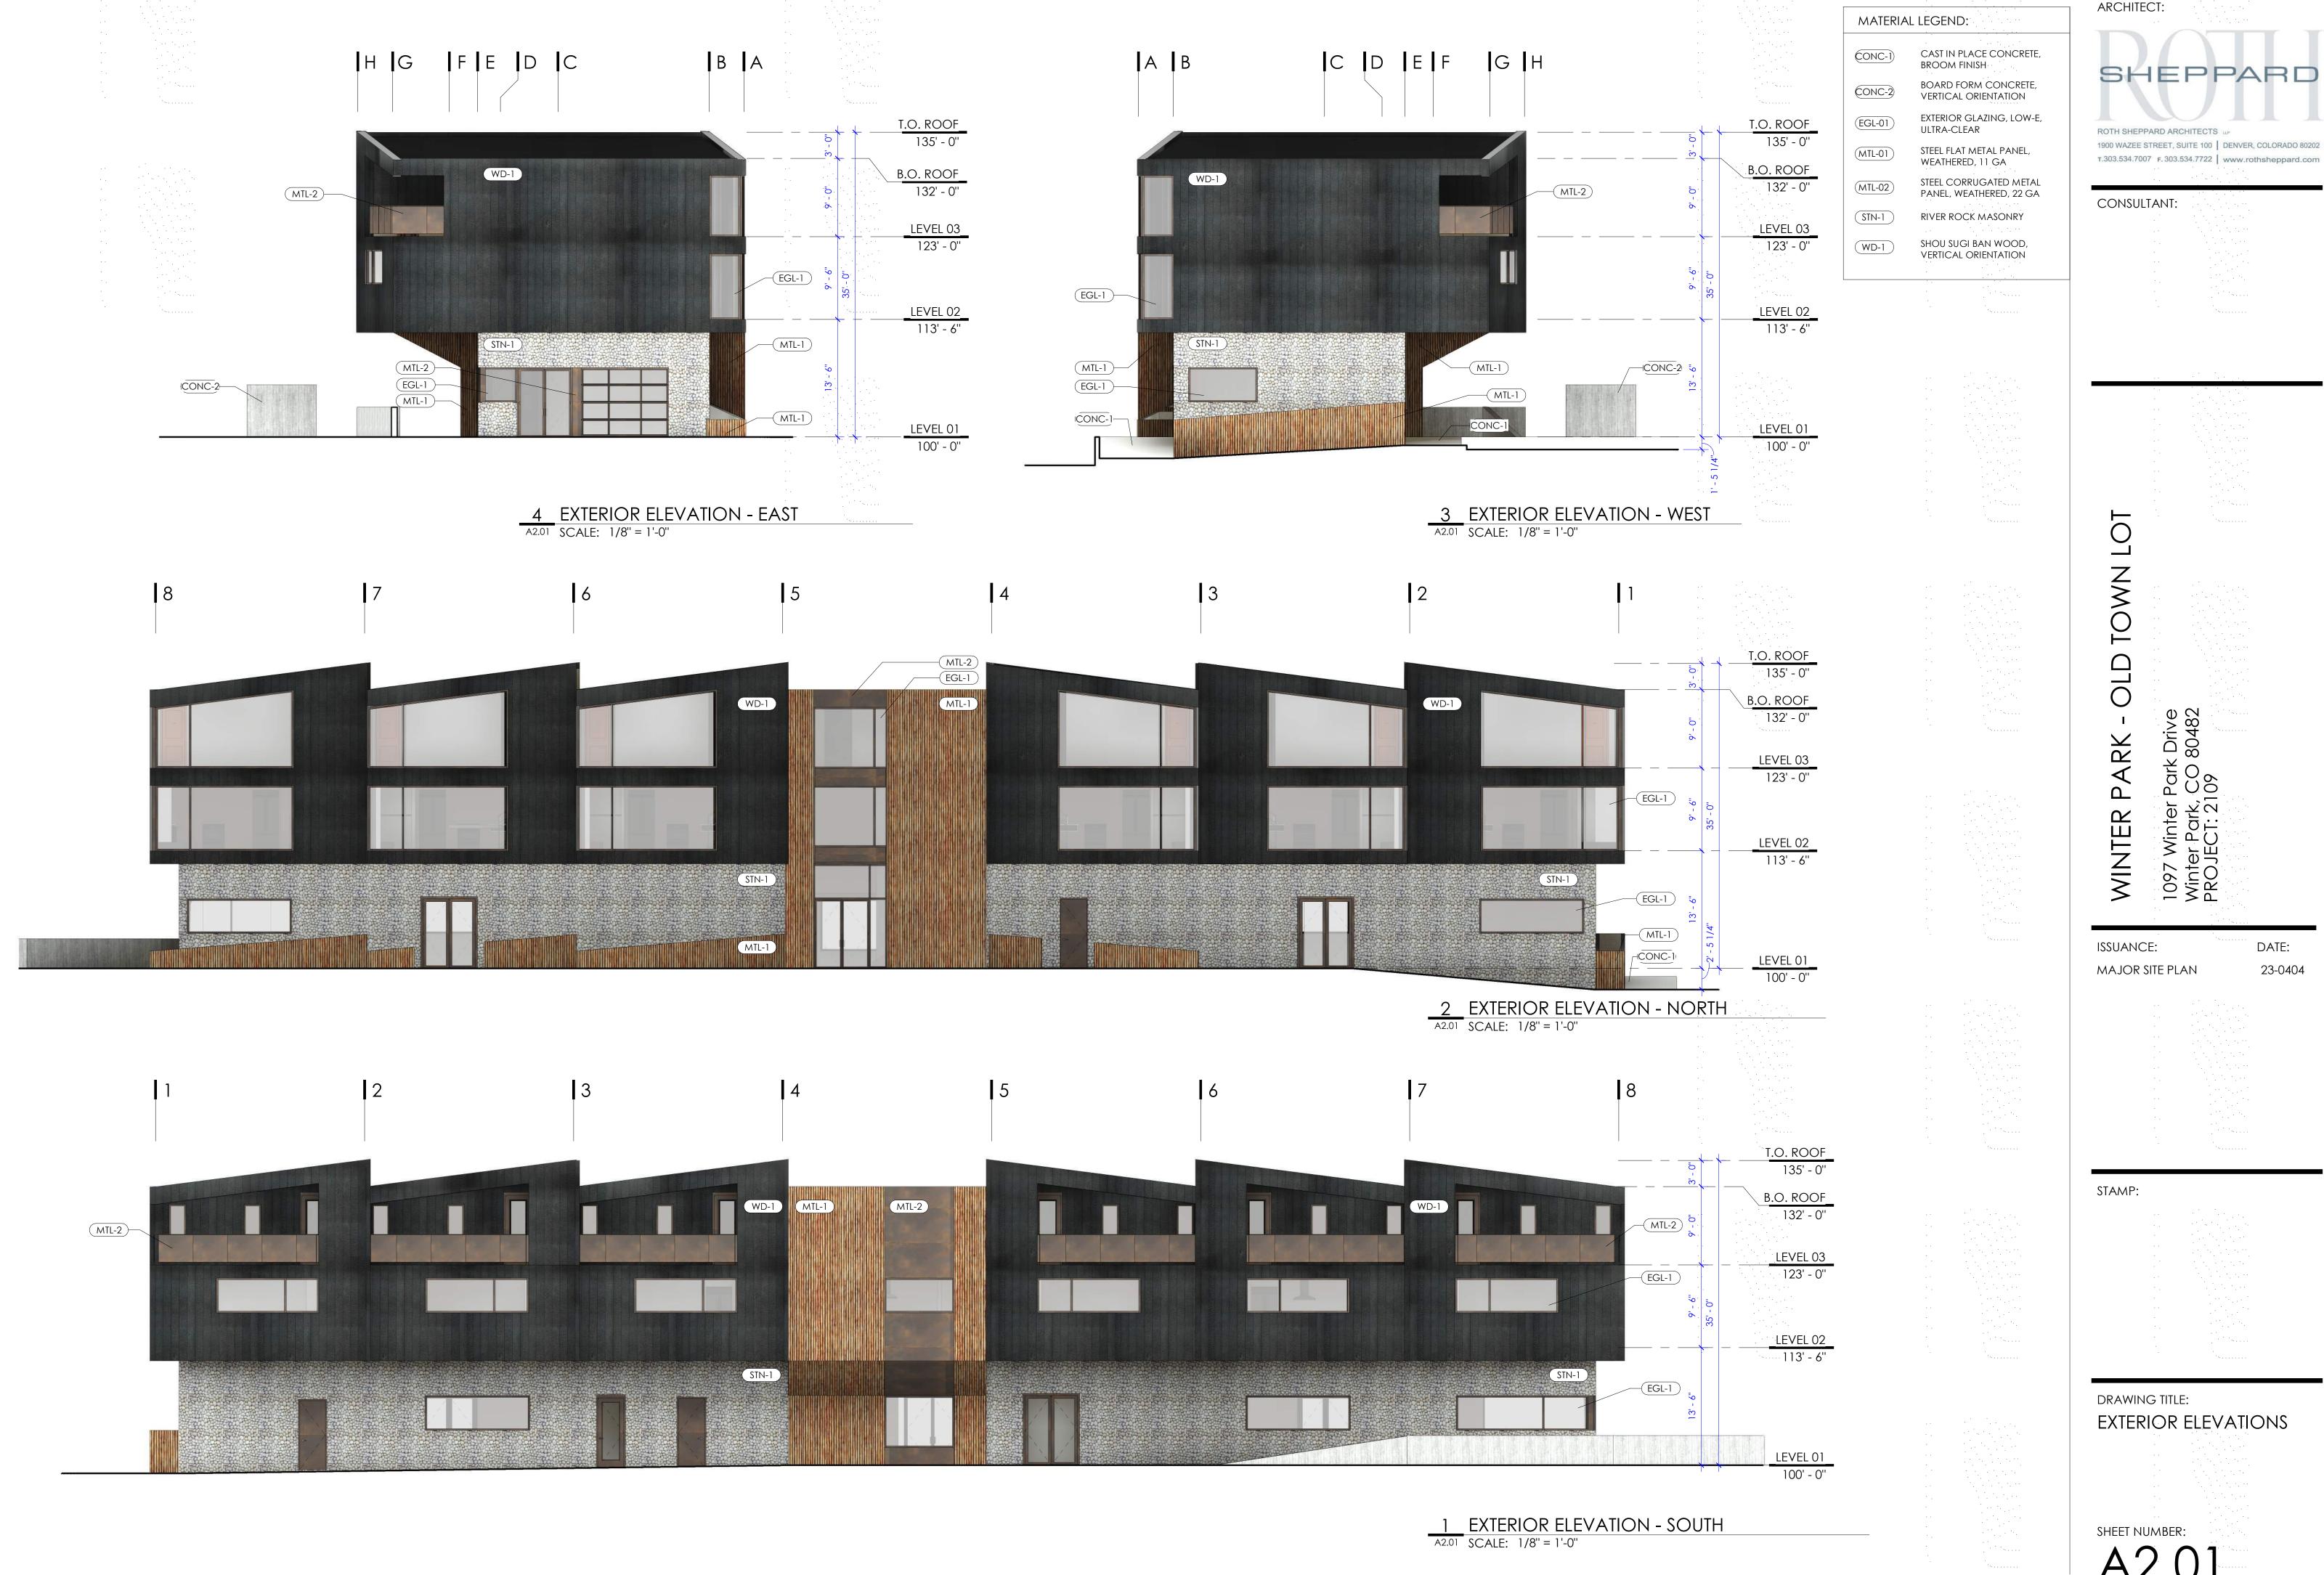

ARCHITECT:

SHEPPARD

1900 WAZEE STREET, SUITE 100 | DENVER, COLORADO 80202

CONSULTANT:

1097 Winter Park [ Winter Park, CO 8 PROJECT: 2109

ISSUANCE:

MAJOR SITE PLAN 23-0404

DATE:

DRAWING TITLE: EXTERIOR ELEVATIONS

# WINTER PARK - OLD TOWN LOT

MAJOR SITE PLAN
ISSUE DATE: 04/03/2023

1097 Winter Park Drive Winter Park, CO 80482 2128

## ITEM #6F - FLOOR PLANS

OWNER:

WHITE DEVELOPMENT, LLC

P: 303.506.5995

CONTACT: DEVIN VISCIANO

ARCHITECT:

ROTH SHEPPARD ARCHITECTS, LLP 1900 WAZEE STREET, SUITE 100 DENVER, CO 80202

P: 303.534.7007 F: 303.534.7722

ARCHITECT OF RECORD: ADAM HARDING, AIA MECHANICAL, ELECTRICAL AND PLUMBING ENGINEER:

RAMIREZ, JOHNSON & ASSOCIATES 3301 LAWRENCE ST. SUITE #2, DENVER, CO 80205

P: 720.598.0774

CONTACT: NATE MORRISON, E.I.

CIVIL ENGINEER:

PERSONALIZED ENGINEERING SOLUTIONS 9249 S. BROADWAY #200-388 HIGHLANDS RANCH, COLORADO 80129

P: 720.388.8126

CONTACT: STEPHEN DOUGLAS, PE

LANDSCAPE ARCHITECT:

NEILS LUNCEFORD, INC. P.O. BOX 2130 740 BLUE RIVER PARKWAY SILVERTHORNE, CO 80498

P: 970.468.0340

CONTACT: LAYLA LAZOUSKI



T.303.534.7007 F.303.534.7722 www.rothsheppard.com

CONSULTANT:

WINTE

ISSUANCE:

DATE: MAJOR SITE PLAN 23-0404


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DRAWING TITLE: OVERALL FLOOR PLAN -LEVEL 01

SHEET NUMBER:

OVERALL FLOOR PLAN - LEVEL 01

A1.01 SCALE: 1/8" = 1'-0"

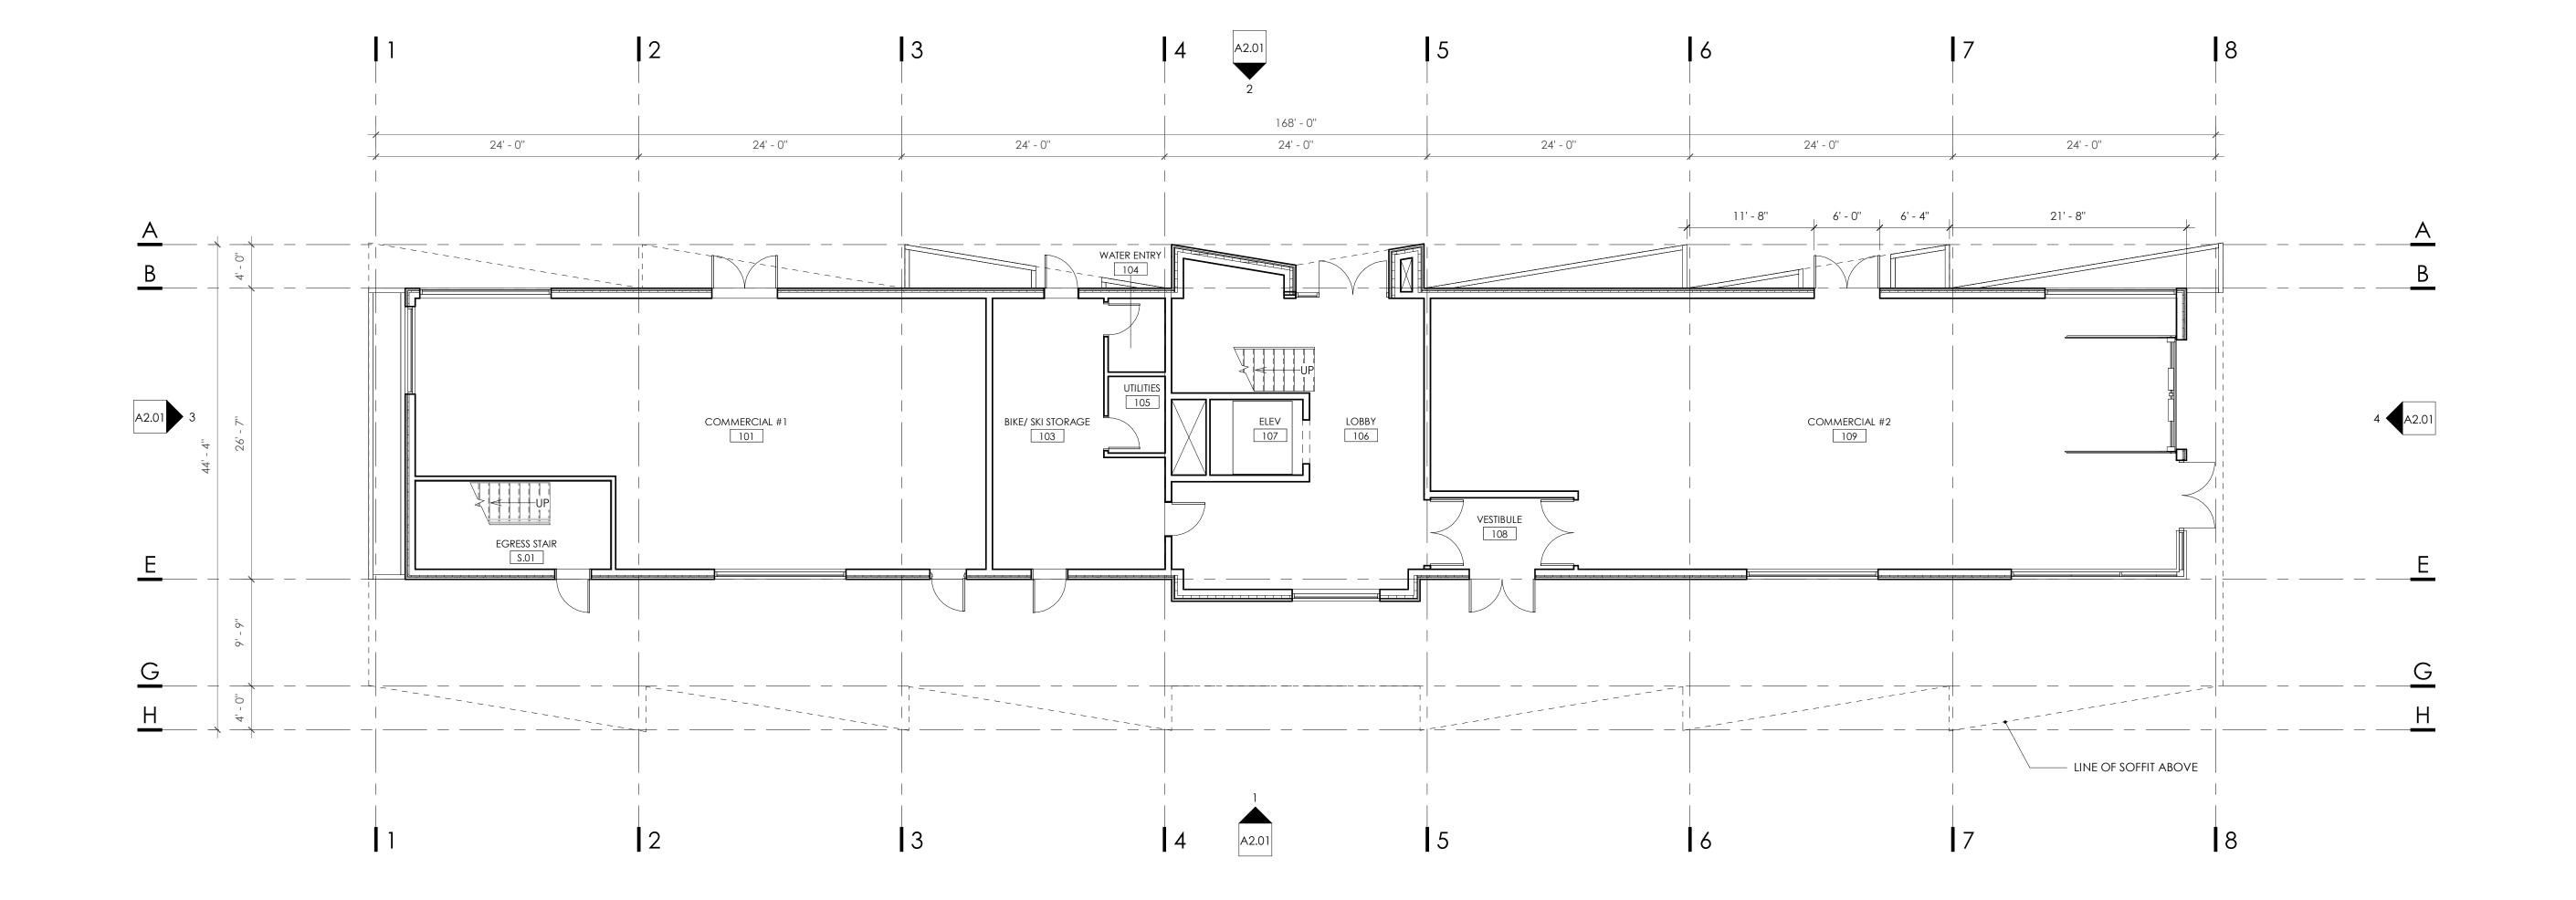

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CONSULTANT:

WINTE

ISSUANCE:


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STAMP:

1 OVERALL FLOOR PLAN - LEVEL 02

A1.02 SCALE: 1/8" = 1'-0"

DRAWING TITLE: OVERALL FLOOR PLAN -LEVEL 02

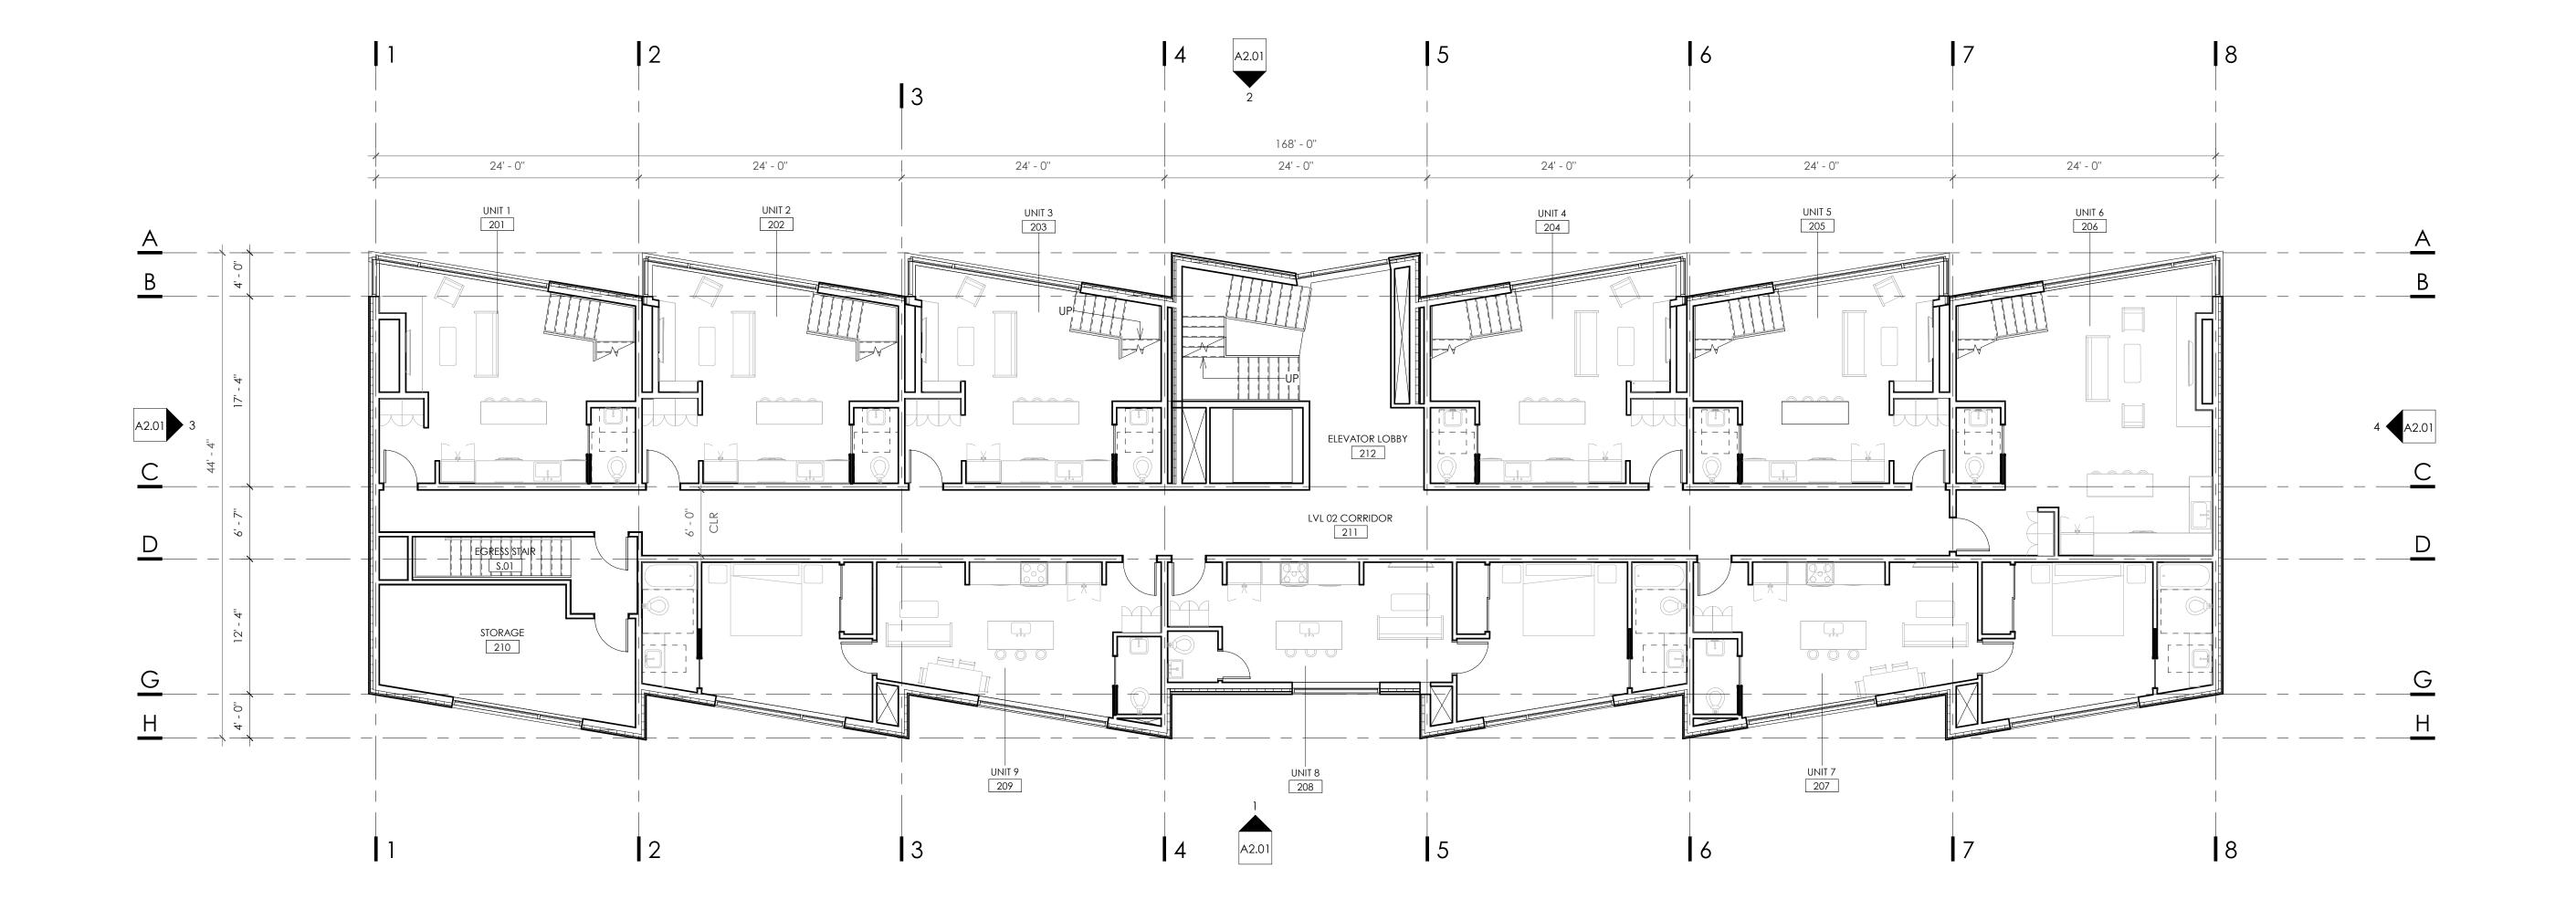

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CONSULTANT:

WINTER PARK - OLD TOWN L

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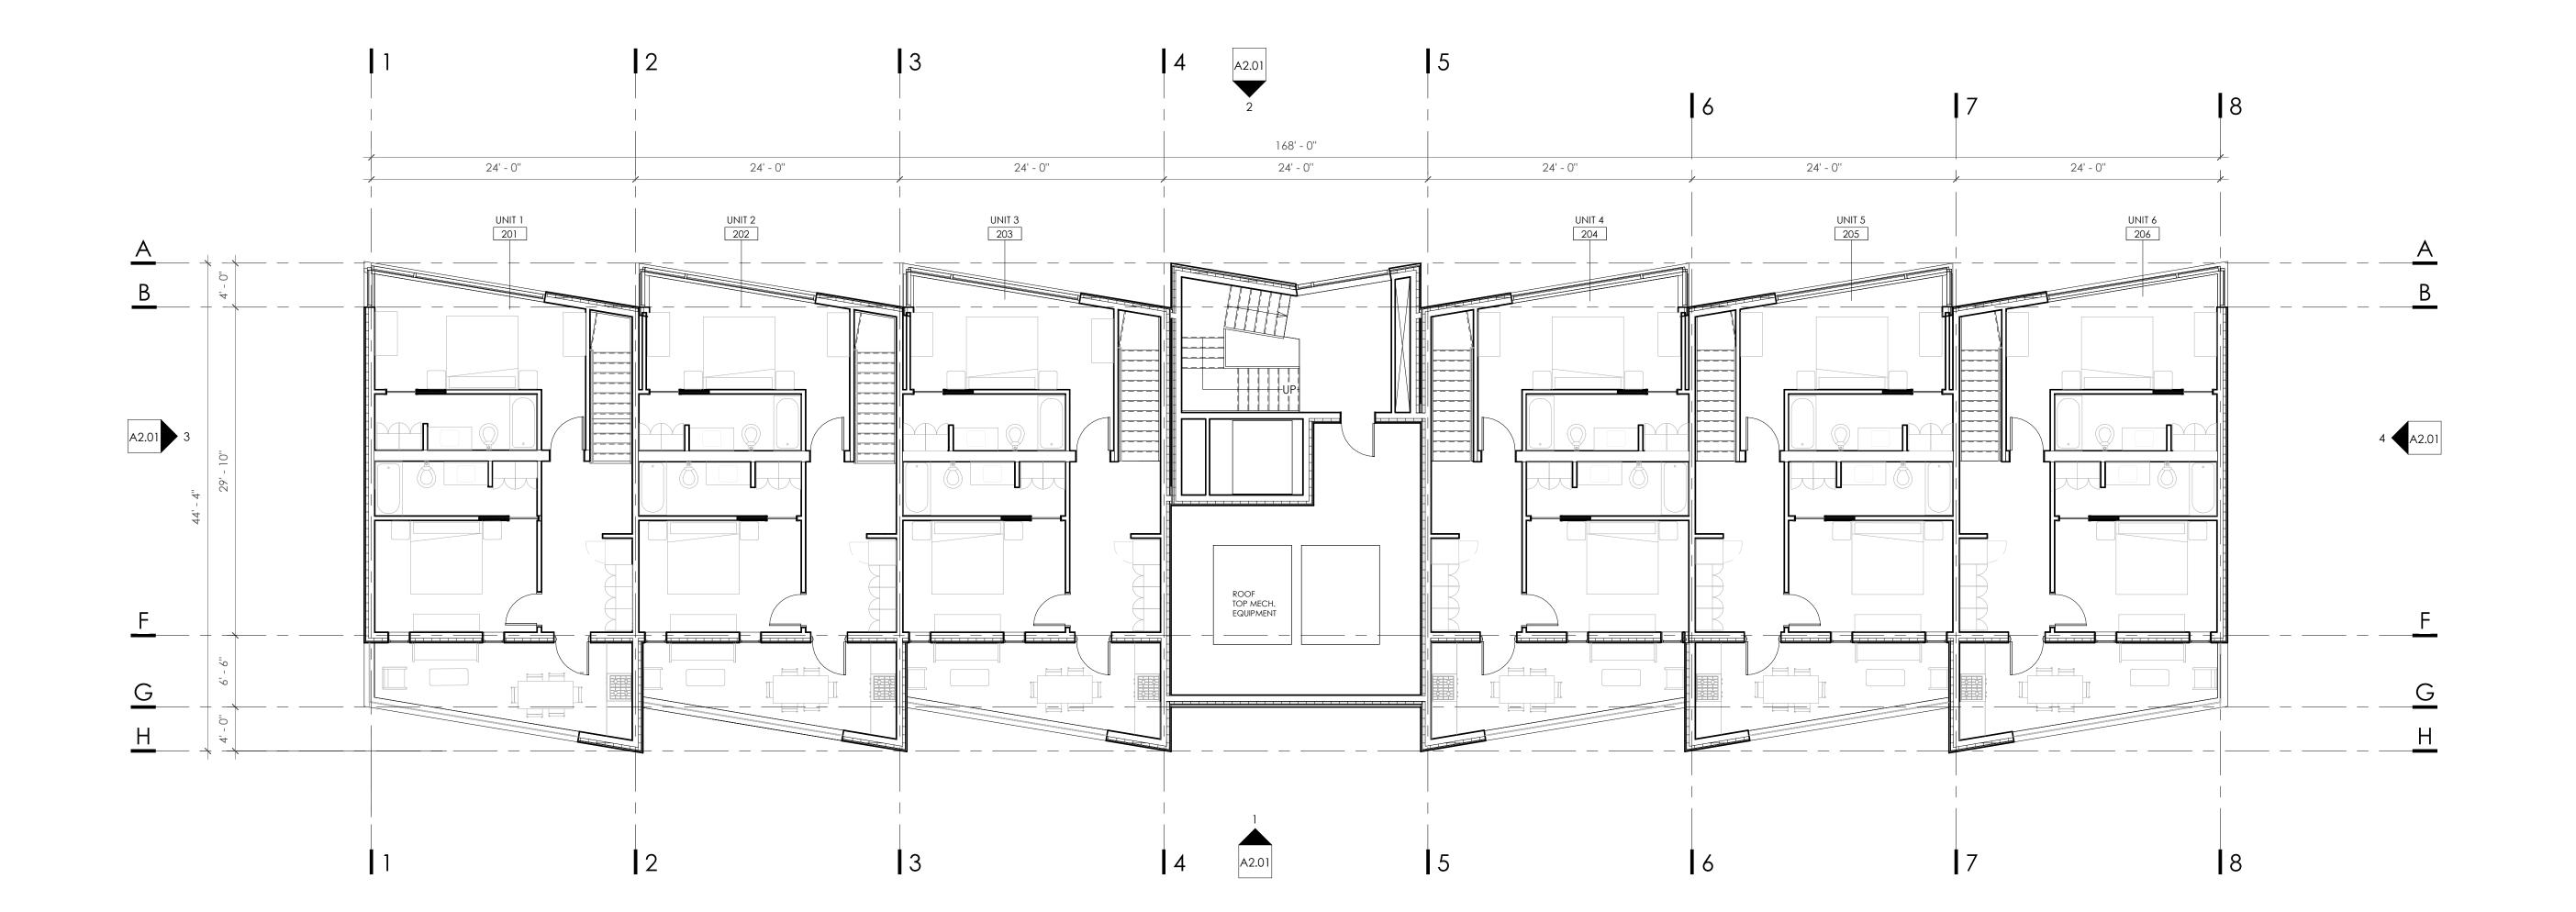
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1 OVERALL FLOOR PLAN LEVEL - 03
SCALE: 1/8" = 1'-0"

DRAWING TITLE:

OVERALL FLOOR PLAN LEVEL 03



- 1. RE: STRUCT FOR FOUNDATION WALL DIMENSIONS
- 2. TYP INTERIOR DIMS TAKEN FROM FACE OF GYP, UNLESS NOTED OTHERWISE
- 3. TYP EXTERIOR DIMS: <u>ALL-GLASS ENTRIES</u> - DIMS TO SYSTEM CL STOREFRONT - DIMS TO EXT FO FRAME (NOT INCLUDING EXTENDED MULLION CAP)

  <u>CLERESTORY</u> - DIMS TO EXT FO FRAME

  <u>STONE RAINSCREEN</u> - DIMS TO EXT FO STONE
- 4. REFER TO A0.04 A0.05 FOR PARTITION TYPES AND TYPICAL DETAILS; REFER TO A0.11 FOR MATERIALS AND FINISHES KEY; REFER TO A0.12 FOR EQUIPMENT AND FIXTURE SCHEDULES.
- 5. ALL LOCATIONS OF ELECTRICAL DEVICES, FIRE ALARM DEVICES, SECURITY DEVICES AND ACCESS PANELS SHALL BE VERIFIED IN THE FIELD WITH THE ARCHITECT PRIOR TO ROUGH-IN.
- 6. CONTRACTOR SHALL PROVIDE SLIP JOINTS AT ALL 10. REFER TO A5.31-A5.32 FOR EXTERIOR 3D PARTITIONS AND PARTITION BRACES ATTACHED TO ROOF AND/OR WALL STRUCTURAL ASSEMBLIES; REFER TO A0.04-A0.05.
- 7. DOOR OPENINGS NOT LOCATED BY DIMENSION SHALL BE LOCATED 4" FROM THE FINISHED WALL OR PARTITION TO OUTSIDE FACE OF FINISHED JAMB.
  - 8. THE CONTRACTOR SHALL PROVIDE AND INSTALL A CONTINUOUS COMPRESSIBLE JOINT FILLER AT THE INTERIOR SLAB / GRADE PERIMETER AND AT INTERIOR COLUMN BLOCK-OUTS; 1/2" WIDTH.
- 9. ALL SLAB ON GRADE JOINTS, INCLUDING SLAB PERIMETER JOINTS, SHALL BE FILLED WITH SEALANT; SEALANT COLOR TO BE VERIFIED WITH ARCHITECT FOR ALL JOINTS EXPOSED TO VIEW.
- AXONOMETRIC VIEWS.

1 T.O. ROOF

A1.21 SCALE: 1/8" = 1'-0"

11. REFER TO A0.13 FOR EXTERIOR AND INTERIOR WINDOW SCHEDULES

CONSULTANT:

ARCHITECT:

SHEPPARD

1900 WAZEE STREET, SUITE 100 | DENVER, COLORADO 80202

T.303.534.7007 F.303.534.7722 www.rothsheppard.com

ROTH SHEPPARD ARCHITECTS LLP

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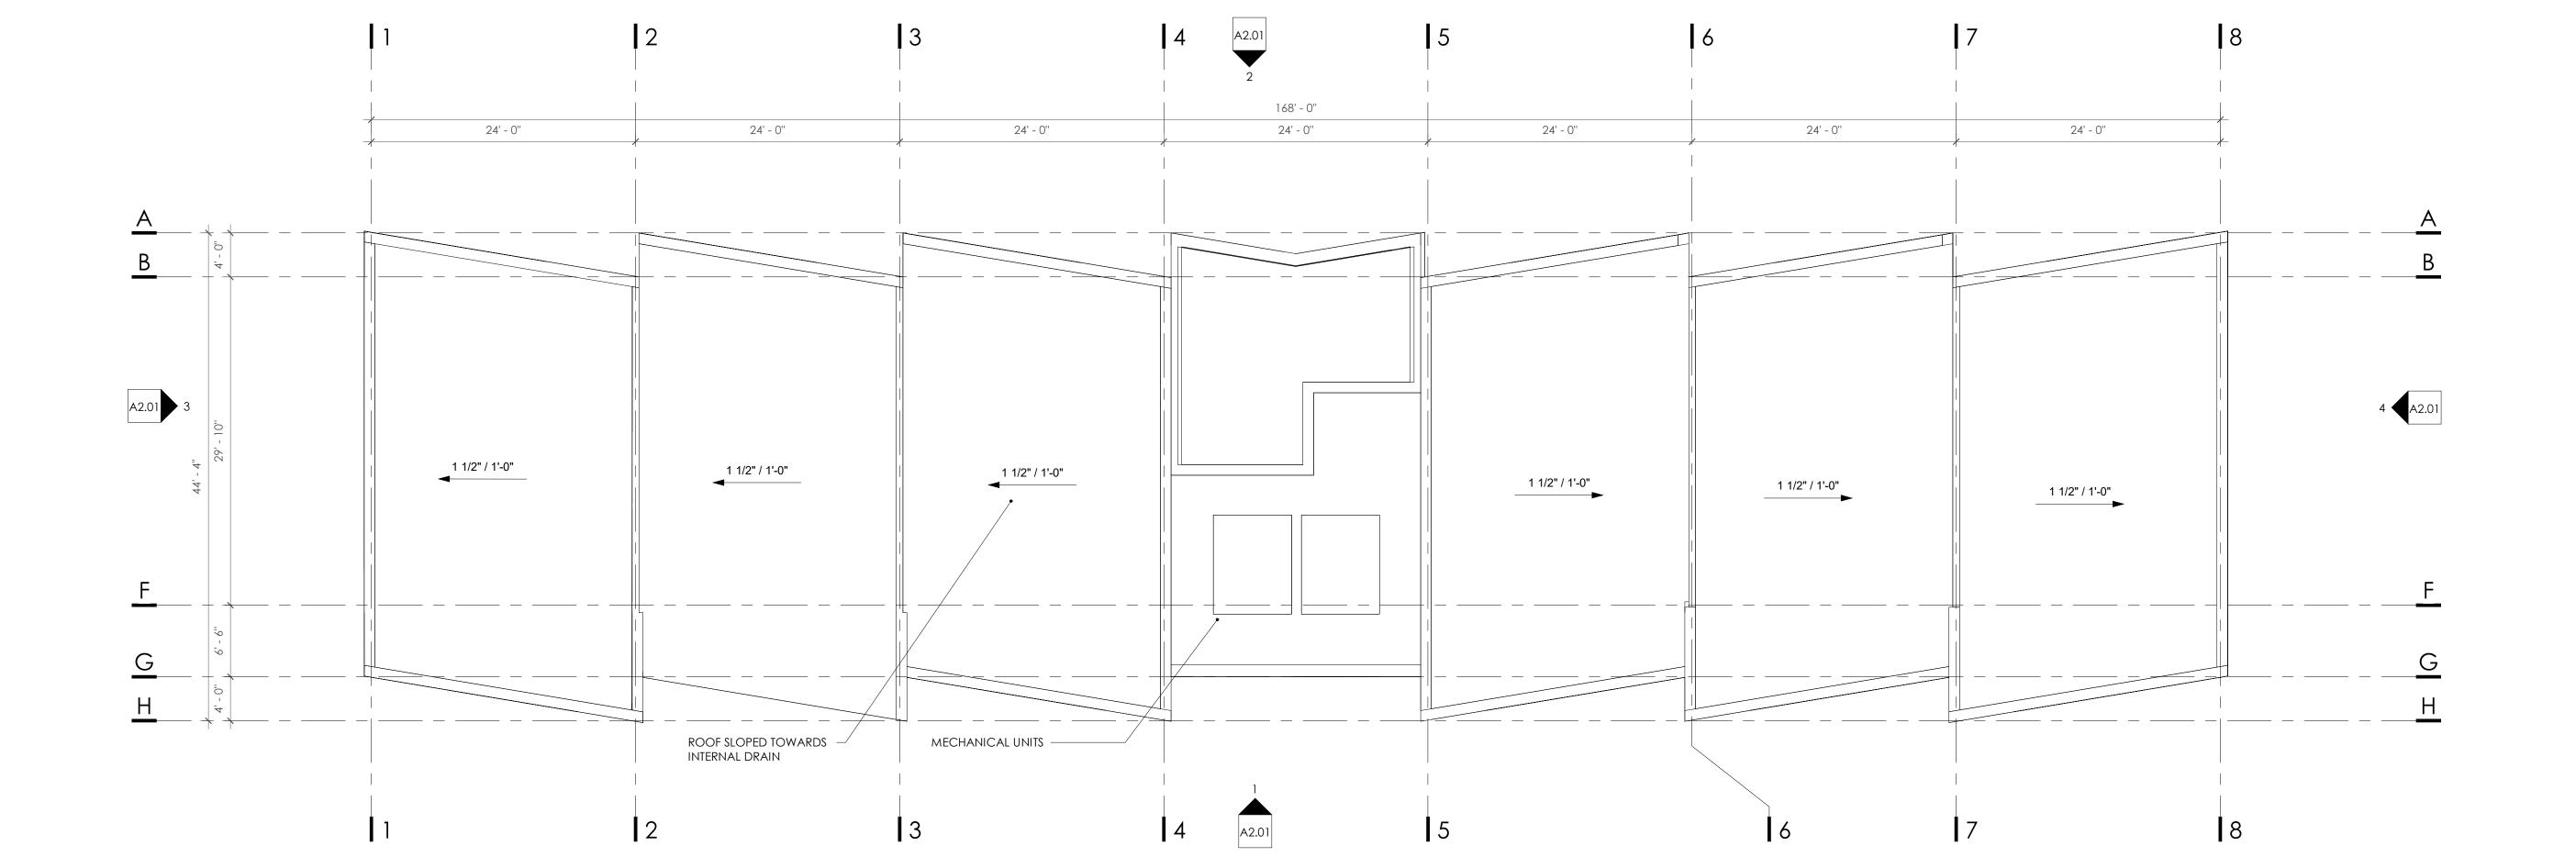
ISSUANCE: MAJOR SITE PLAN

DATE:

23-0404

STAMP:

DRAWING TITLE: ROOF PLAN



# WINTER PARK - OLD TOWN LOT

MAJOR SITE PLAN
ISSUE DATE: 04/03/2023

1097 Winter Park Drive Winter Park, CO 80482 2128

## ITEM #8 - RENDERINGS

OWNER:

WHITE DEVELOPMENT, LLC

P: 303.506.5995

CONTACT: DEVIN VISCIANO

ARCHITECT:

ROTH SHEPPARD ARCHITECTS, LLP 1900 WAZEE STREET, SUITE 100 DENVER, CO 80202

P: 303.534.7007 F: 303.534.7722

ARCHITECT OF RECORD: ADAM HARDING, AIA MECHANICAL, ELECTRICAL AND PLUMBING ENGINEER:

RAMIREZ, JOHNSON & ASSOCIATES 3301 LAWRENCE ST. SUITE #2, DENVER, CO 80205

P: 720.598.0774

CONTACT: NATE MORRISON, E.I.

CIVIL ENGINEER:

PERSONALIZED ENGINEERING SOLUTIONS 9249 S. BROADWAY #200-388 HIGHLANDS RANCH, COLORADO 80129

P: 720.388.8126

CONTACT: STEPHEN DOUGLAS, PE


LANDSCAPE ARCHITECT:

NEILS LUNCEFORD, INC. P.O. BOX 2130 740 BLUE RIVER PARKWAY SILVERTHORNE, CO 80498

P: 970.468.0340

CONTACT: LAYLA LAZOUSKI



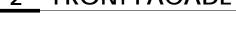



1 SE PERSPECTIVE

ARCHITECT:

SHEPPARD

ROTH SHEPPARD ARCHITECTS LLP 1900 WAZEE STREET, SUITE 100 | DENVER, COLORADO 80202 T.303.534.7007 F.303.534.7722 | www.rothsheppard.com

CONSULTANT:


ISSUANCE:

MAJOR SITE PLAN

DATE: 23-0404

STAMP:

DRAWING TITLE: EXTERIOR PERSPECTIVES

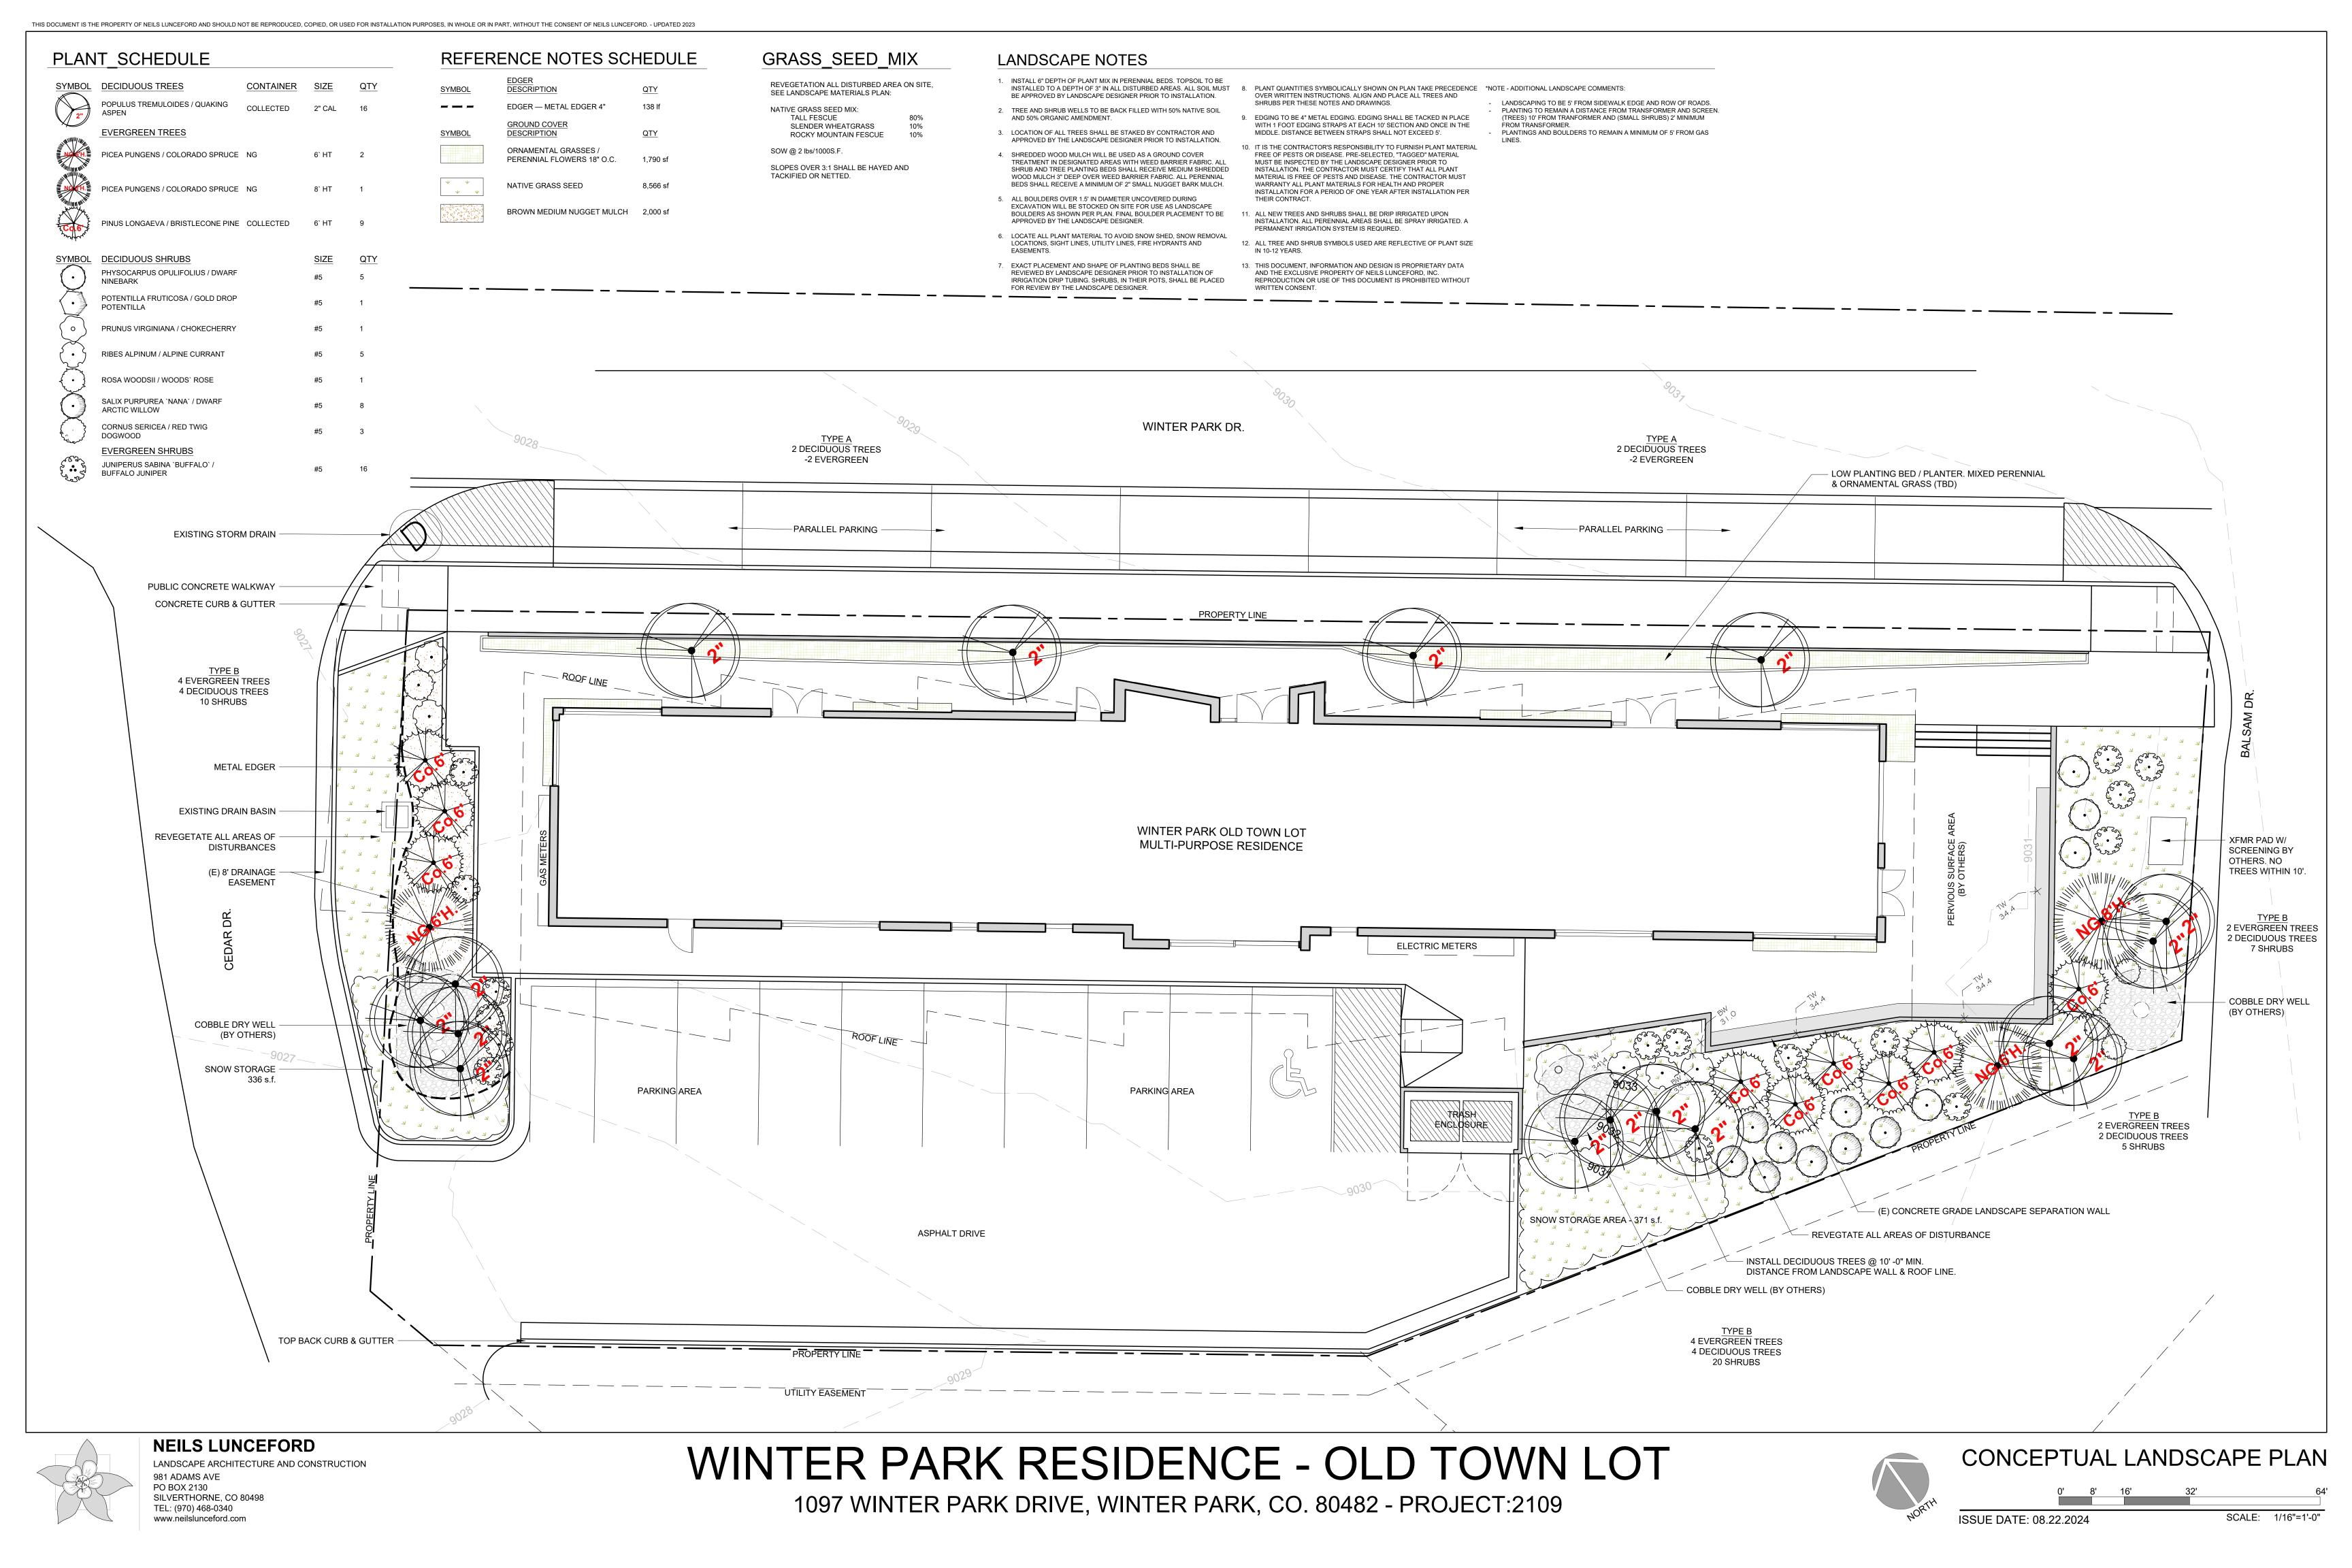

		MANUFACTURER														
TYPE	DESCRIPTION	OR APPROVED	CATALOG SERIES NUMBER	LAMPS,	INPUT	LUMENS	VOLTAGE	MOU	NITNL	IG	AREA	NOTES				
		EQUIVALENT	OR APPROVED EQUIVALENT	CCT	VA			R	S	P V	SERVED					
E1	LED TAPE LIGHT, RECCESED ALUMINUM CHANNEL WITH LENS,	BEULUX	V-L90-IP66-CT30-SEE PLANS	LED	0.65 /	70 /	120	Х			PERIMETER					
	WALL WASH, IP66, MOUNTED AT CEILING/OVERHANG OF LEVEL 1		JE99-SL	3000K	FT	FT										
E2	4" SQUARE DOWNLIGHT, LED, WET LISTED, MOUNTED IN CEILING/	PRESCOLITE	LTR-4SQD-H-SL-06L-DMT	LED	6	292	120	Х			PERIMETER					
	OVERHAND OF LEVEL 1		LTR-4SQD-T-SL-27K-9-WD-S	3000K												
EP	PEDESTRIAN POLE, 14' HEIGHT, TYPE 2 OPTICS	KIM LIGHTING	UR20-24L-CUSTOM-3K7-2-UNV-AD-04	LED	20	862	120		Х		PARKING/DRIVE					
				3000K												
(RL)	SIDEWALK/ROADWAY PEDESTRIAN POLE - RELOCATED	EXISTING	EXISTING	LED	75	7500	120		Х		SIDEWALK					
				4000K												
ABBRE	VIATIONS: BF - BOTTOM OF FIXTURE; OH - OVERALL FIXTURE HEIGHT; RD - RECESS	SED FIXTURE DEPTH; A	AFF - ABOVE FINISHED FLOOR						ABBREVIATIONS: BF - BOTTOM OF FIXTURE; OH - OVERALL FIXTURE HEIGHT; RD - RECESSED FIXTURE DEPTH; AFF - ABOVE FINISHED FLOOR							

PHOTOMETRIC PLAN

GENERAL NOTES:

A. LUMINAIRE SHOWN WITH CATALOG NUMBERS ARE THE BASIS OF DESIGN. SIMILAR BY OTHER LISTED MANUFACTURERS ARE ACCEPTABLE.

B. CONTRACTOR TO VERIFY LIGHT FIXTURE CATALOG NUMBER AND INSTALLATION REQUIREMENTS PRIOR TO ORDERING.

C. VERIFY TRIM COMPATIBILITY WITH CEILING TYPE PRIOR TO SUBMITTALS.

**GENERAL NOTES** 

A. NO SUBSTITUTIONS, ADDITIONS, OR CHANGES MAY BE MADE WITHOUT PRIOR APPROVAL BY WINTER PARK.

B. PRIOR TO ISSUING A CERTIFICATE OF OCCUPANCY THE CITY MAY REQUIRE CERTIFICATION THAT THE PROPERTY IS COMPLIANT WITH THE APPROVED PLANS AND REGULATIONS OF THE CITY.

ALL CALCULATIONS ARE DONE WITH LIGHT LOSS FACTOR OF 0.9.

D. ALL CALCULATION POINTS ARE AT GRADE.

ANY PROPOSED LIGHT FIXTURES INSTALLED ON PRIVATE PROPERTY, ADJACENT TO THE RIGHT OF WAY, SHALL BE ORIENTED IN SUCH A MANNER OR LIMITED IN LUMEN OUTPUT TO PREVENT GLARE PROBLEMS AND SHALL NOT EXCEED NATIONAL IES LIGHTING STANDARDS FOR DISABILITY GLARE.

ALL OUTDOOR LIGHTING SHALL HAVE LIGHT SOURCES THAT ARE CONCEALED BY A FULL CUTOFF LIGHTING FIXTURE SO THAT THE LIGHT SOURCE IS NOT VISIBLE FROM ANY STREET RIGHT-OF-WAY OR ADJACENT PROPERTIES. IN ORDER TO DIRECT LIGHT DOWNWARD AND MINIMIZE THE AMOUNT OF LIGHT SPILL INTO THE NIGHT SKY AND ONTO ADJACENT PROPERTIES, ALL LIGHTING FIXTURES SHALL BE FULL CUTOFF LIGHTING FIXTURES.

. SIGNAGE LIGHTING SHALL BE APPROVED AS PART OF A SEPARATE SIGN PERMIT.

. LUMINAIRES SHALL BE SHIELDED AND DIRECTED TO AVOID GLARE AND OVERSPILL ONTO ADJACENT PROPERTY.

ALL EXTERIOR LIGHT FIXTURES SHALL BE FULL CUTOFF FIXTURES THAT ARE DIRECTED DOWNWARD (90 DEGREES FROM TRUE VERTICAL) AND SHALL HAVE FLAT LENSES, EMITTING NO MORE THAN 10 PERCENT OF THE TOTAL LUMENS BETWEEN 80 AND 90 DEGREES FROM TRUE VERTICAL. FIXTURES SHALL BE CONFIGURED SO THAT LIGHTS DO NOT CAUSE GLARE.

ALL LUMINAIRES TO HAVE ADAPTIVE CONTROLS THAT DIM LIGHT LEVELS BY A MINIMUM OF 50% AFTER 11:00PM.

K. EXISTING ROADWAY/PATHWAY POLE LUMINAIRE TO BE RELOCATED AS INDICATED. LIGHTING CALCULATIONS DO NOT INCLUDE THIS LUMINAIRE.

KEY NOTES

(THIS SHEET)

(THIS SHEET)

1. EXISTING POLE LUMINAIRE TO BE RELOCATED AND MOUNTED ON ELEVATED BASE TO ILLUMINATE NEW SIDEWALK. ILLUMINANCE LEVELS ARE APPROXIMATE BASED ON AS-BUILT DATA. NEW INSTALLATION TO MATCH EXISTING ROADWAY LIGHTING TO GREATEST EXTENT POSSIBLE. LIGHT LEVELS FOR THIS LUMINAIRE ARE NOT INCLUDED IN SITE LIGHTING STATISTICS.

RK - OLD TOWN

ARCHITECT:

ROTH SHEPPARD ARCHITECTS

CONSULTANT:

Ramirez,

Johnson, &

**A**ssociates

3301 Lawrence St. Ste 2

Denver, CO 80205

P: 720.598.0774

SHEPPARD

1900 WAZEE STREET, SUITE 100 | DENVER, COLORADO 80202 T.303.534.7007 F.303.534.7722 | www.rothsheppard.com

WINTER PA 1097 Winter Par Winter Park, CC


SUANCE:

MAJOR SITE PLAN

DATE:

DRAWING TITLE:
PHOTOMETRIC
PLAN

SHEET NUMBER:

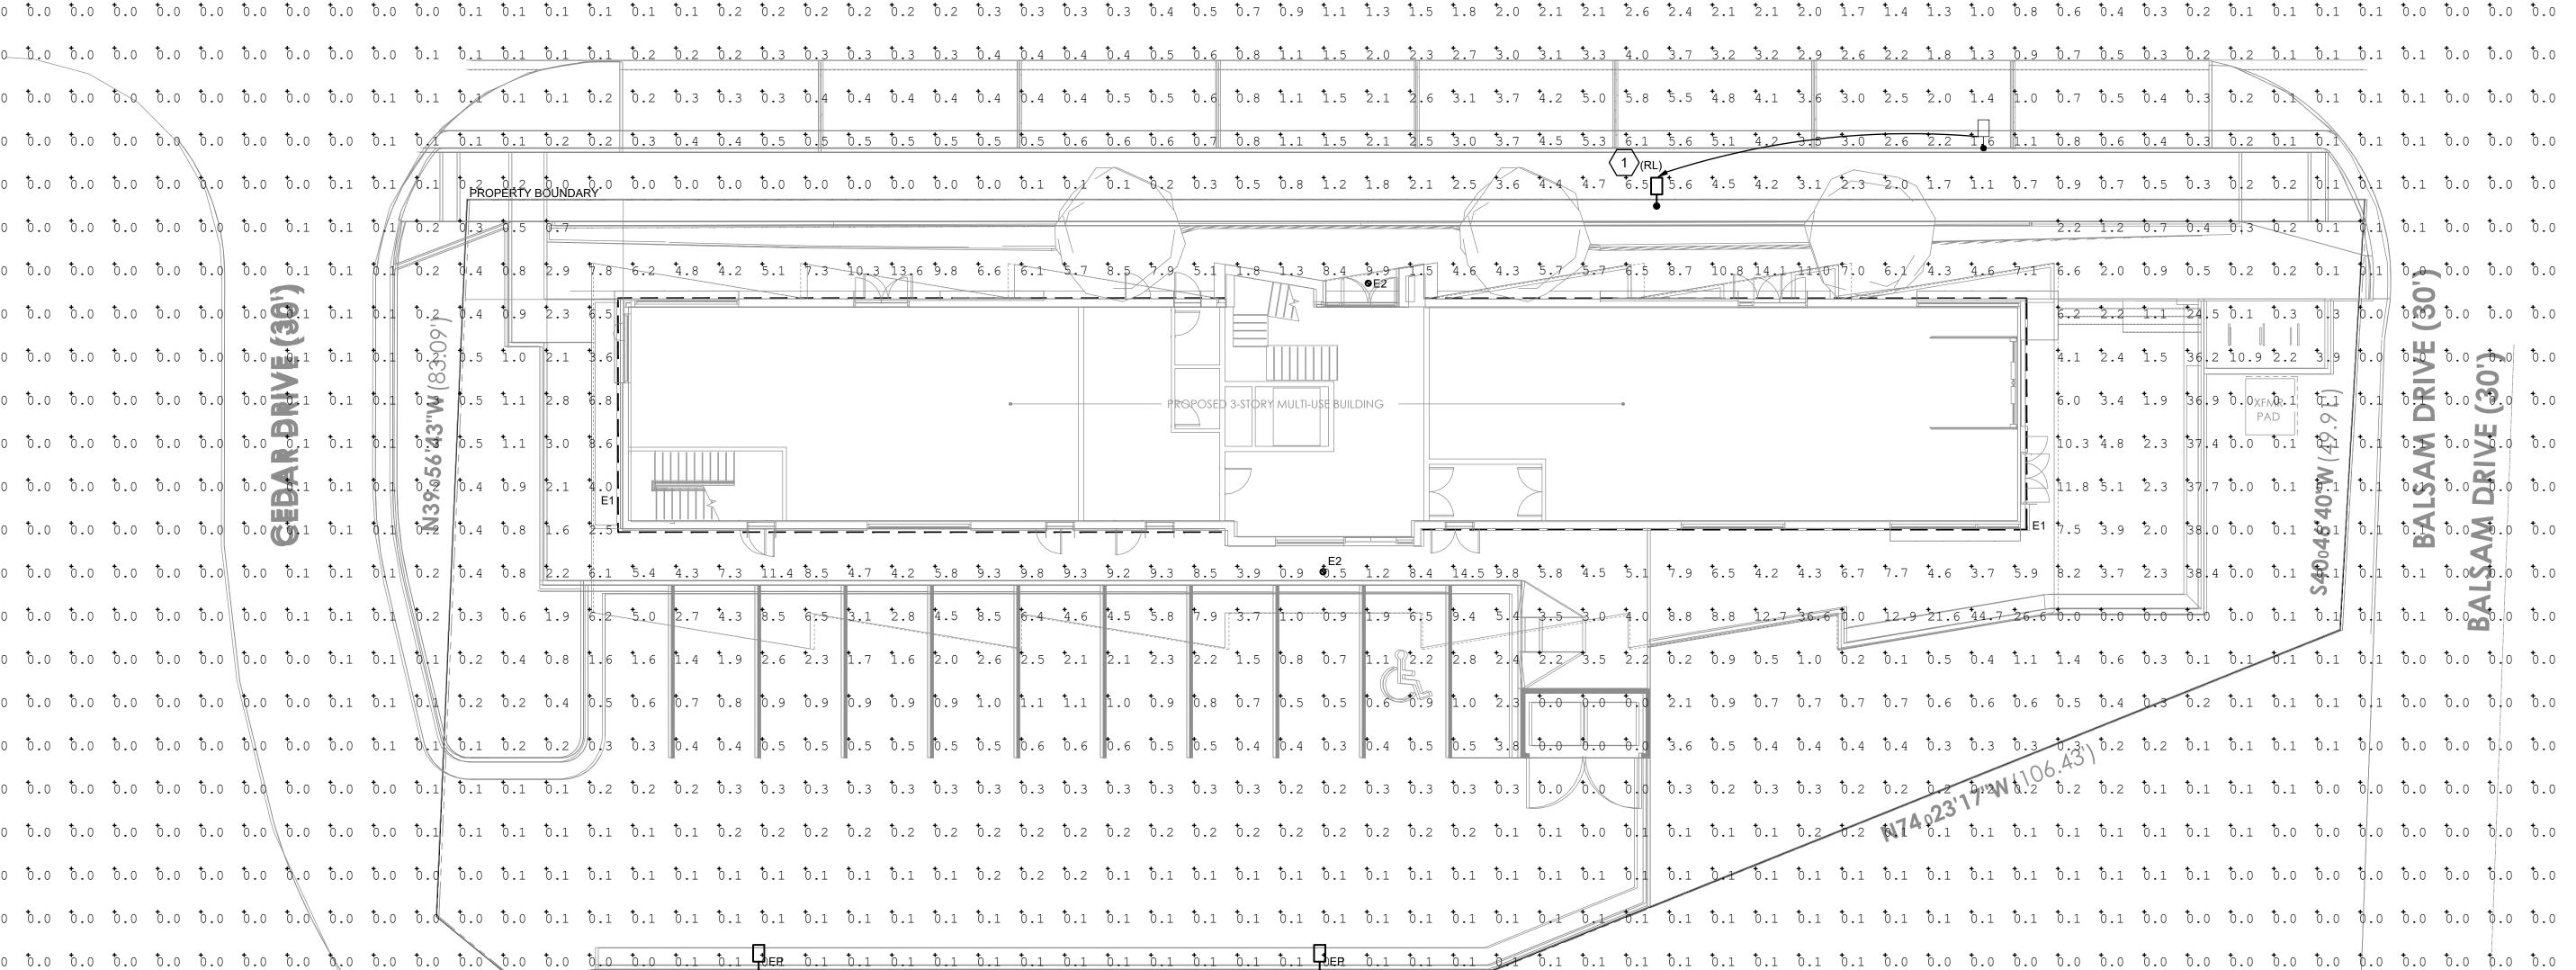


SITE LIGHTING STATISTICS

AVERAGE(fc) MAXIMUM(fc) MINIMUM(fc) MAX./MIN. AVERAGE/MIN

 OVERALL SITE
 0.56
 2.2
 0.0
 N/A
 N/A

 PROPERTY LINE
 0.07
 0.4
 0.0
 N/A
 N/A


 PARKING AREA
 0.3
 0.8
 0.2
 4:1
 1.5:1

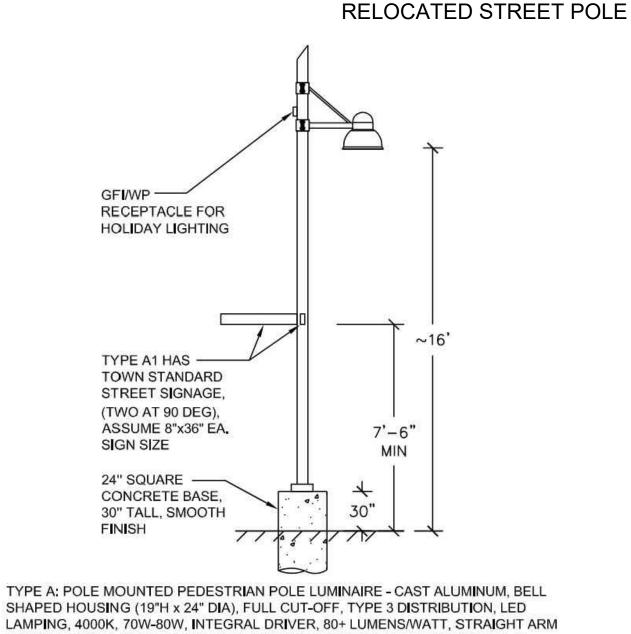


SHAPED HOUSING (19"H x 24" DIA), FULL CUT-OFF, TYPE 3 DISTRIBUTION, LED LAMPING, 4000K, 70W-80W, INTEGRAL DRIVER, 80+ LUMENS/WATT, STRAIGHT ARM MOUNTED WITH ANGLED SUPPORT ARM DECORATIVE CLAMP MOUNT TO A 4" SQUARE NON-TAPERED POLE. MOUNTED TO A 24" SQUARE CONCRETE BASE, 30" TALL. PROVIDE POLE LENGTH TO ACHIEVE BOTTOM OF LUMINAIRE HEAD AT 16' AFG.

## Type A & A1 Pedestrian Pole Elevation

Scale: N.T.S.

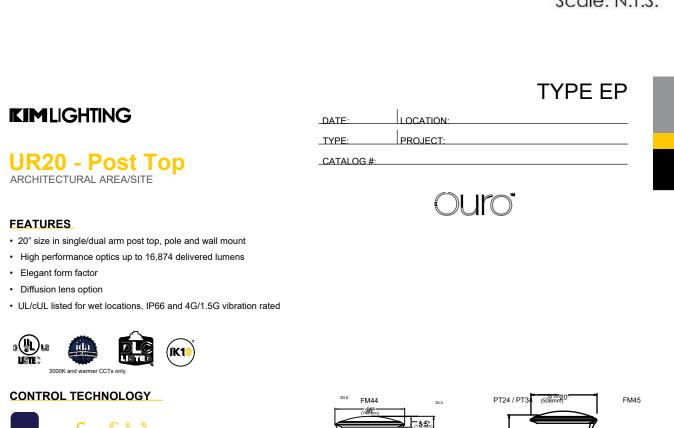

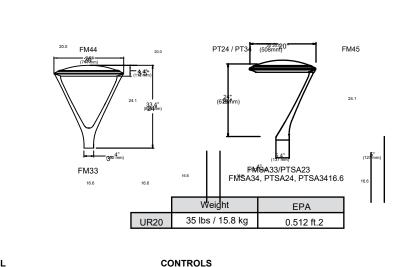

7PRFully gasketed and wired 7-pin receptacle

allows for a user-defined interface

control module by-others.

Standard customer operation modes:

5-pin wireless photoelectric control

for added dimming feature.

Traditional on/off photoelectric control.

7-pin wireless photoelectric control for

dimming and additional I/O connections for

Page 1 of 15

Rev 01/31/24

kl\_ur20post\_spec\_R07

**Current ©** 

and provides a controlled definition of

operational performance. ANSI twist-lock

electrical compartment. 7-pin construction

· All external fasteners are stainless steel. Universal voltage, 120 through 277V with a ±10% tolerance. Driver is Underwriters Laboratories listed. LEDs mount to a metal printed circuit board • High voltage configurations, 347/480. Driver has a 0-10V dimming interface for multi-level · Optical lenses are clear injection molded illumination options. Driver is Underwriters

40°C ambient environments.

currentlighting.com/kimlighting

Luminaire shall be capable of operating at

protection that will dim the luminaire upon

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100% brightness in a 40°C environment. Both

driver and optical array have integral thermal

detection of temperatures in excess of 85°C.

PMMA acrylic. Laboratories listed. Optional Backlight Control on each LED · "Thermal Shield". secondary side, thermistor module to completely control unwanted provides protection for the sustainable life of LED module and electronic components Optional fixture finish optical surfaces will not Drivers shall have greater than a 0.9 power exceed BUG ratings of the standard white factor, less than 20% harmonic distortion, and be suitable for operation in -40°C to

LENS
• Standard lens (CLR) IK08 Clear Polycarbonate Lens (CP) IK10

**FEATURES** 

**SPECIFICATIONS** 

designed as one-piece.

provides ingress protection.

assembly (MCPCB).

personal injury.

Current ©

Low copper aluminum alloy die-casting is

Molded silicone gasket throughout insures the

sealing between the two compartments and

CONSTRUCTION

 Fixtures must be grounded in accordance with national, state and/or local electrical codes.

• Surge protection: 10,000k in parallel, 20,000k in series • Wiring: No. 18AWM rated 105°C, wet rating. (Specifications continued on page 5)

## TYPE E1 CHANNEL

JE08 | Recessed Extrusion

BEULUX

Handrail

Vanity

Shelf

■ Furniture

Transition Wall/Ceiling


Hallways

Millwork

■ Narrow Spaces

Under Cabinet

The JE08 is a small recessed extrusion, built using high quality anodized aluminum. This extrusion offers great heat dissipation qualities make it best suited for the low- medium output tape light range. The JE line is known for its size and versatility in applications, which can help facilitate the project specification process.

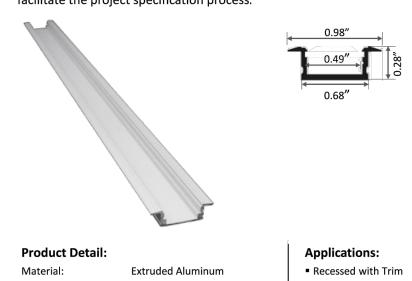

**Anodized Silver** 

Customization:

L 78.74" x W 0.98" x H 0.28"

Cut to specified length

	<u>'</u>	
Compatible Lens		
JE99-CL	JE99-SL	JE99-DL
Clear Lens	Satined Lens	Satined Drop

## www.Beulux.com 408-661-2367 **KIMLIGHTING** PROJECT: ARCHITECTURAL AREA/SITE **ORDERING GUIDE** Example: UR20-24L-25-3K8-3-L-UNV-FMSA33-BLT-7PR-BC

UR20					
Model	LED Engine	CCT/CRI	Distribution	Rotation	Voltage
UR20 Ouro No	24L-25 3,000 lm 24L-25 3,000 lm 24L-65 7,000 lm 56L-75 10,000 lm 56L-110 15,000 lm 56L-140 17,000 lm HDL - High Diffusion Len 28L-30 3,000 lm 28L-70 7,000 lm 68L-80 9,000 lm 68L-115 13,000 lm	AM 1.2 Amber, 595nm 27K8 2700K, 80 CRI 3K7 3000K, 70 CRI 3K8 3000K, 80 CRI 35K8 3500K, 80 CRI 3K9 3000K, 90 CRI 4K7 4000K, 70 CRI 4K8 4000K, 80 CRI 5K7 5000K, 70 CRI Consult factory for other CCTs and CRIs	No Lens or Clear Lens FR Type 1/Front Row 2 Type II 3 Type III 4 Type IV 4W Type IV Wide 50M 3 Type V Square Mediun 50N 3 Type V Square Narrow 5R 3 Type V Wide (Round) HDL - High Diffusion Lens 3 Type III/Asymmetric 5W 3 Type V/Symmetric		347 347V 480 480V

Mounting		Fixture Finish	Control Options		Options		Control Acce	
	tixture base	BLS Black Gloss Smooth	7PR-TL	7 pin PCR with twist lock photocol	ntrol BC 9	Back-light Control	WIR-RME-L	LightGRID+TM External Fixtu
FM44	Flush mt 3.6" to 4.0" O	BLT Black Matte Textured DBS Dark Bronze Gloss	7PR-SC	7 pin PCR with shorting cap	SF	Single Fuse		Module
D-T-0-0	3" Post Top mount for	5 Smooth	7PR	7 pin PCR, wireless control enable	DF CLR 8,9,10	Double Fuse Clear Lens	SCH-R	Occ. Sensor for Round Pole
	Tenon 4" Post Ton mount for	DBT Dark Bronze Matte Textured GTT Graphite Matte Textured	AD-016 AD-02 6	AstroDIM: 50% output at midnight AstroDIM: 50% output midnight to		Tamper proof latch Clear	SCH-S	(up to 30' MH Occ. Sensor f Square Pole
	2 3/8" OD T x 4" Long	LGS Light Grey Gloss		4 AM	CP 8,9,11	Polycarbonate		(up to 30' MH)
PT34	I CHOH	Smooth	AD-03 6	AstroDIM: 50% output 10PM		Lens	NXOFM- 1R1D-UNV	NX 7-Pin Twis
	7/8" OD x 4" Long Ten	TLGT Light Grey Matte Textured	AD-04 6	AstroDIM: 50% output 10PM to 44	(MVBFM3	Wall Bracket Arm for FM33		Networked
FMSA33	Lenon	PSS Platinum Silver Gloss	NXW 7	NX Networked Wireless Radio Module NXRM2 and Bluetooth Programming, without Sensor	WBFM4	or FMSA33 Wall Bracket		Wireless Radi Integral Autom Dimming Phot
	fixture base Solo Arm Post Top Flus	VGT Verde Green Matte	WSP-40F-1 6,8	Dimming Occ. Sensor for up to 40 MH, 120/277/347V		Arm for FM44 or FMSA44		Integral Single Relay with Dir
	Mount 3.6" to 4.0" OD	WHS White Gloss Smooth WHT White Matte Textured	WSP-40F-2 6,8	Dimming Occ. Sensor for up to 40 MH. 208/240V	TAFM3 12,13	Twin Arm mount for FM33 or		and Bluetooth Programming
	3" Solo Arm Post Top Mount for 2-3/8" OD x	Color Option	WSP-40F-3 6,8	Dimming Occ. Sensor for up to 40 MH, 480V	TAFM4 12,13	FMSA33 Twin Arm		
PTSA24 4	Long Tenon  4" Solo Arm Post Top  Mount for 2-3/8" OD x	cc 5 Custom Color	NXWS16F 6,7,8	NX Networked Wireless Enabled Integral NXSMP2-LMO PIR		mount for FM44 or		
	Long Tenon	•		Occupancy Sensor with Automatic	;	FMSA44		
	4" Solo Arm Post Top	411		Dimming Photocell and Bluetooth Programming				
	Mount for 2-7/8" OD x	<del>!</del> "	NXWS40F 6,7,8	NX Networked Wireless Enabled Integral NXSMP2-HMO PIR				
				Occupancy Sensor with Automatic Dimming Photocell and Bluetooth				
				Programming				


1 Turtle Friendly. 2 Not available with 24L-65 and the 56L-140 configuration of the LED Engi 3 Not available with BC option 4 Not available with 5QM, 5QN, and 5W distributions. 5 Consult factory for custom color, marine and corrosive finish options. 6 Not available with other sensor or wireless control options. 7 Not available with Solo Arm Post Top (FMSA/PTSA)	8 24L and 56L only ne Not available with HDL option. 10 IK08 rated. Consult factory for details 11 Ik10 rated. Consult factory for details 12 Pole requires 2-3/8* 4* Long tenon 13 Order one for each pair of fixtures per pole.
currentlighting.com/kimlighting © 2024 HLI Solutions, Inc. All rights reserved. Information and specifications subject to change without notice. All values are design or typical values when measured under laboratory conditions.	Page 2 of 15 Rev 01/31/24 kl_ur20post_spec_R07

## TYPE E1

## **Vienna LED Tapelight Specifications**

Vienna is a high-end flexible tape light manufactured in Austria, Europe. Not only is it produced in

BEULUX

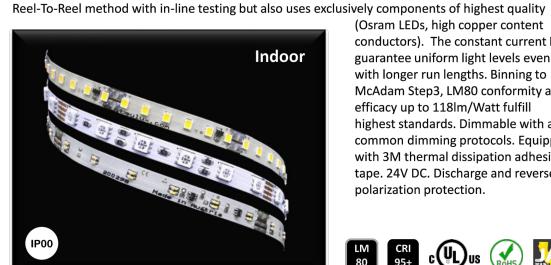

(Osram LEDs, high copper content conductors). The constant current ICs guarantee uniform light levels even with longer run lengths. Binning to McAdam Step3, LM80 conformity and efficacy up to 118lm/Watt fulfill highest standards. Dimmable with all common dimming protocols. Equipped with 3M thermal dissipation adhesive tape. 24V DC. Discharge and reverse polarization protection.

LM CRI CUL US ROHS TITTE 24

This hydrophobic, plasma-enhanced and super-thin coating enhances the durability of this tape light without the problems that Silicone or Polyurethane coatings bear. Applied under vacuum condition in condensation method.



■ Moisture resistance: water and many other organic substances have no effect on this coating ■ No light loss: same lumen output as the IP00 tape

No shift in color temperature: CCTs stay the same as with IP00 tape ■ No temperature increase: no heat build-up as in encapsulated products guarantees longer lifetime and quality stability

## 408-661-2367 TYPE E2 PROJECT: LITEISTRY

## **FEATURES**

**p**rescolite

LTR-4SQD


• 4" architectural LED downlight delivering 600 – 4000 lm Five beam distributions from 0.4 to 1.2 Spacing Criteria • Quiet reflector appearance with superior 50° optical cutoff 2700K - 5000K 80+ and 90+ CRI options Available in New Construction (non-IC), IC and Chicago Plenum applications

• Variety of dimming protocol options including 0–10V, DALI, DMX, and Lutron EcoSystem NX Lighting Controls wired and wireless controls







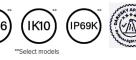



## **CONTROL TECHNOLOGY**

### CONTROLS **SPECIFICATIONS**

CONSTRUCTION Standard Non-IC. Chicago Plenum New Construction: Painted black durable steel platform with pre-installed bar hangers Pre-wired junction box with snap-on covers

for easy access Snap-in connection from driver compartment allows easy installation Light Engine connections use plenum rated

 Visually pleasing 50° cutoff to source and source image The light distribution is free of distracting bright spots or pixelation and the perimeter has a smooth transition Optical grade silicone lens integral to light engine High purity four-panel aluminum reflector. self-flanged

 Flush Mount flange option with mud-in ring available • Large selection of anodized finishes Painted cones and flange options available

ELECTRICAL Chip-on-board (COB) LED with 2 SDCM

 Multiple CCTs, 80+ or 90+ CRI Long LED life: L90 at >55,000 hours (TM-21) Universal voltage 120V–277V driver,

• UL Class 2, inherent short circuit and • Flicker free 0–10V dimming with 1% or < 1% performance

• DALI, DMX, and Lutron EcoSystem options NX or Lutron Vive control options available Integral and remote emergency controller and battery pack options available Refer to additional spec sheets for information on SpectraSync™ Tunable White or Dim-to-Warm solutions

above or below the ceiling

INSTALLATION Accommodates ceiling thicknesses (See DIMENSIONS section for details) Universal adjustable mounting brackets also accept ½" EMT conduit or 1½" or ¾" lathing channel (by others) or Prescolite accessory bar hangers (B24 or B6) Light Engine/Driver fully serviceable from

### CERTIFICATIONS cCSAus certified to UL 1598

Suitable for wet locations, covered ceiling. EM/EMR: Suitable for damp locations. Approved for 8 (4 in/4 out) No. 12AWG conductors rated for 90°C through wiring

· When used with CE Bezel Trim Accessories: IP66/IP69K rating; also meets IK10 per IEC 60068-2-75 impact testing EM/EMR: Certified under UL 924 standard for emergency lighting and power

 ENERGY STAR® certified models available (For list and additional information. visit www.energystar.gov) This product qualifies as a "designated" FAR 52,225-11 Buy American-Construction Materials under Trade Agreements

5 year warranty

effective 6/6/2020.

KEY DATA	1
Lumen Range	600–4000
Wattage Range	8–52
Efficacy Range (LPW)	89–99*
Life (Hours)	L90/>55,000
Input Current (mA)	67-433 (120V)
* Based on	Specular, 35K, 80 CR

Page **1** of **9** Rev 11/18/22 currentlighting.com/prescolite Current @ © 2022 HLI Solutions, Inc. All rights reserved. Information and specifications subject to change without notice. All values are design or typical values when measured under laboratory conditions LTR-4SQD\_R03

## TYPE E1

## **Vienna LED Tapelight Specifications**

BEULUX

## **Technical Information**

	Product	Output	LEDs/ft	Consump.	Efficacy	CRI	Voltage	Max run	Cut
		(~lm/ft)		(watt/ft)	(~lm/watt)			length	increment
	L90	~ 90	36	0.73	123	>80	24	75'	2"
Ī	L180	~ 180	36	1.62	111	>80	24	47'	2"
	L270	~ 270	36	2.7	108	>80	24	34'	2"
	L400	~ 400	36	3.9	109	>80	24	25'	2"
	L610	~ 610	36	6.2	104	>80	24	18'	2"
	L910	~ 910	36	9.7	104	>80	24	10'	2"

408-661-2367

PROJECT:

without Sensor 4

and Bluetooth

without Sensor⁴ Lutron Vive

0-10V (requires

0-10V driver)

Lutron Vive

EcoSystem, (requires EDM)

MD Medium (0.8 SC/46°)

**WD** Wide (1.0 SC/60°)

XW Extra Wide (1.2 SC/69°)

5000K available in 80+ CRI only

11 DTS available with DM1, DM01, or DALI.

12 VNR available up to 30L.

EDM available in 10L-35L, DMX not available on 40L.

AM available with WC or Specular Clear (S or SWT). Consult factory for other colors.

Flush Mount Flange (FM) requires FMR accessory (sold separately)

9 CP available up to 35L; not available with DMX, Controls, or EMR options

NX requires DM1 driver option
WT not needed for WC; BT not needed for BC.

= Service Program

STOCK QS

**EM** Emergency Battery

EMR Emergency Battery

Pack with remote

indicator light <sup>1</sup> GTD Generator Transfer

Device 1 DTS Device Transfer

F Fuse 1

Finish not applicable with

painted reflectors (WC or BC)

SS Semi-Specular

VS Softglow®

VSS SoftSheen™

Switch with

Dimming Bypass 1,11

Pack with integral test switch and indicator light 1

**Example:** LTR-4SQD-H-SL10L-DM1-LTR-4SQD-T-SL35K8MD-SS

RJ45 SmartPORTS, 120-277V IC IC rated 1,10

TYPE E2

**10L** 1000 **DM01** 0-10V Dimming to < 1%

dimming to < 0.1%

 SL
 Standard Lumen
 27K
 2700K
 8
 80+CRI
 VNR
 Very Narrow (0.4 SC/23°) 12

 ML
 Medium Lumen
 30K
 3000K
 9
 90+CRI
 NR
 Narrow (0.6 SC/37°)

Standard matches reflector color | EM | Pre-punched Reflector for | AM | Antimicrobial Coating

Integral Switch

FM Flush Mount Mud-in Ring 7

See next page for Bezel Trim Accessories for Complex Environments)<sup>13</sup>
13 See next page for option restrictions when using with bezel trim accessories

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**40K** 4000K

50K 5000K 2

HL High Lumen 35K 3500K

WT White Flange 5

Set of two (2) 24" bar hangers for T-bar ceilings

Flush Mount Flange Mud-In Ring, 4" Square

LiteGear® Inverter, 125VA-250VA

LightPower Micro-Inverter, 20VA-55VA

Set of two bar hangers for ceiling joist up to 24" centers

Metal Oversized Ring, 4" Square, White (8.25" outer dimension)

Metal Oversized Ring, 4" Square, Black (8.25" outer dimension)

EDM Lutron Hi-Lume

to 1% 3

15L 1500 DMX DMX with RDM

## **Tapelight Ordering Codes**

**Photometric** 

www.Beulux.com

prescolite

LTR-4SQD

ORDERING GUIDE

CATALOG #

ITR-4SQD-T

TRIM CONTINUED

CG Champagne Gold

WC Painted White Cone and Flange

BC Painted Black Cone and Flange

**BL** Black

PW Pewter

Accessories

B24

■ B6

FMR4-SQ

LPS Series

MOR4-SQ-WH

MOR4-SQ-BL

Current @

LW Light Wheat

Example: V-L400IP66CT27-4' (Vienna, ~400 lm/ft, Outdoor, 2700K, 4 ft)

	_						
PRODUCT LINE	+	0	UTPUT	+	IP	RATING	
<b>V</b> Vienna		L90	~ 90 lm/ft		IP00	Indoor	
		L180	~180 lm/ft		IP66	Outdoor	
		L270	~ 270 lm/ft				
		L400	~ 400 lm/ft				
		L610	~ 610 lm/ft				
		L910	~ 910 lm/ft				

+ COLOR TEMP CT22 2200k **CT27** 2700k CT30 3000k CT35 3500k CT40 4000k

RUN LENGTH Enter run length

3301 Lawrence St. Ste 2 Denver, CO 80205 P: 720.598.0774

ARCHITECT:

ROTH SHEPPARD ARCHITECTS LLP

Ramirez,

Johnson, &

**A**ssociates

CONSULTANT:

1900 WAZEE STREET, SUITE 100 | DENVER, COLORADO 80202

R

**ISSUANCE:** DATE: 24-08-20 MAJOR SITE PLAN

STAMP:

DRAWING TITLE: LIGHTING CUTSHEETS

Re: Case # PLN23-098

#### Kevin Hughes < kmhughes 300@gmail.com >

Wed 9/4/2024 10:25 AM

To:Shelia Booth <SBooth@PlanStrategize.com>

Cc:Michelle Franz <mfranz@allegiantmgmt.com>;Erica Fransen <erica@allegiantmgmt.com>;Linda Metsger <lmetsger33@gmail.com>;Kevin Hughes <kmhughes300@gmail.com>;Chris Eddy <chris\_eddy@hotmail.com>;Kaitlyn Eldridge <kaitlyn@alamocitymall.com>;Kathi Erber <kathi@erbergroup.com>;Krystyn Gay <krystyn@allegiantmgmt.com>;James Shockey <jshockey@wpgov.com>;Brian Kelly <bkelly@wpgov.com>;Lisa Hughes <lnoelh@gmail.com> Shelia.

Thanks, the information provided is most useful.

I am concerned over the overall parking situation as you stated the residential parking requirements have been reduced form 13 to 10 and the retail/restaurant is allocated for 8 spaces for a total of 18 spaces.

However, based on the proposed retail and restaurant split, the number of parking spaces required for the first floor is 17 spaces. Therefore, the site is short 12 spaces. I calculated the parking based on Section 3.9.3 Parking Requirements. My first floor parking calculations are below..

I am most concerned with customers, visitors and owners not finding a space to park in the development and parking in Winter Park Place's lot. This is an ongoing issue that we have at Winter Park Place with non residents parking is our lot and it will only get worse.

I also notice that the site has ZERO on site snow storage. Therefore, the available parking will likely be reduced during heavy snow falls as the site requires all snow to be hauled away,

How will the city or development enforce the parking restrictions knowing that the site is underparked?

Kevin Hughes 1080 Winter Park Place #22

	SNOW STORAGE (PER TABLE 3-H-5-1)
6,324	TOTAL PAVED AREA (SF)
1,581	TOTAL SNOW STORAGE AREA REQ'D (SF)
N/A	TOTAL SNOW STORAGE AREA PROVIDED (SF)
WILL	ON-SITESNOW STORAGE AREA INSUFFICIENT; THIS SITE
IG.	REQUIRE OFF-SITE HAULING AND/OR SNOW MELTING

(AVG. SLOPE WITHIN PARKING AREA = 2.0%)

Parking calculations:

Project Details: The planned building at the Project site is a three-story structure with two commercial units on the main level (1,362 sq. ft. retail space; 1,419 sq. ft. restaurant space with 1,000 sq. ft. outdoor patio) and nine residential units on the two floors above. There are a total of six (6) split level 2 bedroom/2.25 bath units and three (3) 1 bedroom/1 bath units. The residential units will be for-sale condominum units.

 $[(1,362 \times .80 \% / 400 = 3 \text{ spaces}) \& (1,419 / 100 = 14 \text{ spaces})]$ 

- Multi-family dwellings (including apartments and condominiums) with one (1) bedroom, one (1) space per dwelling unit
- (c) Multi-family dwellings (including apartments and condominiums) with two (2)

26

bedrooms, one and one half (1 1/2) spaces per dwelling unit.

- Multi-family dwellings (including apartments and condominiums) with three (3) (d) bedrooms or more, two (2) spaces per dwelling unit.
- Dormitories, bunkhouses and similar group sleeping quarters, one (1) space for (e) every three (3) beds.
- Hotels, motels, lodges, studio units, three spaces for every four (4) units. (f)
- (g) Rest homes, hospitals, sanitariums, one (1) space per bed.
- (h) Offices (professional, non-professional, including real estate, condominium rental offices), one (1) space for each four hundred (400) square feet of gross floor area.
- Eating and drinking establishments, one (1) space for each one hundred (100) (i) square feet of gross floor area.
- Retail sales one (1) space for every four hundred (400) square feet of gross (j) floor area excluding areas devoted exclusively to storage and building maintenance.

On Tue, Sep 3, 2024 at 4:49 PM Shelia Booth < SBooth@planstrategize.com > wrote: Good Afternoon Mr. Hughes -

Below is a link to the active cases page of the Town's website. My apologies that this case was not previously listed on it. You can view all the documents associated with the application on this page.

In addition, here are answers to your questions.

- Is a proposed How many bedrooms What is the
   How many parking spaces are proposed? The site plan does each of the 9 residential units have?the 1,750 SF available to review? - Yes, Six 2-bedroom, commercial please view 2.25-bath and space? **Retail** the three 1-bedroom, and 1-bath units.
- proposed mix of Town of Winter Park Board of Adjustment approved a reduction in required off street parking for the residential units from 13 spaces to 10 off-street parking spaces. The commercial parking will be met with 8 onstreet parking spaces.

documents HERE.

restaurant at this time.

Shelia Booth, AICP

Director of CDS | CPS LLC

719-839-5807 | www.PlanStrategize.com

From: Kevin Hughes < <a href="mailto:kmhughes300@gmail.com">kent: Tuesday, September 3, 2024 9:01 AM</a>
To: Shelia Booth < SBooth@PlanStrategize.com>

Subject: Case # PLN23-098

Shelia,

I have a few questions about the upcoming planning commission meeting concerning case # PLN23-098 at Lot A Block 3 Winter Park Village.

Is a proposed site plan available to review?

How many bedrooms does each of the 9 residential units have?

What is the proposed mix of the 1,750 SF commercial space?

How many parking spaces are proposed?

Thanks,

Kevin M Hughes 1080 Winter Park Dr #22